

STRUCTURAL DRAWING SHEET FOR
RESIDENTIAL APPARTMENT

KIP SOUMYA



STRUCTURAL DESIGN & DRAWING REPORT
REVISION-0

DOCUMENT NO:- FK/D/22/055
DATE:- 07-05-2022

STRUCTURAL / ARCHITECTURAL CONSULTANT

FLOORKART.IN

A UNIT OF APS DESIGN INFRA PVT. LTD

(ARCHITECTS, DESIGNERS, ENGINEERS, SURVEYORS & CONSULTANTS)

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RESIDENTIAL APPARTMENT AT BHUBANESWAR

STRUCTURAL DRAWING SHEET

DEVELOPER:-



M/S KUSHMANDA INFRA PROJECTS

Address:- BHUBANESWAR

K.I.P Soumya





WISH MESSAGE FROM TEAM

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When you take the time to express your heartfelt appreciation for something we have done, it boosts our spirit, passion, and purpose. It builds our self-confidence, self-esteem and our entire self-image. It gives us energy and motivation to work harder and do more.

We stand out by offering a holistic approach to the design of your project; ensuring your design aspirations are perfectly suited to your project environment.

Thank you for your support. We truly appreciate your business and look forward to serving you again.

With Regards
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GENERAL

❖ Scope

The scope of this Report is to highlight the analysis and design philosophy, project details, scope of work, description of site, foundation parameters/geotechnical parameters, Loads and Load combination adopted for the design of building at, BBSR.

❖ Codes & Standards

All design work will be based on Indian Standards (IS) codes (latest revisions), with amendments, if any, as on date. The design is carried out in conformity with following IS code latest editions. IS: 456 -2000 – Code of practice for plain and reinforced concrete

IS: 3370 (Part-1)-2009 – Concrete Structures for Storage of Liquids –Code of Practice Part-1

General Requirements

IS: 3370 (Part-2)-2009 – Concrete Structures for Storage of Liquids –Code of Practice Part-2

Reinforced Concrete Structures

IS: 3370 (Part-4)-1967 – Concrete Structures for Storage of Liquids –Code of Practice Part-4 Design

Tables

IS: 875 -1987 - Code of practice for Design Loads for Building and Structures-(Part-1 to 5)

IS: 1893-2016 (part 1) - Criteria for Earthquake Resistant design of structures for General Provisions of buildings

IS: 1893-2014 (part 1) - Criteria for Earthquake Resistant design of structures of Liquid Retaining

Tanks

SP 16 – Design Aids for Reinforced Concrete.

SP: 34 - Handbook on Concrete Reinforcement and Detailing.

❖ **Units of measurements**

All units used in the analysis and designs are in SI system unless noted otherwise.

❖ **Book Refered**

- Design Of Reinforced Concrete Structures By P Dayaratnam.
- Plain And Reinforced Concrete By Jai Krishana & Op Jain
- Design Of Reinforced Concrete Bc Punmia

➤ **SITE CONDITIONS**

❖ **Design Ground Elevation**

Finished Ground level (FGL) is decided for various areas contour/spot levels for the respective areas.

❖ **Soil Data**

The safe bearing capacity and ground water table will be considered as per soil investigation report of respective plot/site.

➤ **MATERIALS**

❖ **Cement**

Ordinary Portland cement of 43 grade conforming to latest IS codes and minimum cement content for RCC M30 grade will be 320 kg/m³

❖ **Plain cement concrete**

The Plain cement concrete under all RCC foundation will be of grade M10 of 150 mm thick and 150 mm projection.

❖ **Reinforced Concrete**

Concrete Grade of M30 is considered for tank and M25 for all elements of the ESR.

❖ **Reinforcement bars**

Reinforcement bars will be High yield strength deformed bars Fe 500 TMT confirming to IS: 1786-2008.

➤ **STRUCTURAL ANALYSIS**

❖ **Basic Loads**

The structures are analyzed for the following loads

❖ **Dead load**

Dead load comprises of the self-weight of all the permanent structural components including walls, floors, columns, roofs, etc., as applicable to individual structures.

The dead load of water proofing and floor finish has been considered as part of dead load.

❖ **Imposed Load/Live load**

On Top Dome and Balcony

= 1.5 kN/m²

On Bottom Balcony and Staircase

= 3.0 kN/m²

❖ Wind Load

Various design parameters for calculation of wind loads on structures will be determined on the basis of IS: 875 2016 (Part III). The wind shall be assumed to blow in any direction and most unfavorable condition shall be considered. Following parameters shall be considered for the wind load calculation.

Basic wind speed = 50 m/sec

Risk coefficient (k_1) = 1

Terrain category for (k_2) factor = Category-
2

Topography factor (k_3) = 1.0

Importance factor for cyclonic region (k_4) = 1

Seismic Load

All the structures will be designed for seismic forces using provisions of IS: 1893 (Part -I) – 2016 and IS: 1893 (Part-II) - 2014.

The design horizontal seismic coefficient A_h for the structure will be determine using the following expression

$$A_h = [(Z/2) (I/R) (S_a/g)]$$

Seismic zone = III

Zone Factor (Z) = 0.16

Response reduction factor R = 2.5

Importance factor, I = 1.5

Damping = 5%

Note:

DL: Dead Load

LL: Live Load

HYD-T: Hydro-test Water Load

WOR: Working Water Load

WDL: Wind Load

SXF: Seismic load when tank is Full

SXE: Seismic load when tank is Empty

➤ DESIGN METHODOLOGY

❖ Design Philosophy

The structure is analyzed using manual calculation. Cylindrical Walls, Top dome, Conical Slab, Bottom dome and Ring beams are designed using Spread sheets as un-cracked sections as per IS: 3370 (Part

2). However, staging columns are designed by limit state method, Tie beams, plinth beams and foundation is designed using limit state method as per IS: 456-2000.

❖ Foundation

Foundation for all structures shall be decided based on loading arrangement, load intensity and soil strata. Design of foundation at various levels shall be dependent upon the safe bearing capacity at that level and on the basis of recommendation furnished in the Geotechnical Investigation report.

Design forces are obtained from manual analysis and checked for bearing capacity, overturning and sliding. 25% increase in Allowable Base pressure is considered for wind/seismic load combinations. The foundation are designed as per limit state method as per IS: 456:2000

5.3 Stability

Structures will also be checked for any combination of full & empty compartments, with appropriate ground / uplift pressure (if any). Refer design calculation.

Factor of safety

Against Sliding

Against overturning

Restoring moment

➤ **Minimum cover to reinforcement**

Minimum clear cover to main reinforcement is as follows

Sl.no.	Member	Details	Cover(mm)
1	Slab(Roof & Floor, Staircase) etc.	Water face	45
		Free face	30
2	Beam	Water face	45
		Free face	30
3	Column and pedestal	All faces	40
4	Wall	Free face	30
		Water face	45
5	Footings, rafts	Top & Bottom	50

Building Construction Process Two Main Parts Divided as Below.

- Sub Building Construction Steps with Main Building Construction

1. Pre-construction Steps

In this building construction process first step. This per construction possesses some points like plot hiring, planting, budget, consult hiring, contractor, Design process, etc.

a. Acquire Land




It is the main step in building construction. Search for the location for the building, which is most appropriate for building construction purposes. Be careful while selecting land that has all the desired facilities available nearby and should be free from all land-related issues.

b. Seek Technical/Consultant



- After selecting proper land for building, seek the help / constantan of a professional architect to create building designs, and take advice.
- An architect prepare plan according to building requirement, a number of flats, shops based on your requirements also budget.
- Then after architect consult with a structural engineer and MEP engineer for details of the reinforcements and other detail for use, how deep your foundation will be, the size of gravel to be used, column width, electrical, plumbing, etc.

c. Design Process

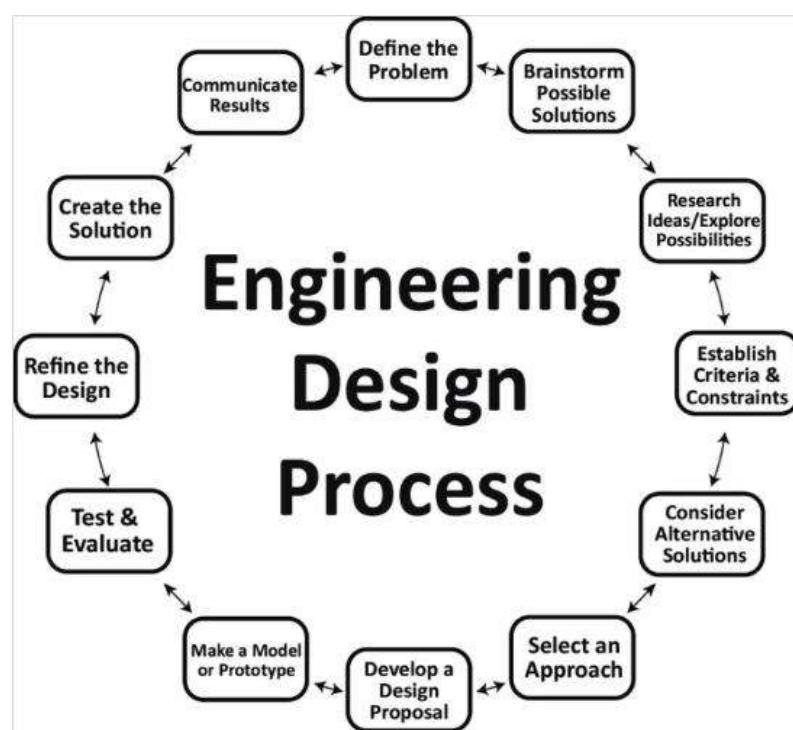


- Before finding/meeting up with an architect, make a rough requirement list for your home. This process must cover the basic concepts of your

home, like living space, no: of bedrooms you would like, Guest bedrooms, hall, kitchen, Baths, where you want the stairs, car porch, Garden/landscaping/Pond, etc.

- You should involve your family also, ask their likes and suggestions. Visit your friends, talk to neighbours about the pros and cons of their property, and what they would like to improve. Stages of work in a glance.

d. Prepare Estimation and Budgets

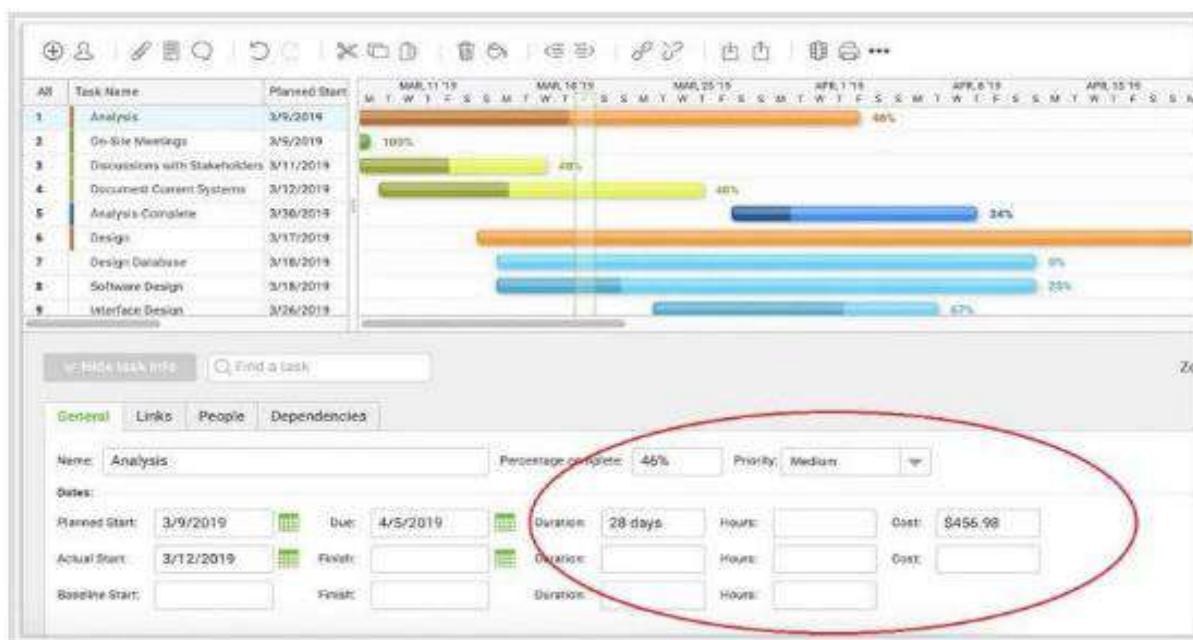

- Building construction involves a huge quantity of material and budget. After planning and structural detailing finished, these details are transferred into the building estimator.
- The building estimation will estimate the material quantity, quantity of different items of works, and prepare an abstract sheet that shows the cost of building construction.
- If financial resources are limited, we will need to seek pre-approval for loans in advance, or else you might end up in a cash crunch situation.

e. Building Permits



- This is important work to do after the project is ready to be executed. For that, we must take permission from different boards before you can go for the construction, like this municipal, airport authority, pollution control, etc.
- Following are the list of document project required before applying for permission. This document may differ from state to state, but a few are essential for every building construction work.
 1. Land Survey
 2. Soil test report (SBC report)
 3. All drawing like Plan, Elevation, Section
 4. Structural Certificate
 5. Architect Certificate

f. Approach a Contractor



- A contractor for construction needs to be chosen carefully because it's a major factor for securing building construction quality and timely construction of work.
- Pre investigation has to be done about the builder before handing work. From the contract document, all of the work-related details must be clearly stated.
- The contract document must cover layout and work details along with the cost payment methods and time scales. The condition of the contract ought to be thoroughly checked before signing a final deal.

g. Building Warranty Period

- Once the project is complete and handover into the owner, the contractor specifies a warranty period.
- In this period, any defects found in the building constructed have to be fixed and replaced with the contractor in charge.
- The warranty for appliances and materials are obtained from manufacturers and supplier.

Note

Construction Process

The '**construction process**' (sometimes called the '**construction stage**') is the physical **processes** of building, landscaping or refurbishing plus all the associated activities, such as demolition, site clearance, administration and so on. The following **processes** can form part of the **construction process**.

Pre-construction Steps

1. Testing quality of building materials
2. Site verification with reference to drawings
3. Sources of water and location of storage tank
4. Soil classification from trial pit
5. Mark the layout of main building
6. Material stacking plan
7. Verification of all the drawings and designs
8. Anti-termite treatment

During Building Construction Steps

Site Clearance, Excavation, Foundation, Plinth Beam or Slab, Superstructure Column and Beam, Brick Masonry Work, Lintel Over Door Window, Floor Slab or Roof Structure, Plastering, Door and Window Framing and Fixations, Painting, Electrical and Plumbing, Exterior Finishing, Internal Finishes, Woodwork and Fixture Fittings, Boundary Wall and Gates, Hardscaping and Landscaping, Punch List, Warranty Period

Process of Building Construction

- Prepare Construction Site and Pour Foundation.
- Complete Rough **Framing**.
- Complete Rough Plumbing, Electrical HVAC.
- Install Insulation.
- Complete Drywall and Interior Fixtures, Start Exterior Finishes.
- Finish Interior Trim, Install Exterior Walkways and Driveway.




Building Construction Process from Start to Finish

1. Pre-construction Steps

- Acquire Land
- Seek Technical/Consultant
- Design Process
- Prepare Estimation and Budgets
- Building Permits
- Approach a Contractor
- Building Warranty Period


2. During Building Construction Steps

- Site Clearance
- Excavation
- Foundation
- Plinth Beam or Slab
- Superstructure Column and Beam
- Brick Masonry Work.
- Lintel Over Door Window.
- Floor Slab or Roof Structure
- Plastering
- Door and Window Framing and Fixations.
- Painting
- Electrical and Plumbing
- Exterior Finishing
- Internal Finishes
- Woodwork and Fixture Fittings
- Boundary Wall and Gates
- Hardscaping and Landscaping
- Punch List
- Warranty Period

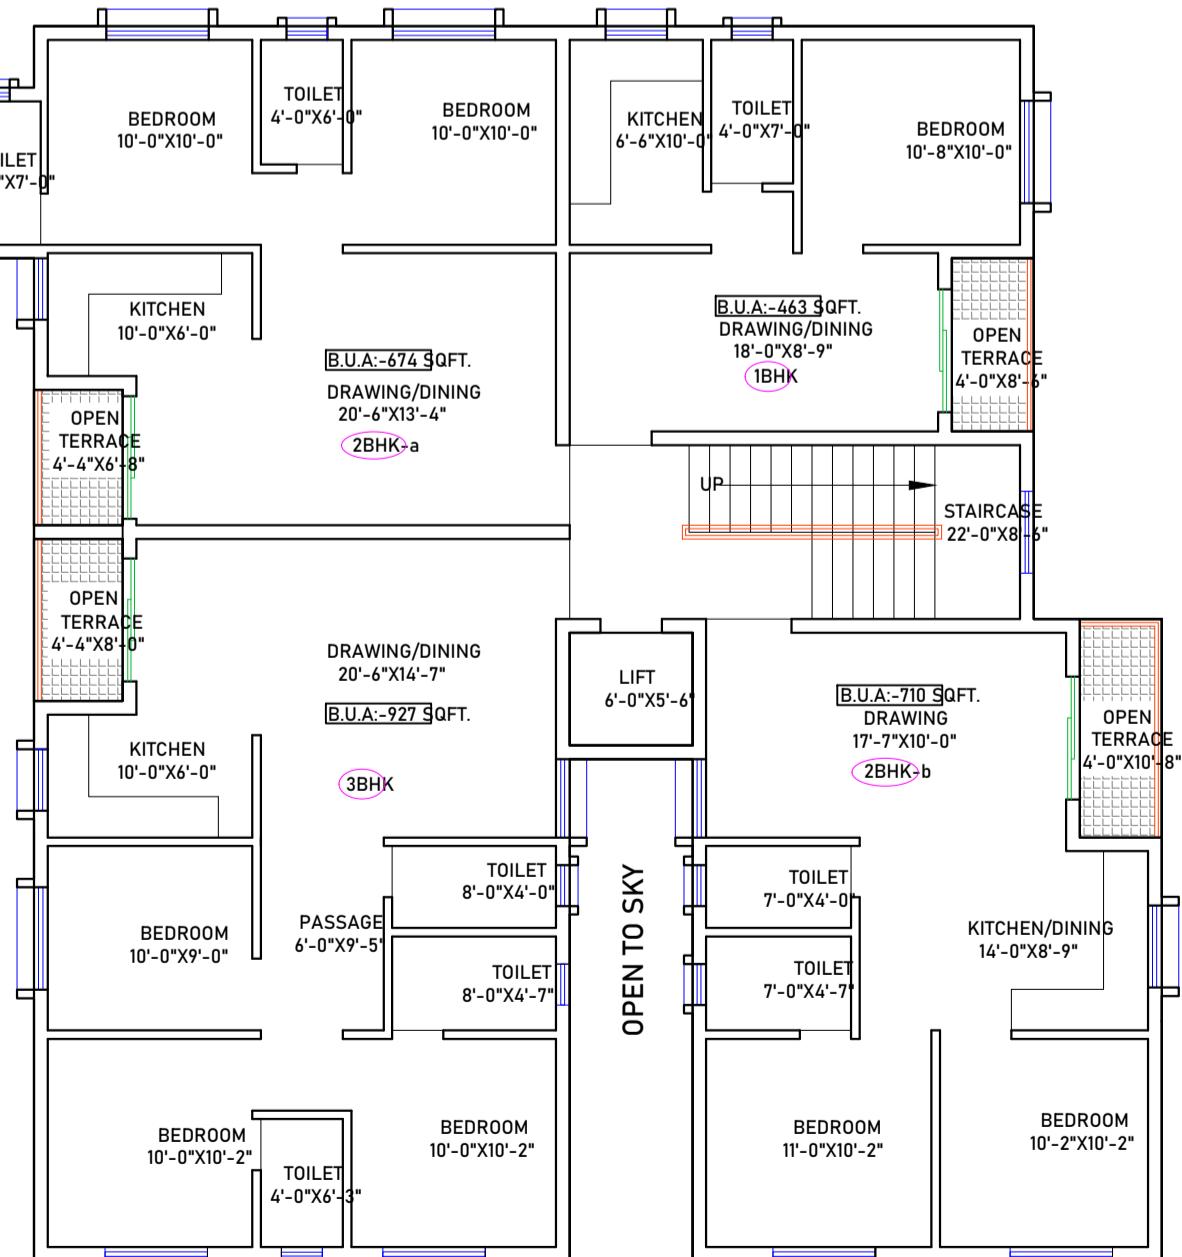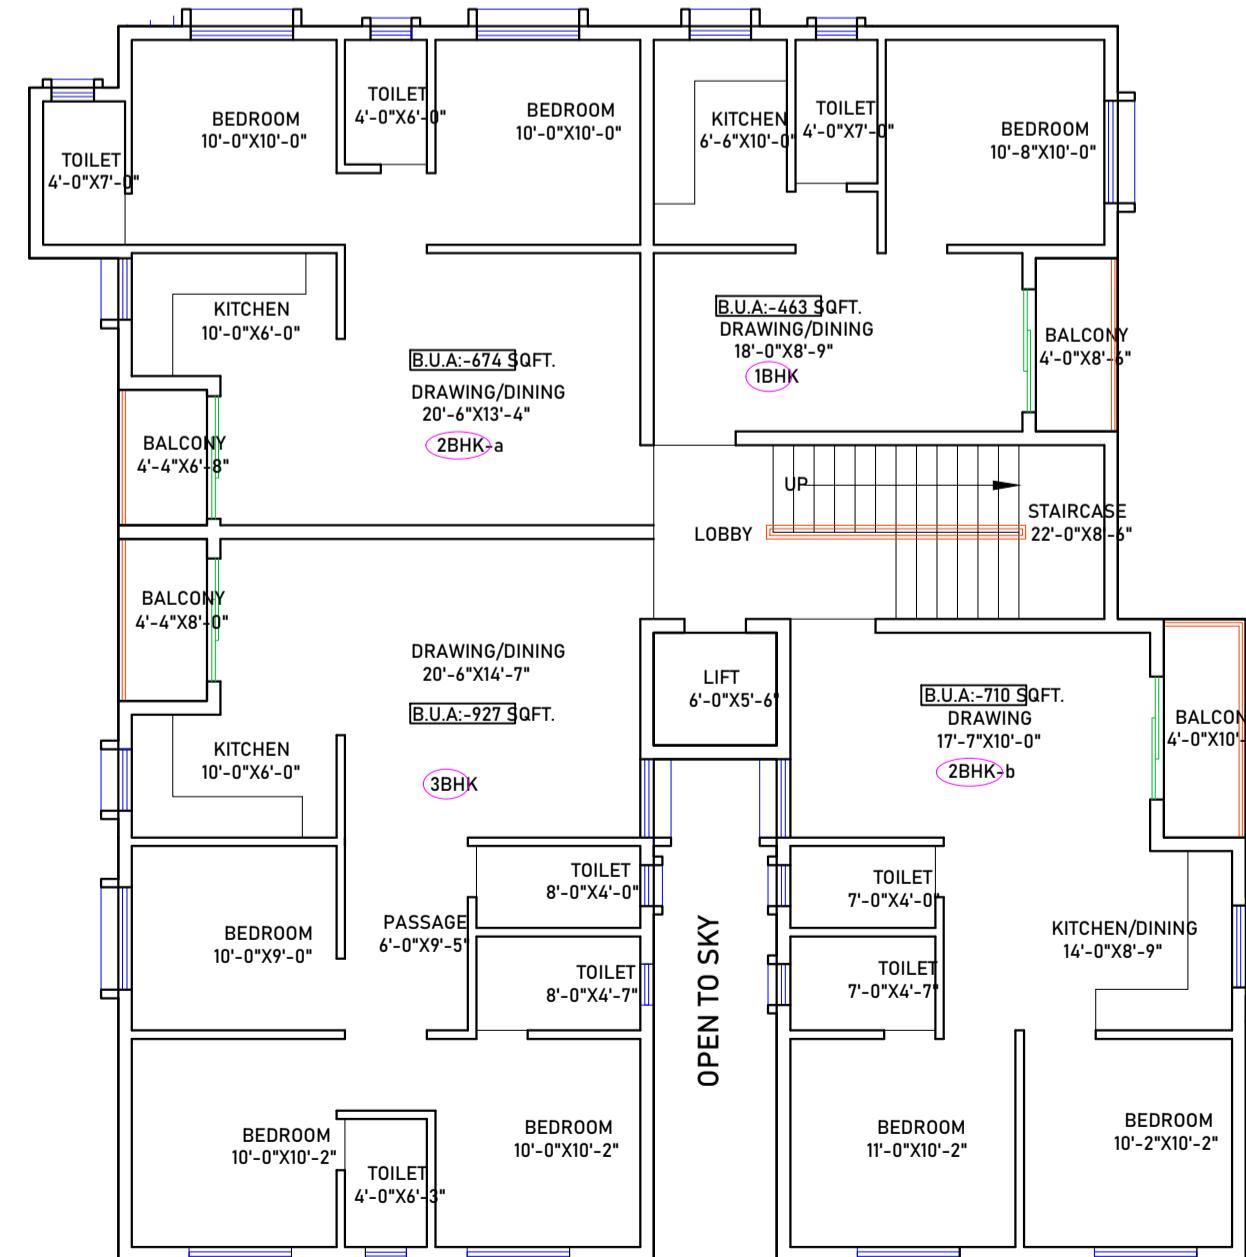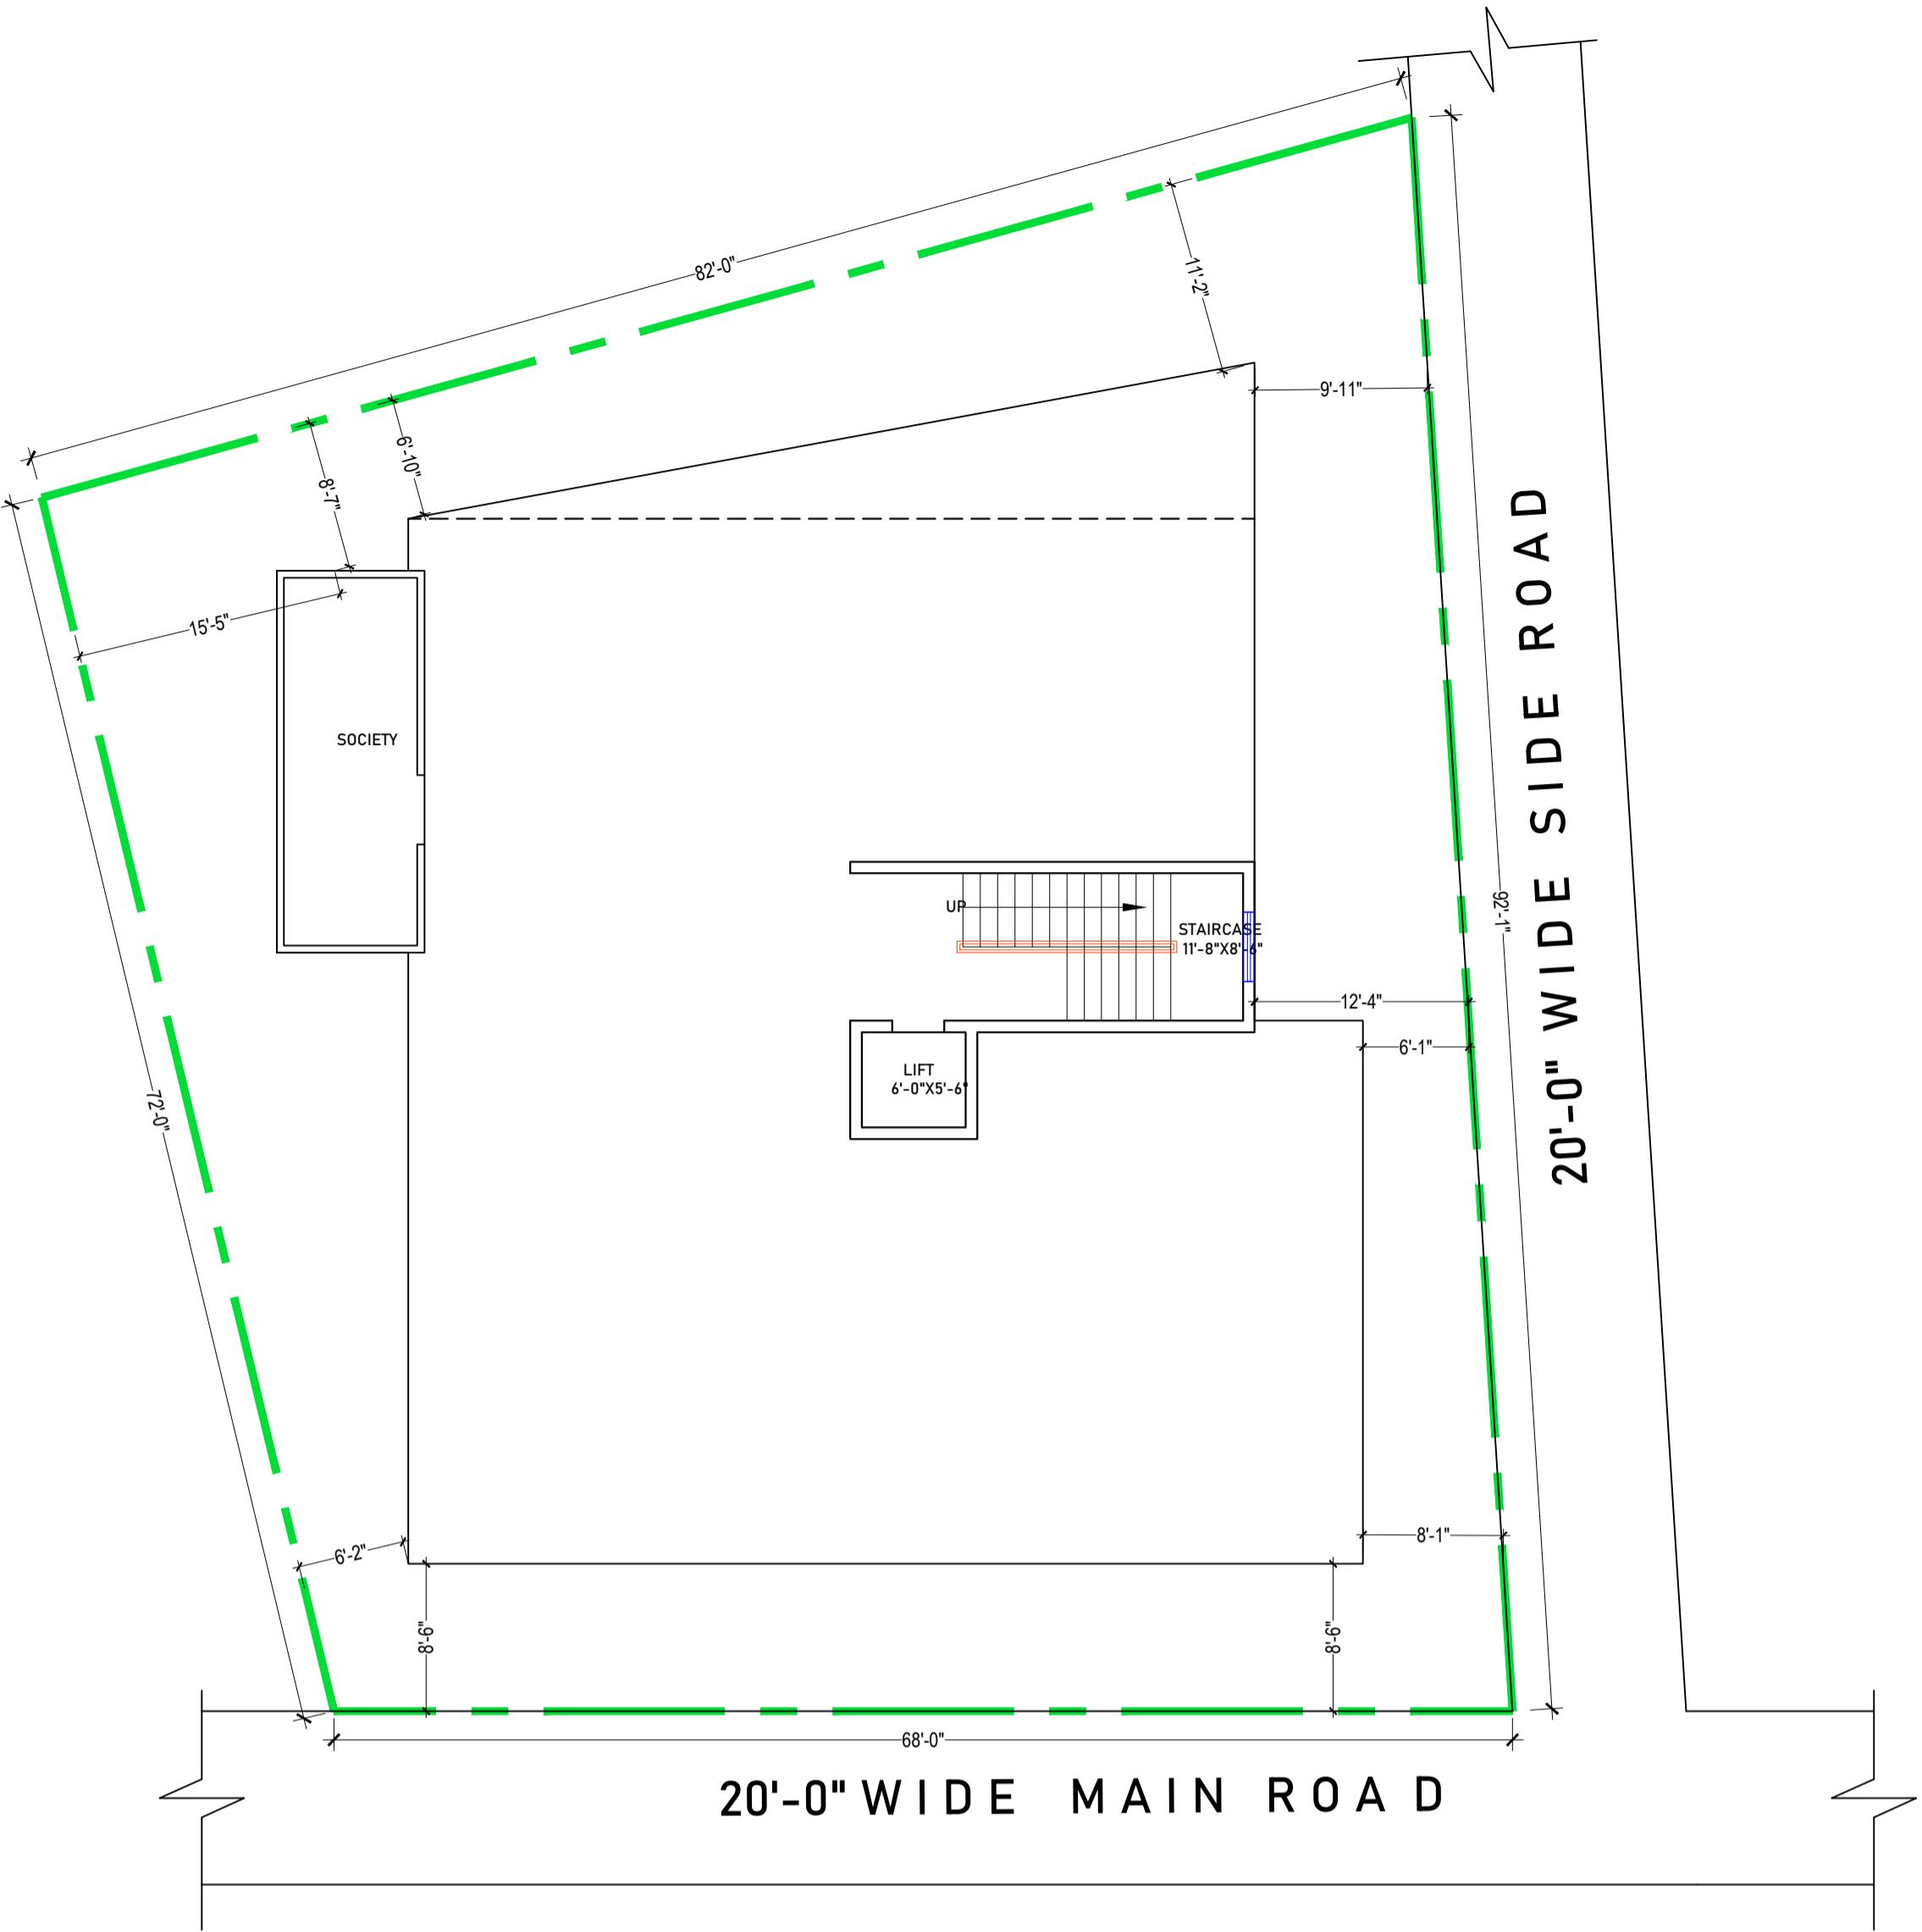

FLOOR PLAN

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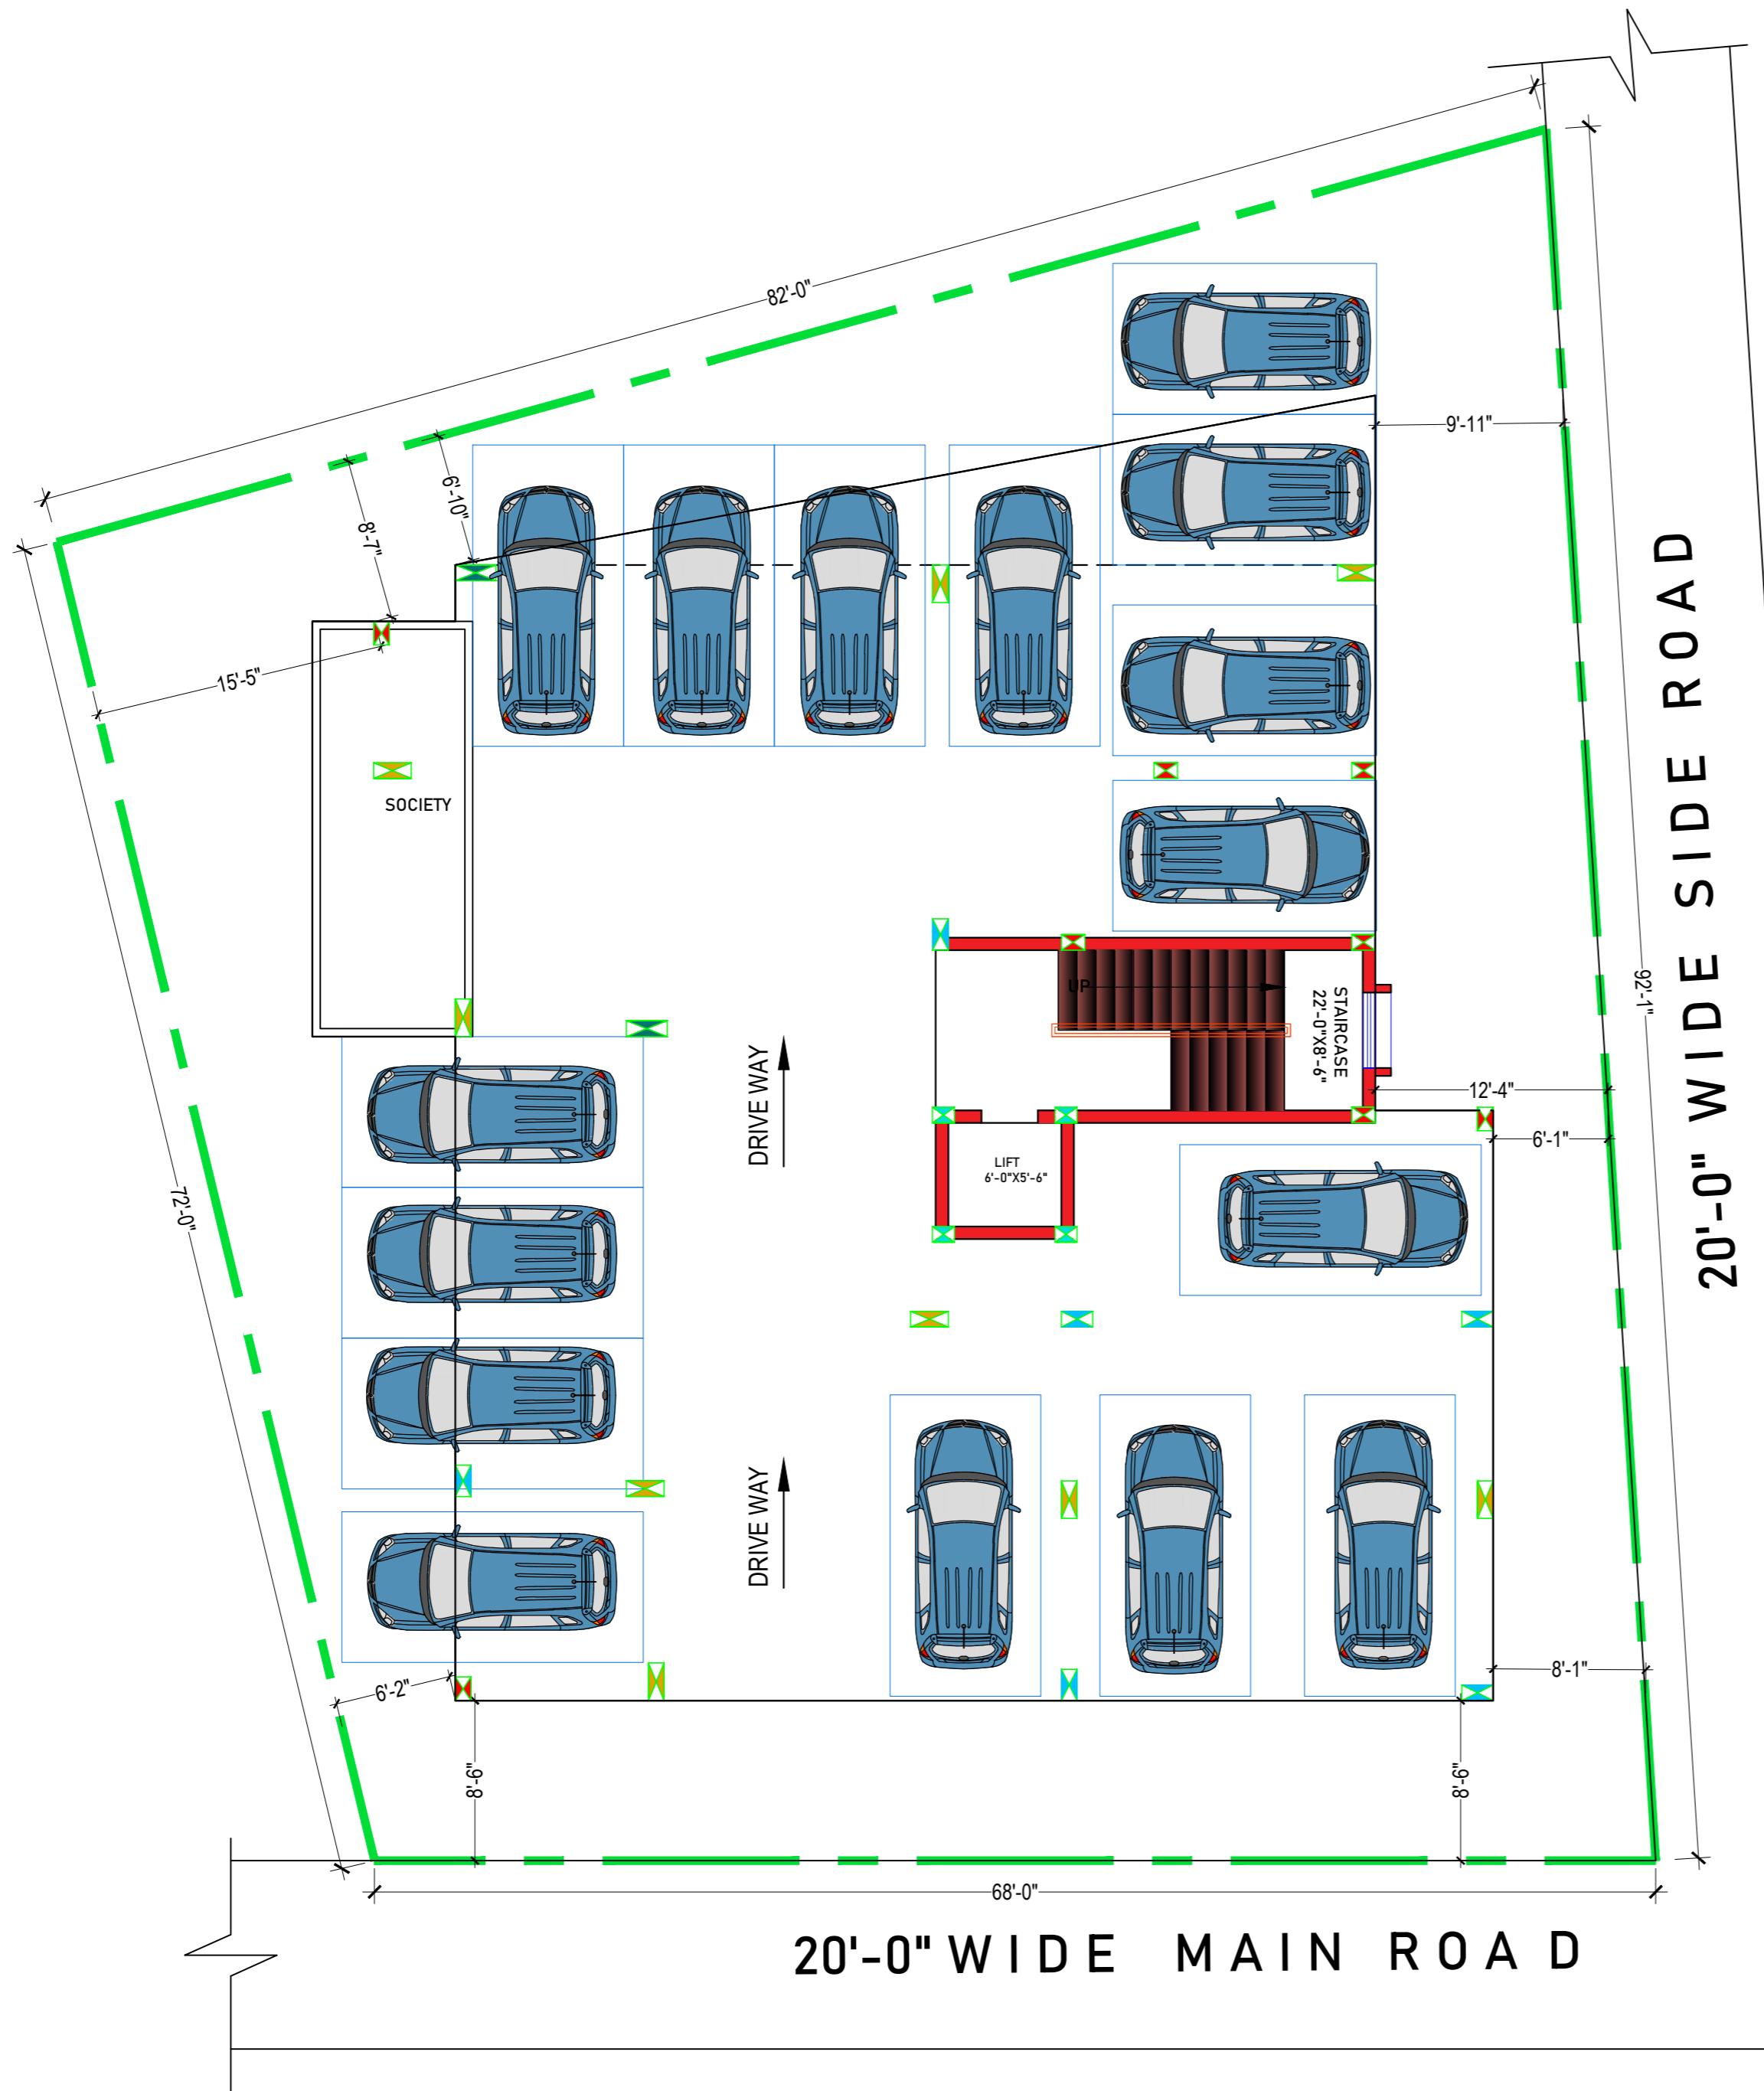
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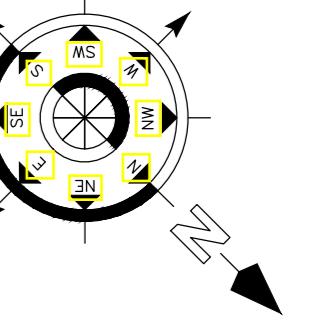
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STILT FLOOR PLAN

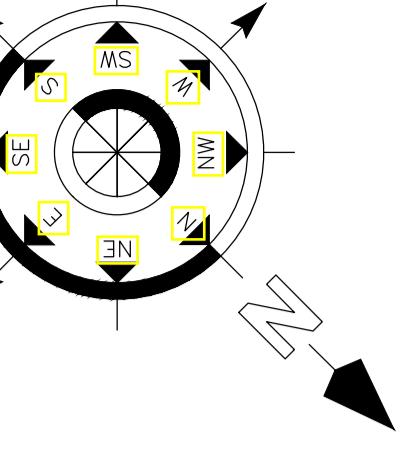FURNITURE LAY OUT PLAN

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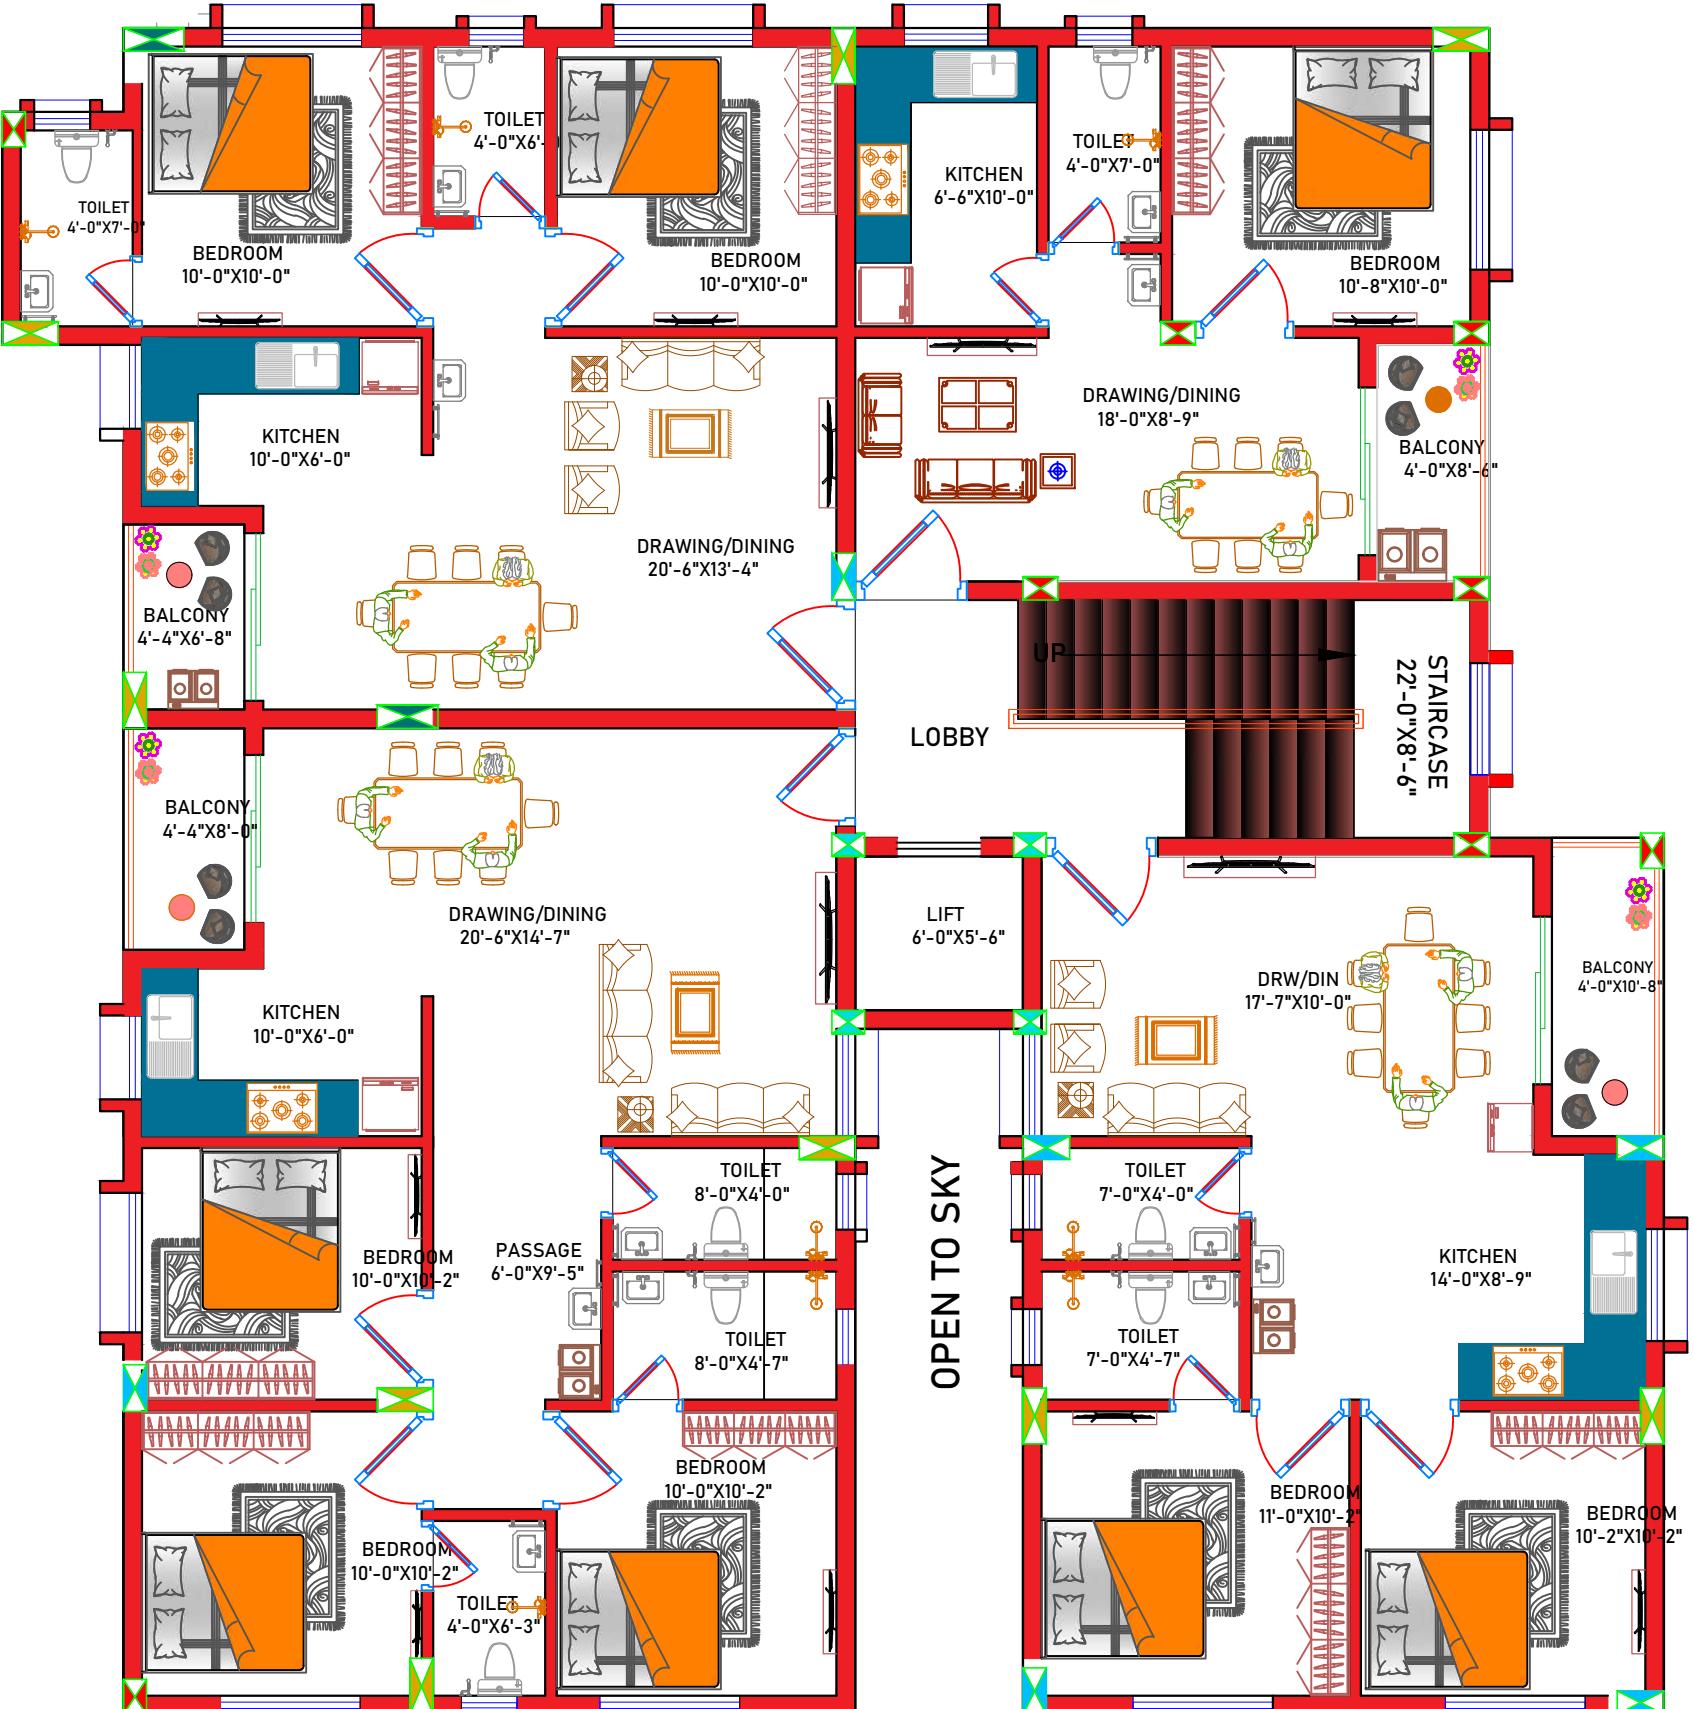
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2ND & 3RD FLOOR PLAN

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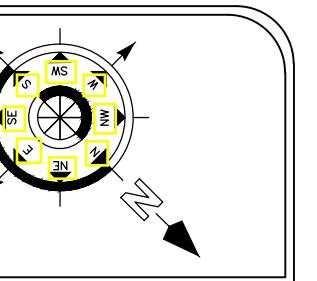
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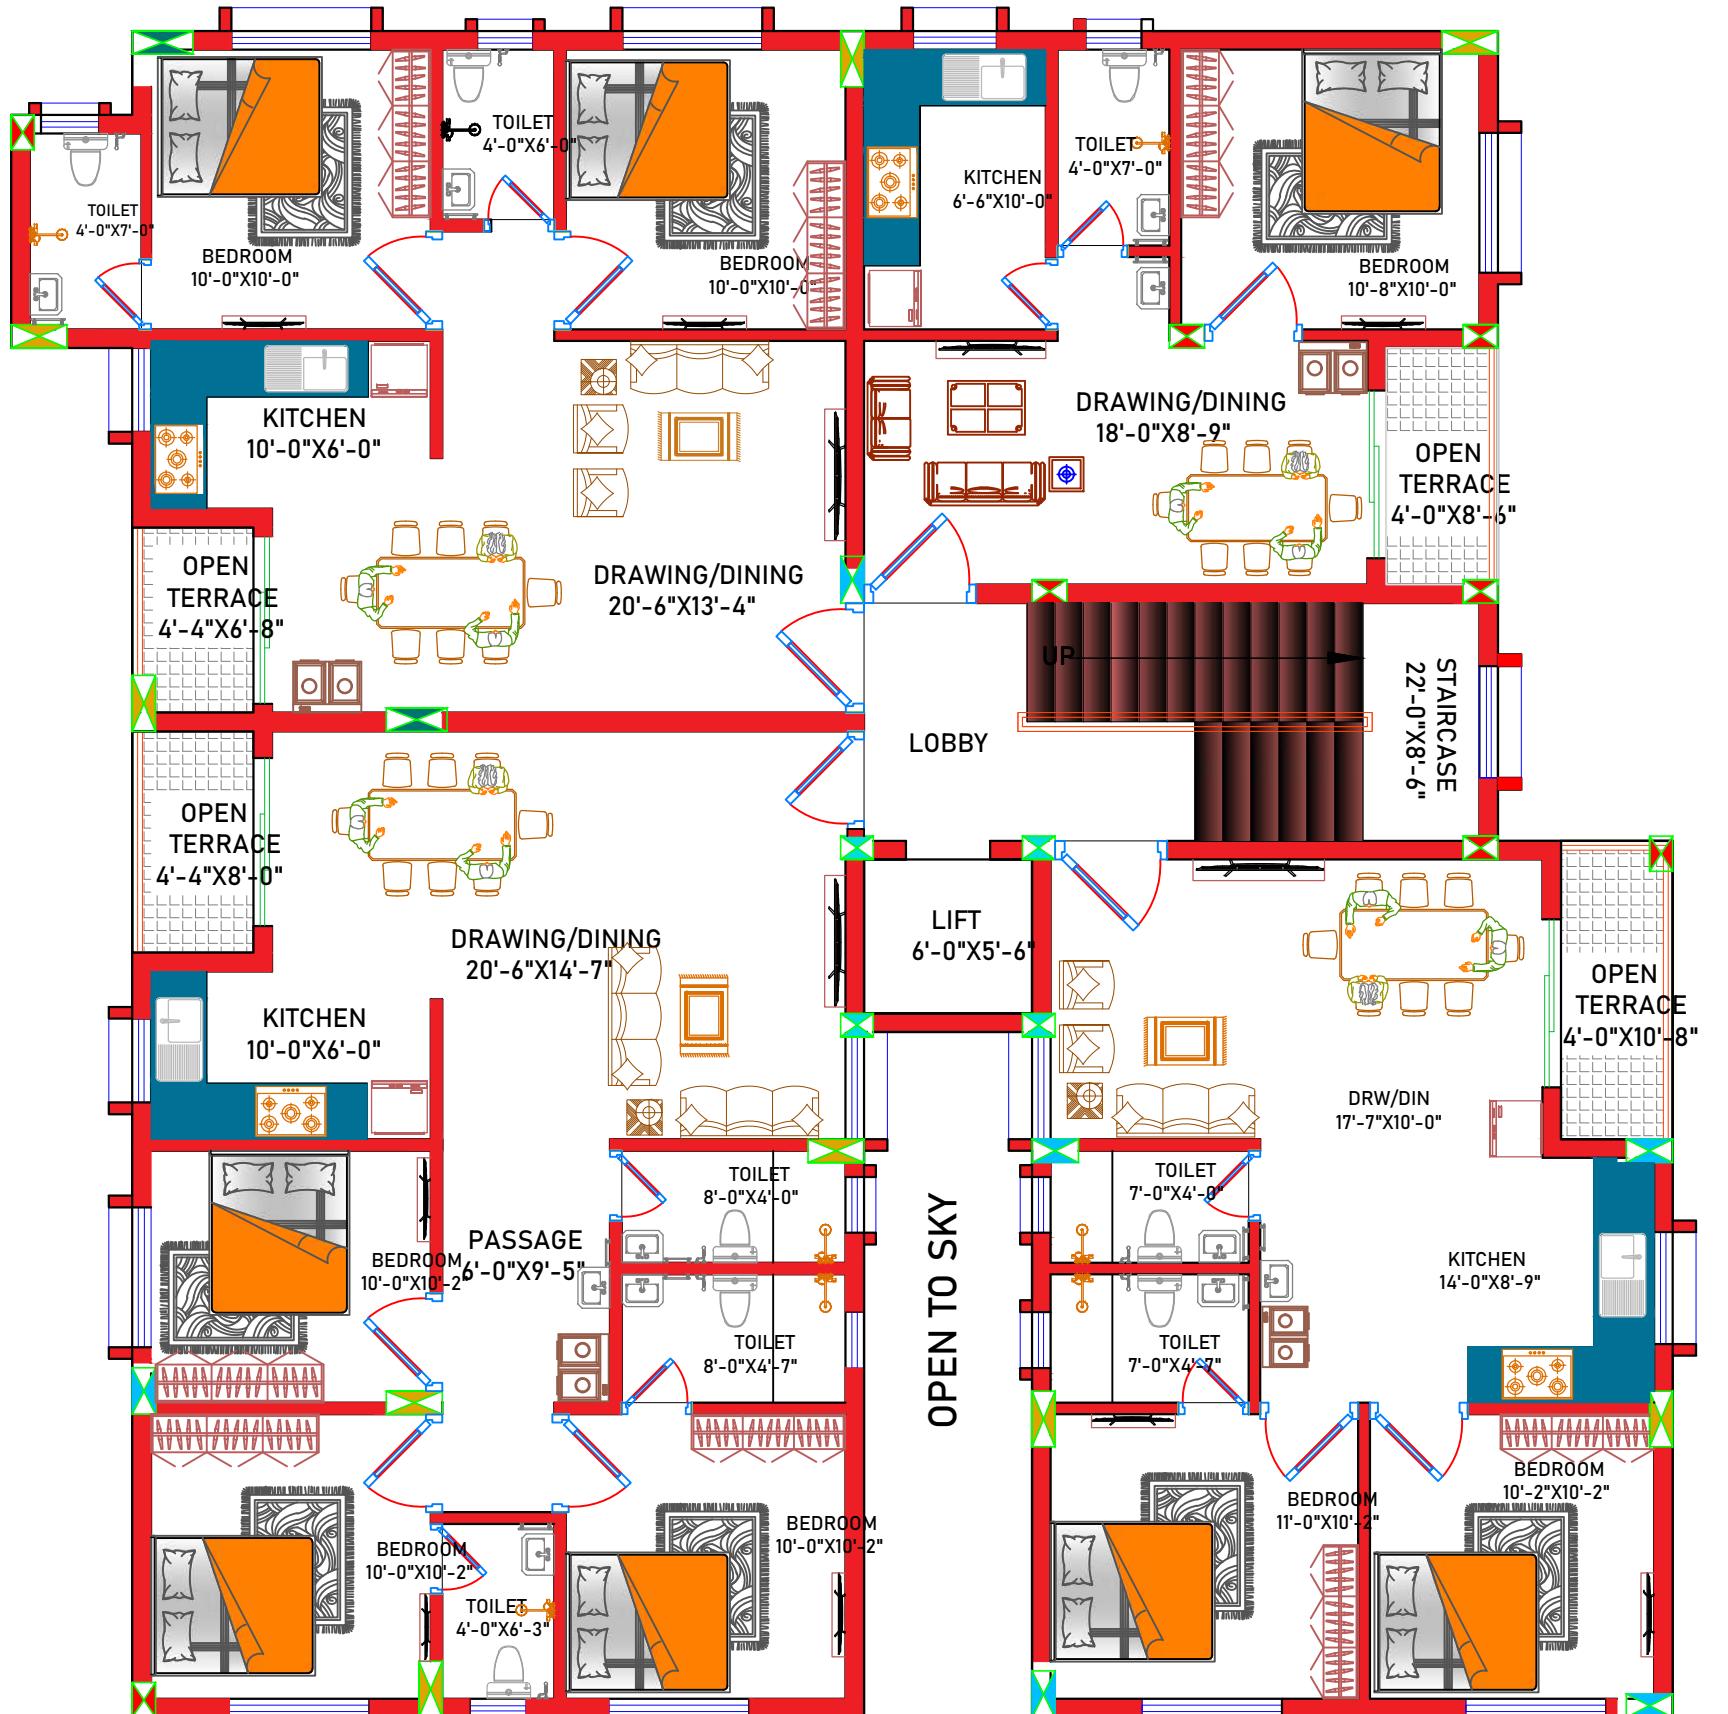
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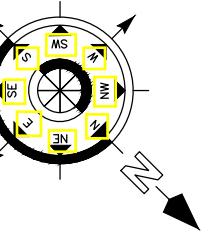




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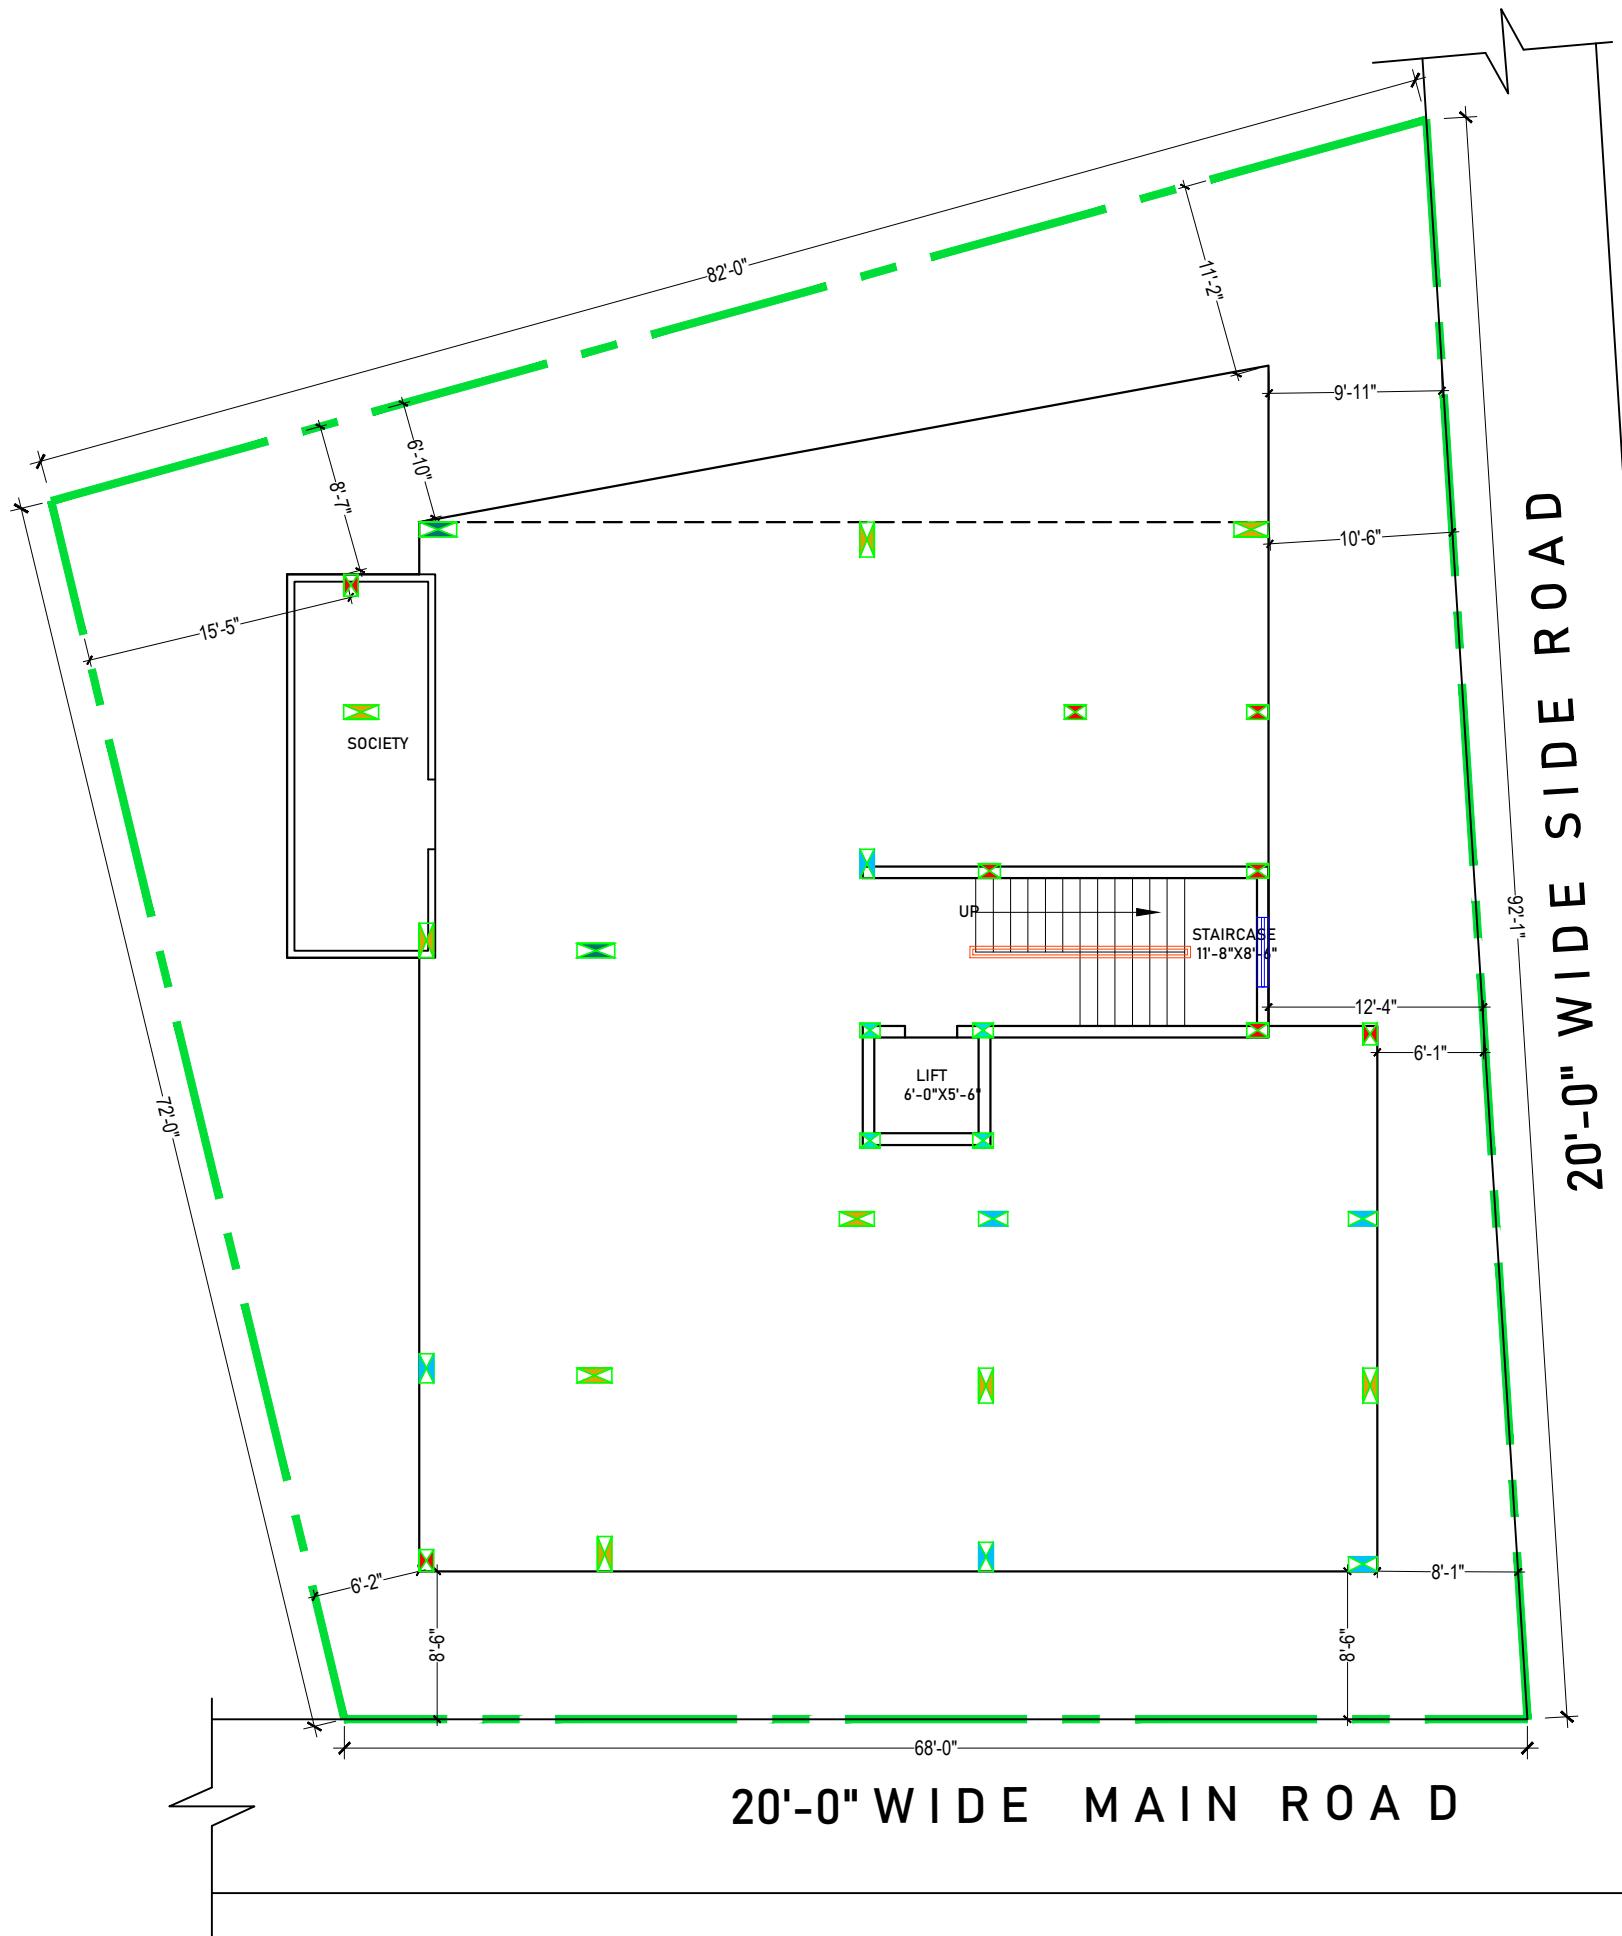
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**4TH FLOOR
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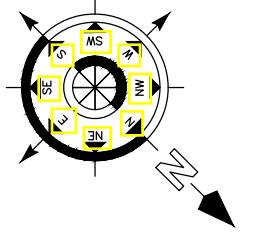


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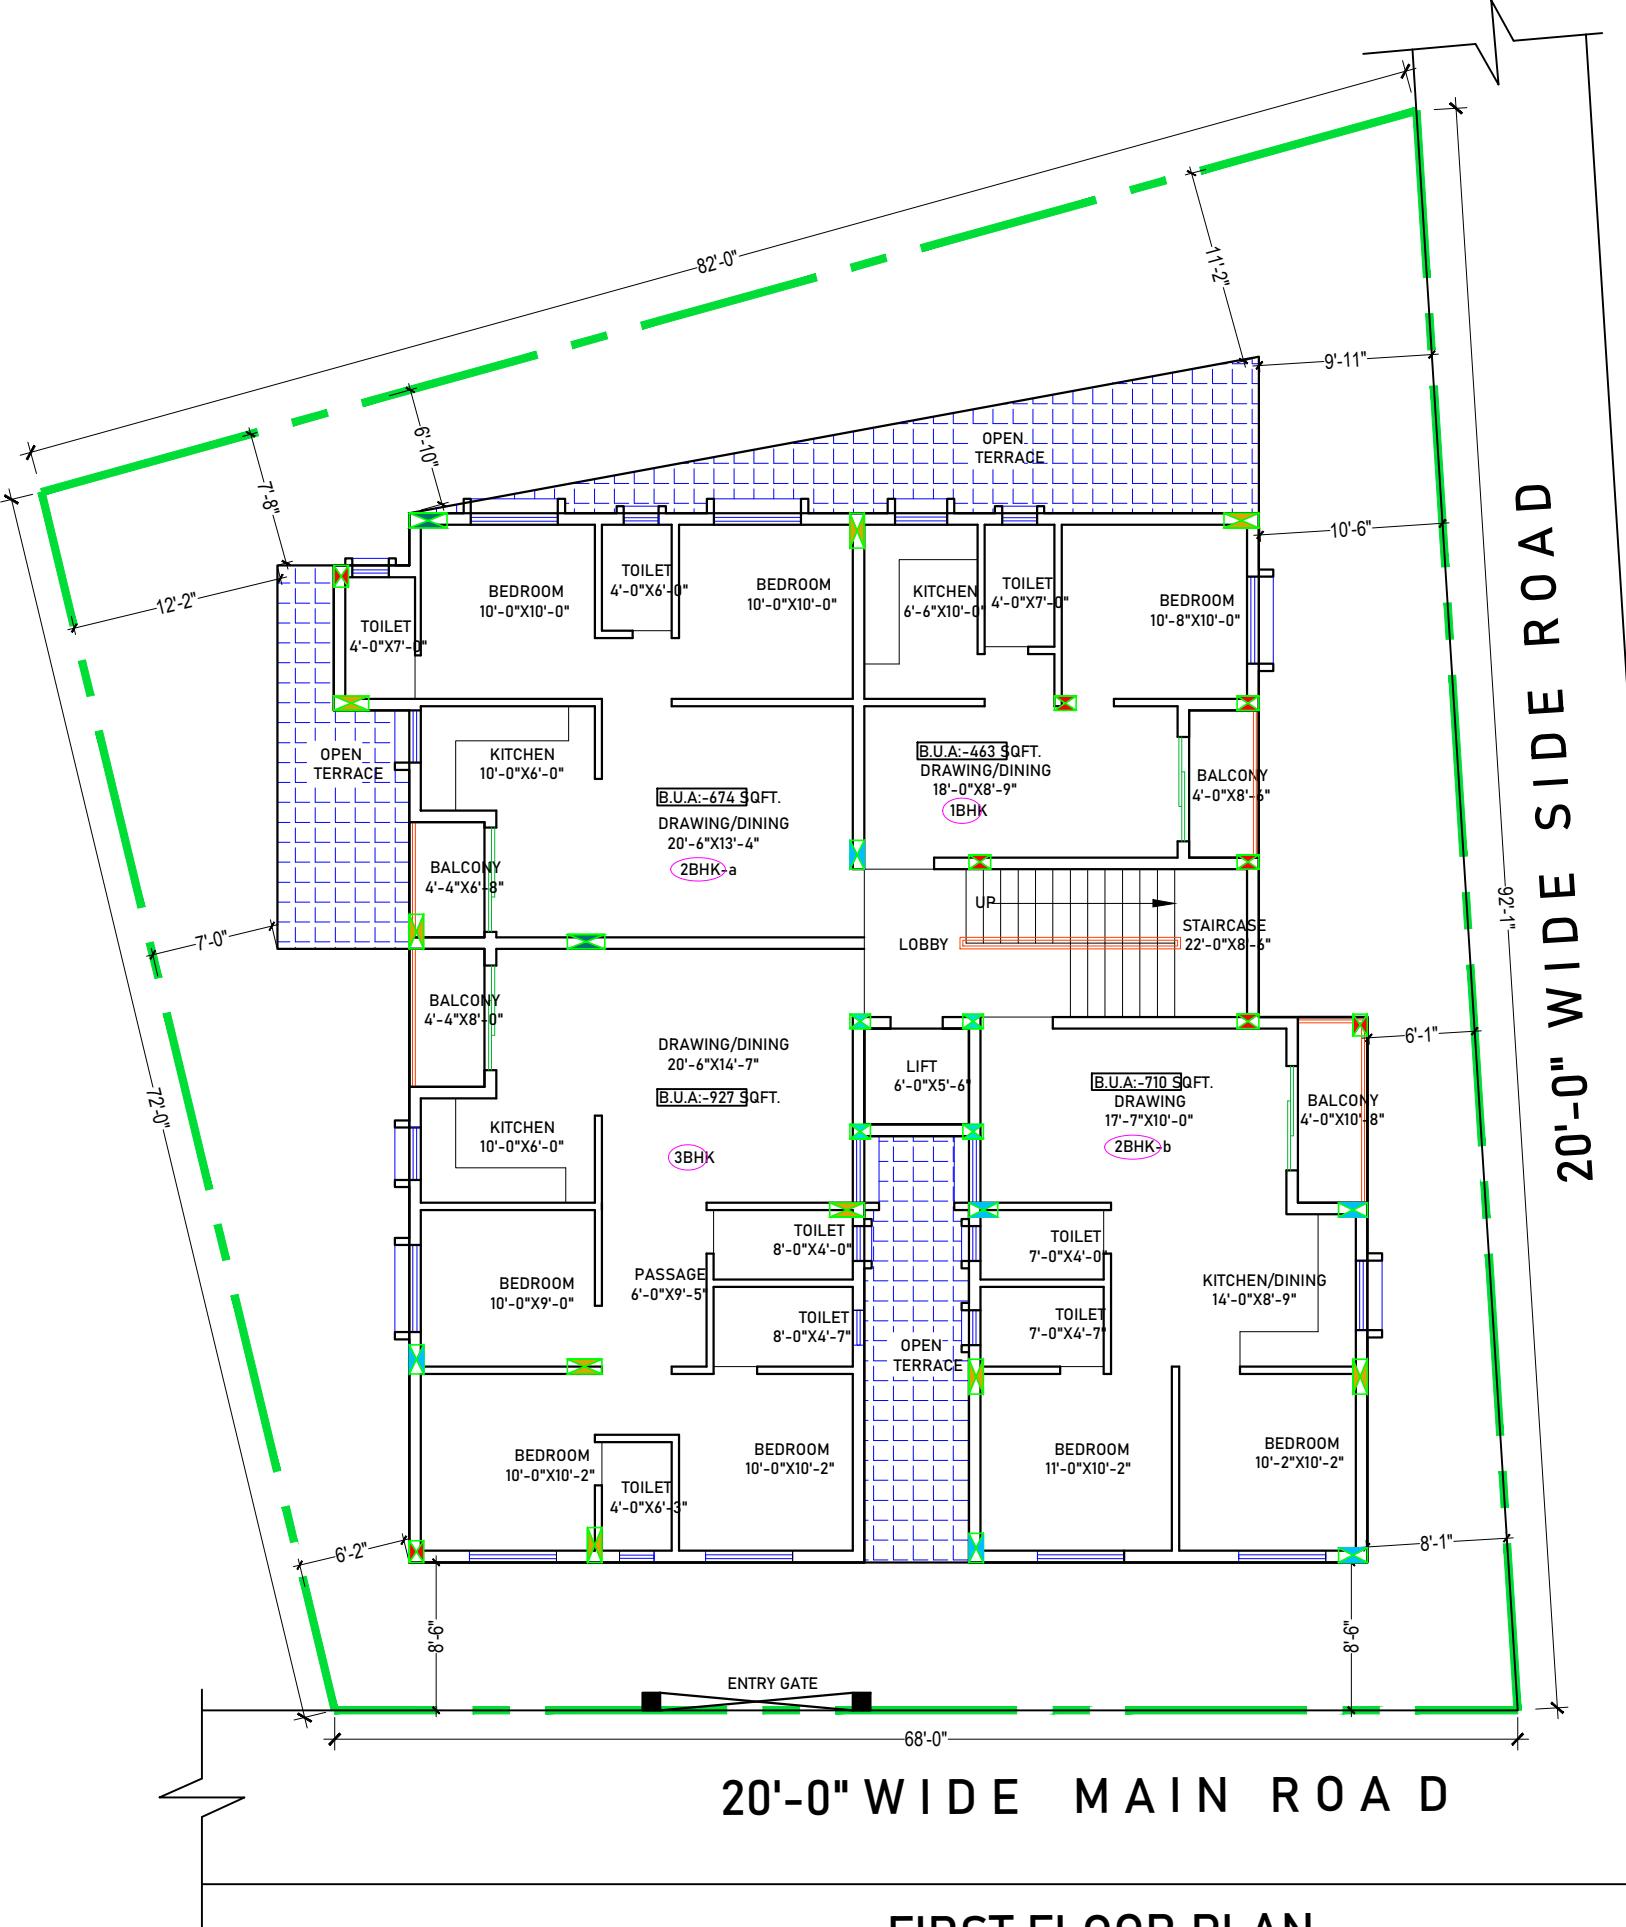
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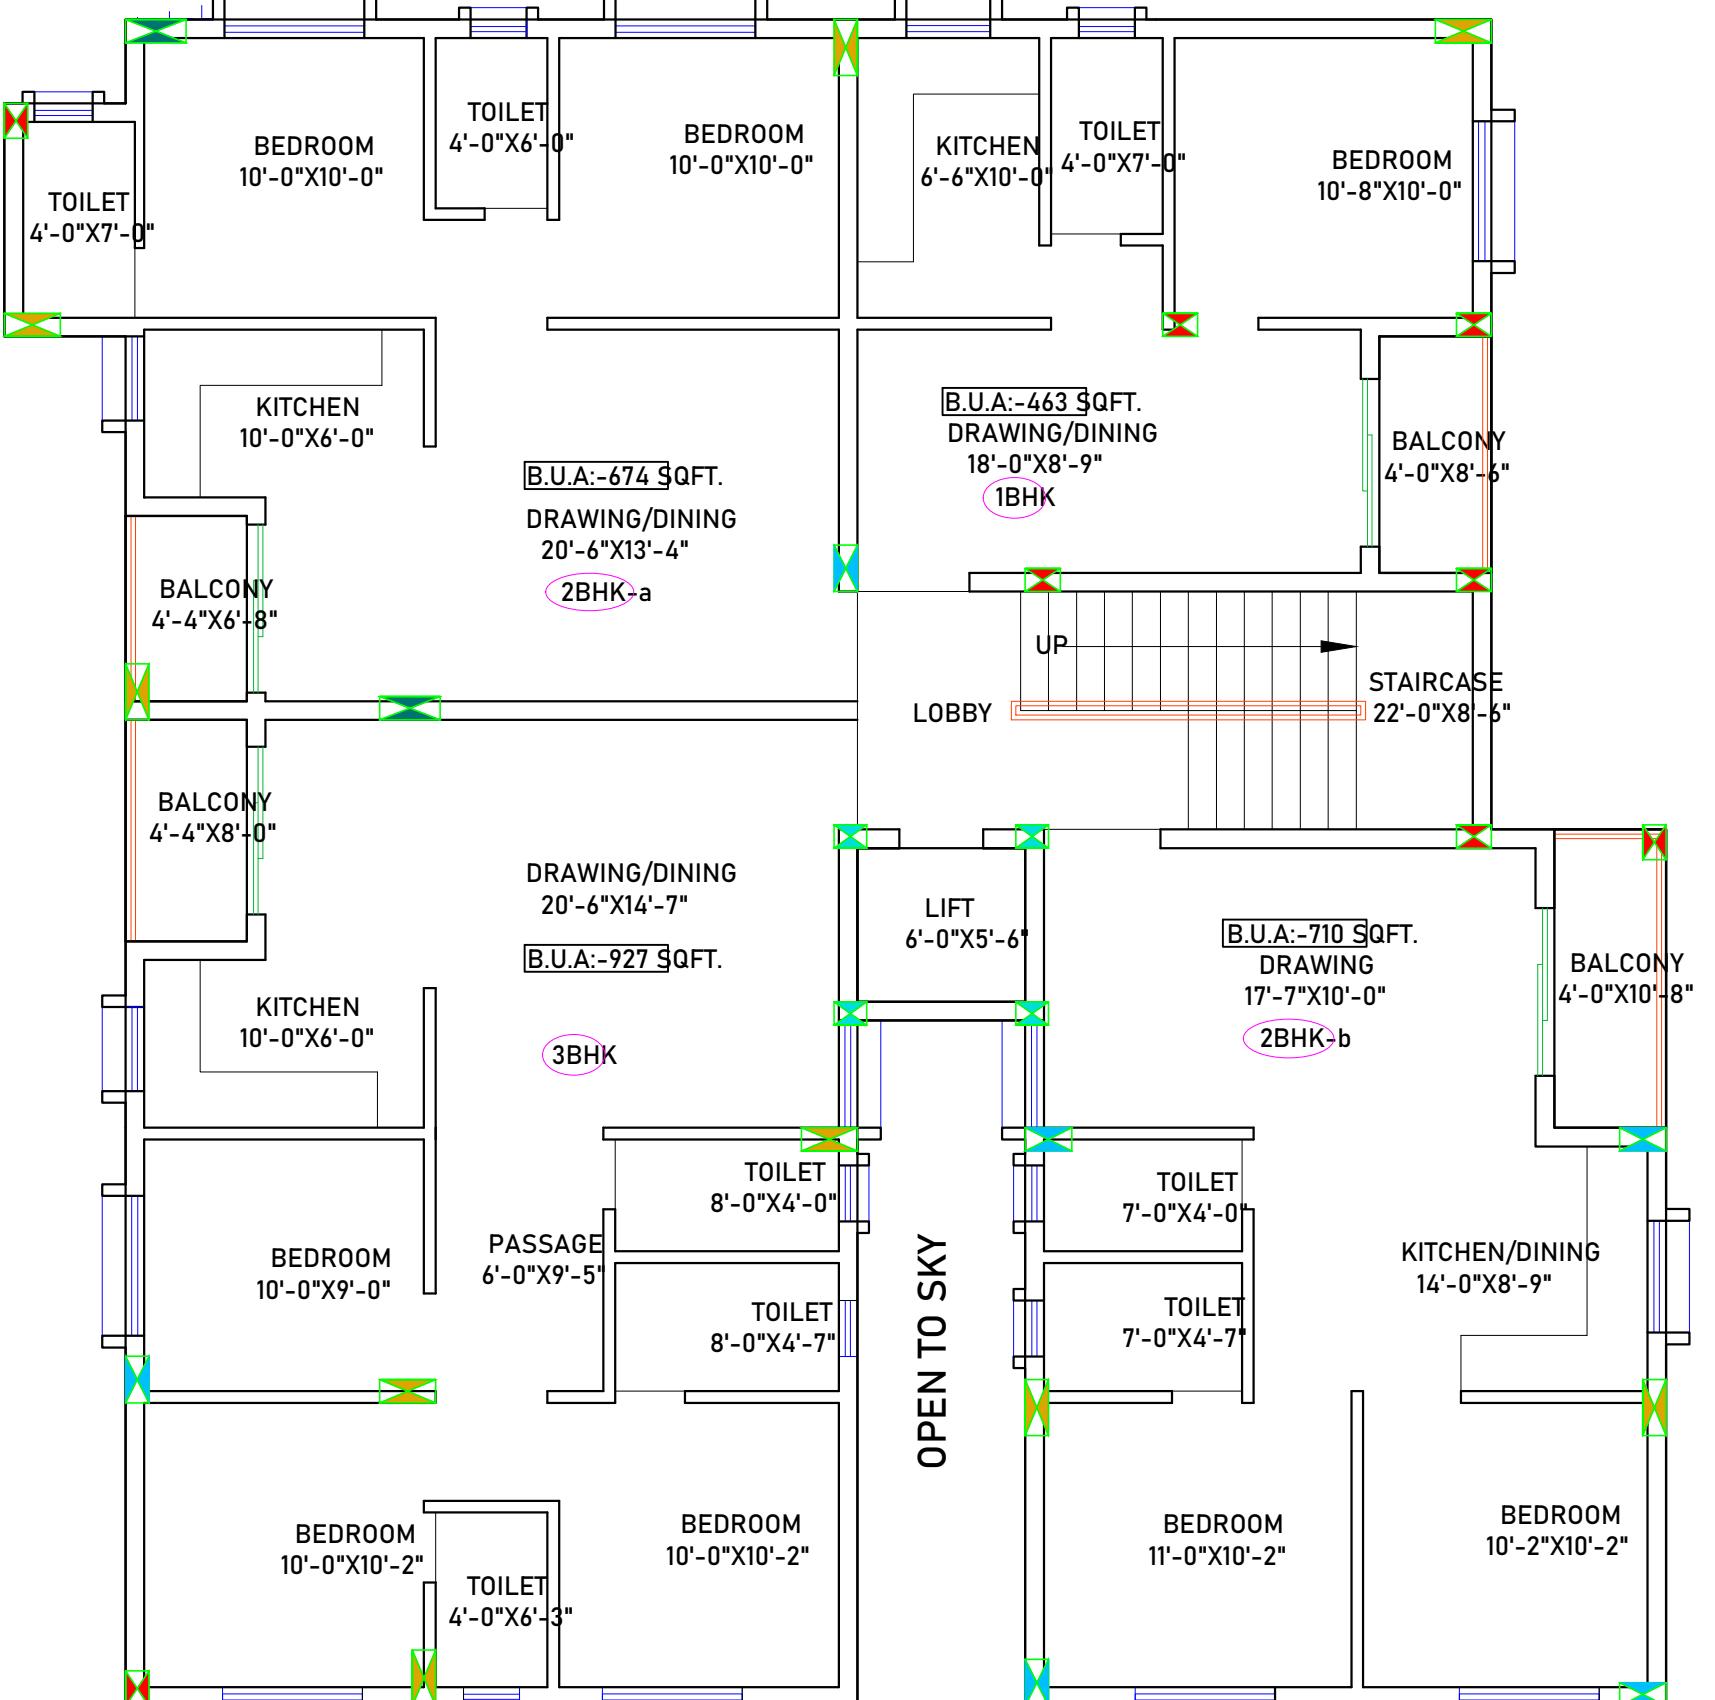


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SIGNATURE :-
DRAWN:- AR. DHANESHWARI
DESIGN:- ER. PABITRA
PROJECT TITLE:-
K.I.P SOUMYA
STATUS:
ISSUED FOR CONSTRUCTION
DATE: 04-05-2022
SCALE: NTS
DWG NO: 07
DRAWING TITLE:-
COLUMN PLAN


APS DESIGN INFRA PVT. LTD # B/48, BDA DUPLEX COLONY BARMUNDA Bhubaneswar, Pin- 751003 8 6 5 8 6 7 7 4 2 5 info@apsdesigninfra.com www.apsdesigninfra.com
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DESIGN:- ER. PABITRA
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DATE: 04-05-2022
SCALE: NTS
DWG NO: 08
DRAWING TITLE:-
COLUMN PLAN

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DATE: 04-05-2022

SCALE NTS

DWG NO: 09


DRAWING TITLE:-

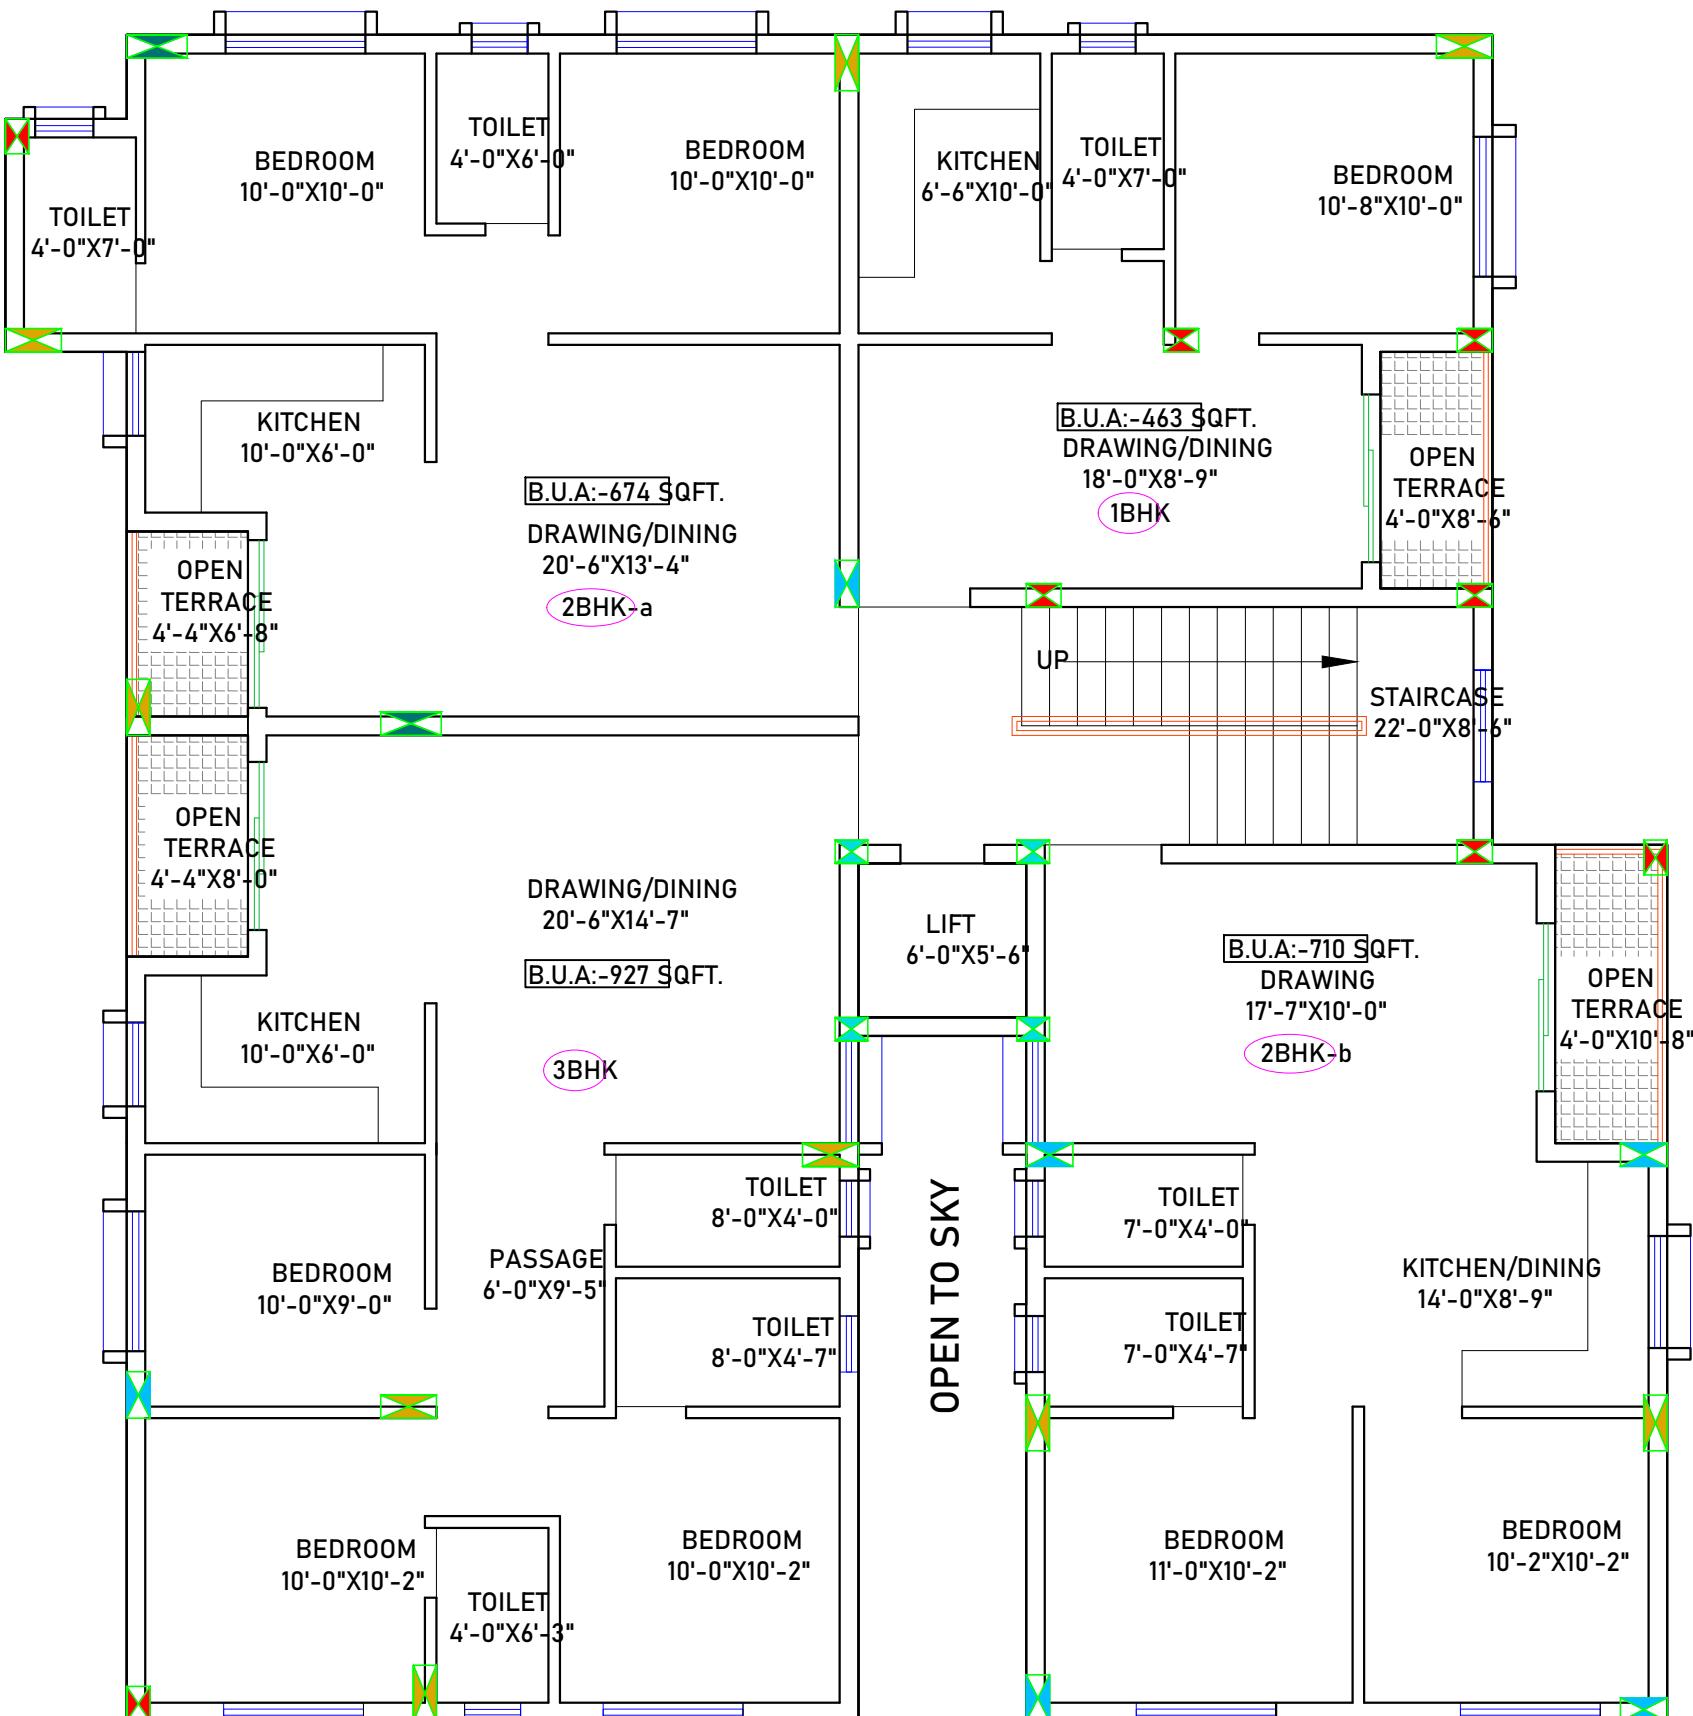COLUMN PLAN



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DESIGN:- ER. PABITRA

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DATE: 04-05-2022

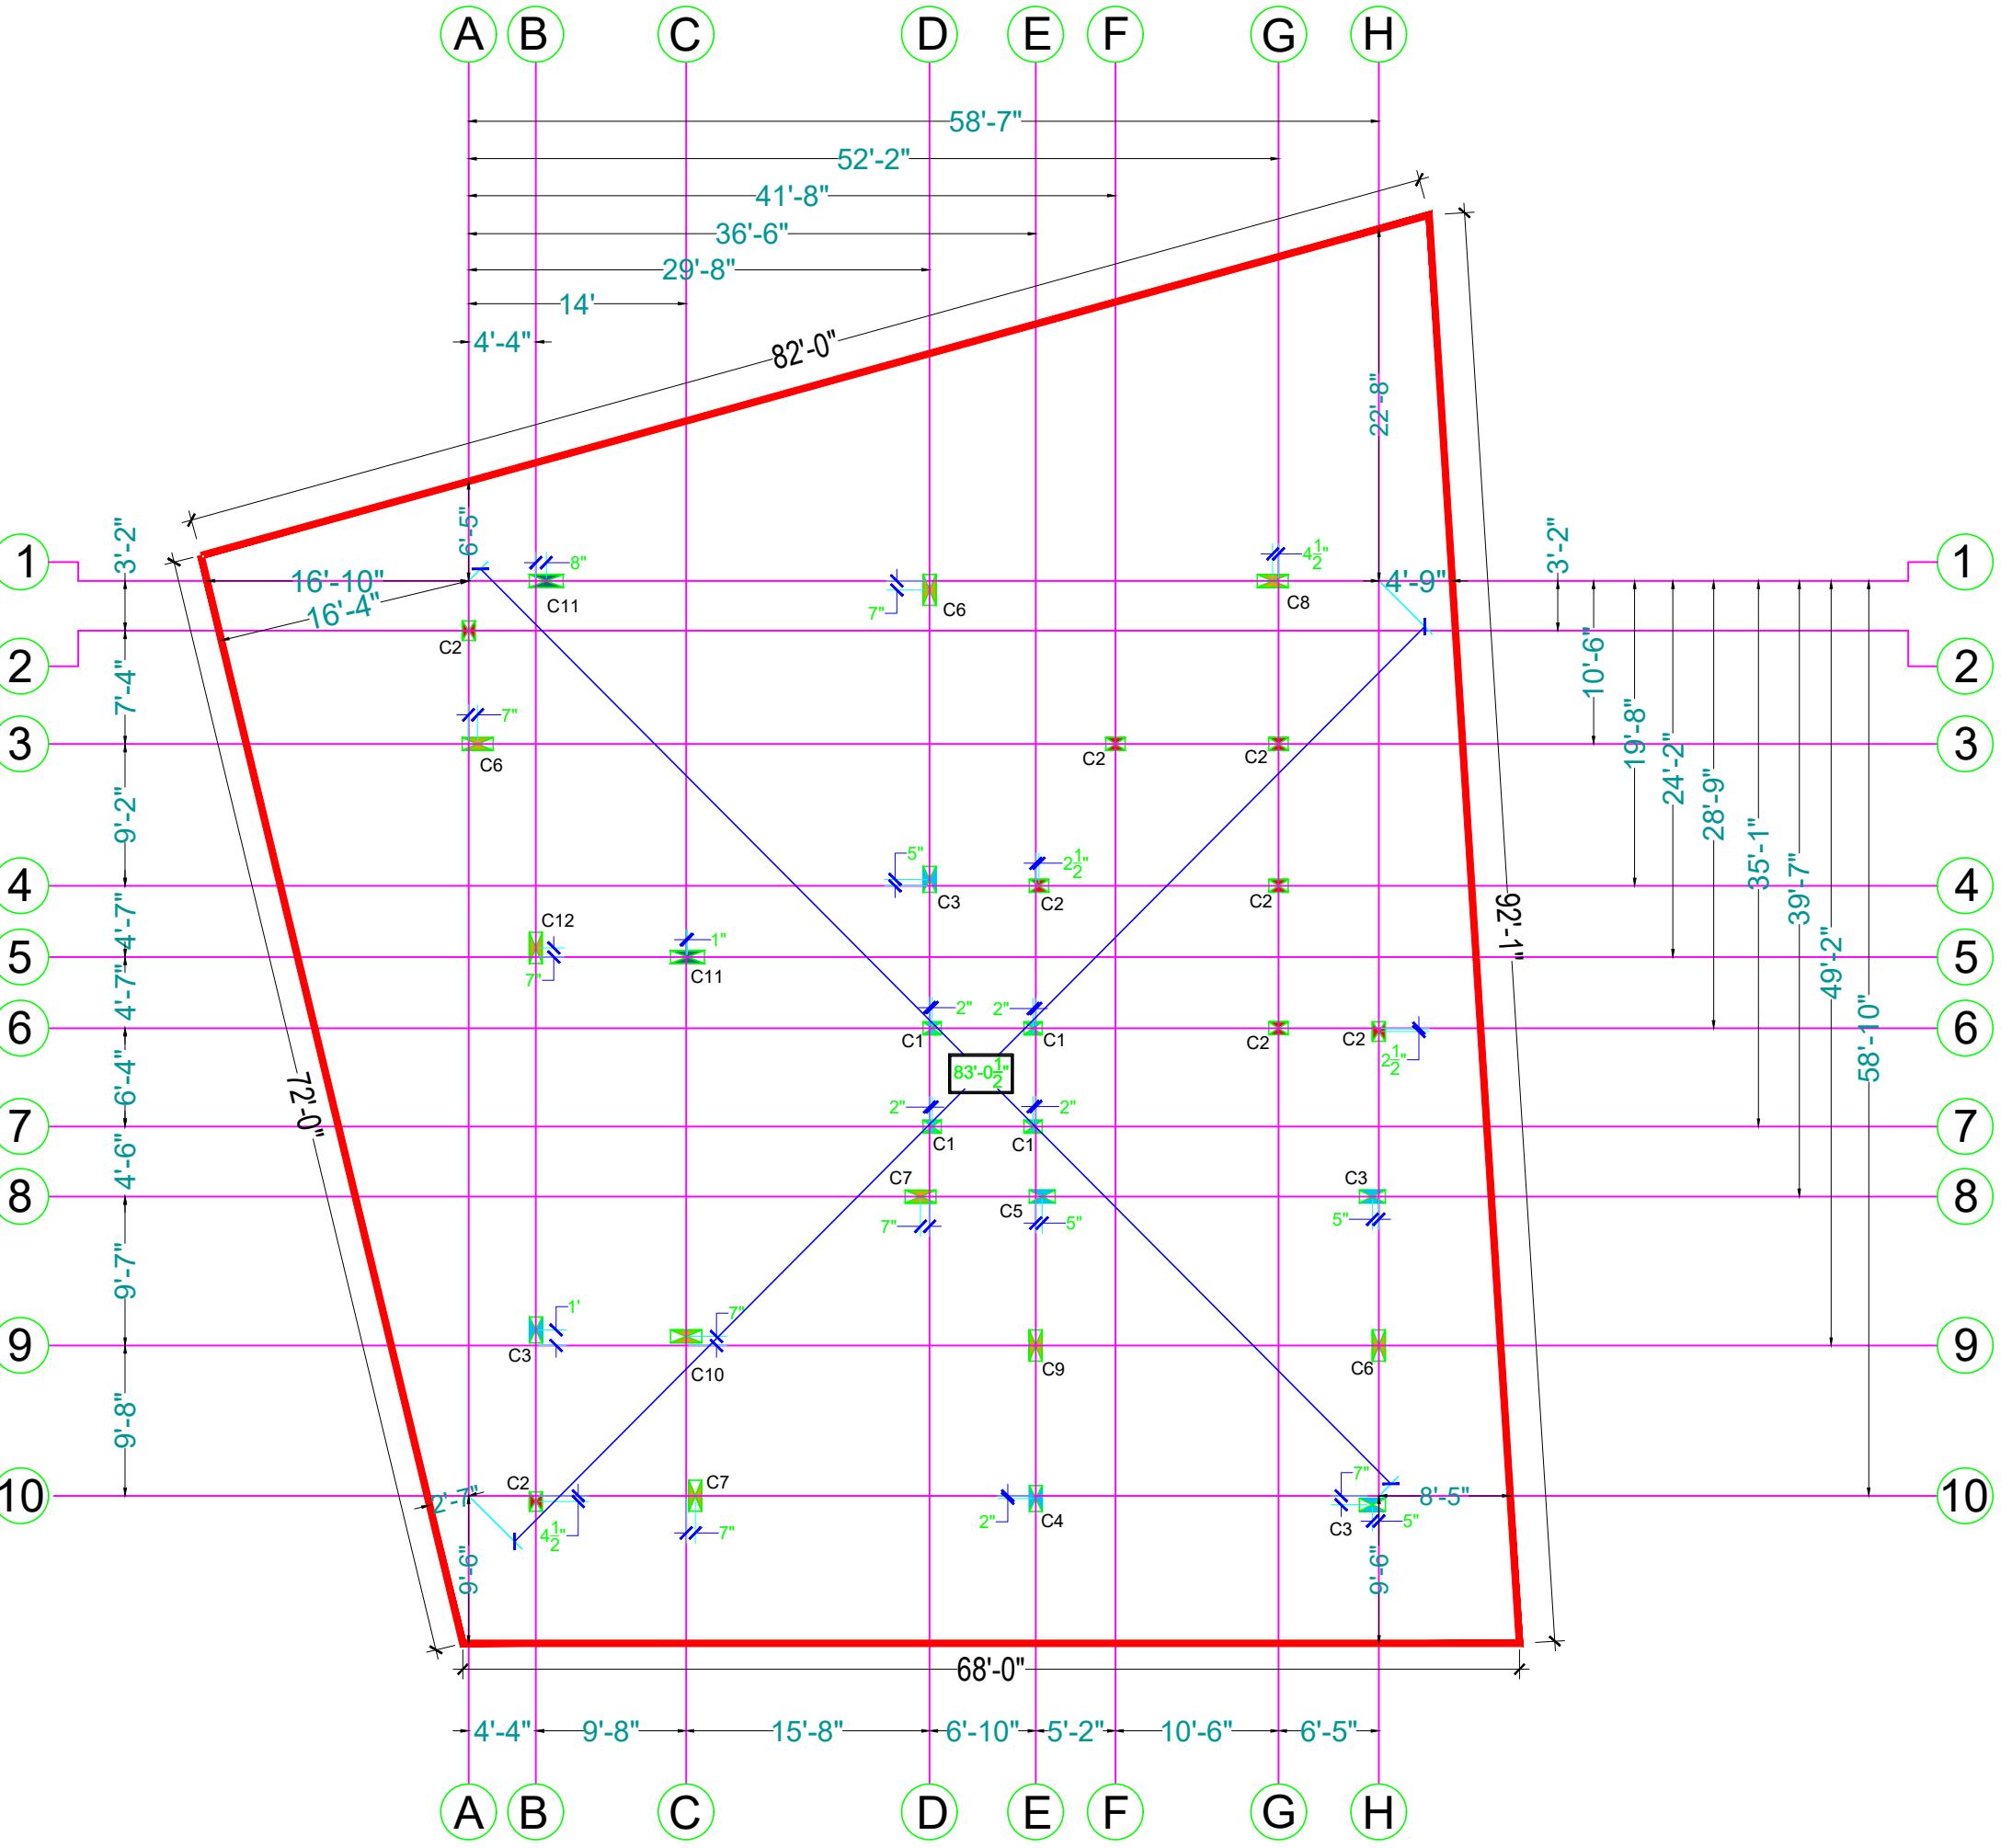SCALE NTS


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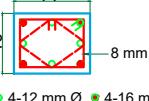
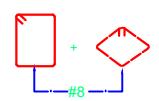
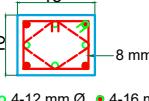
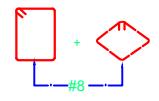
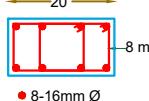
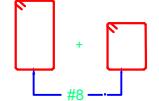
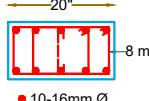
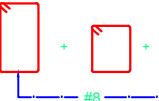
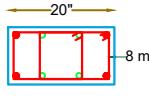
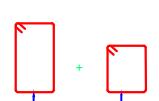
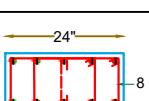
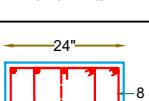
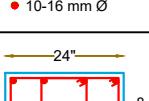
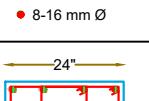
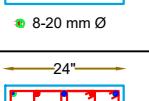
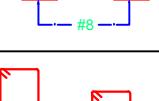
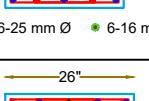
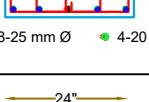
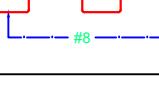
DRAWING TITLE:-

LAYOUT PLAN OF
COLUMN CENTERLINE


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BARMUNDA Bhubaneswar,
Pin- 751003
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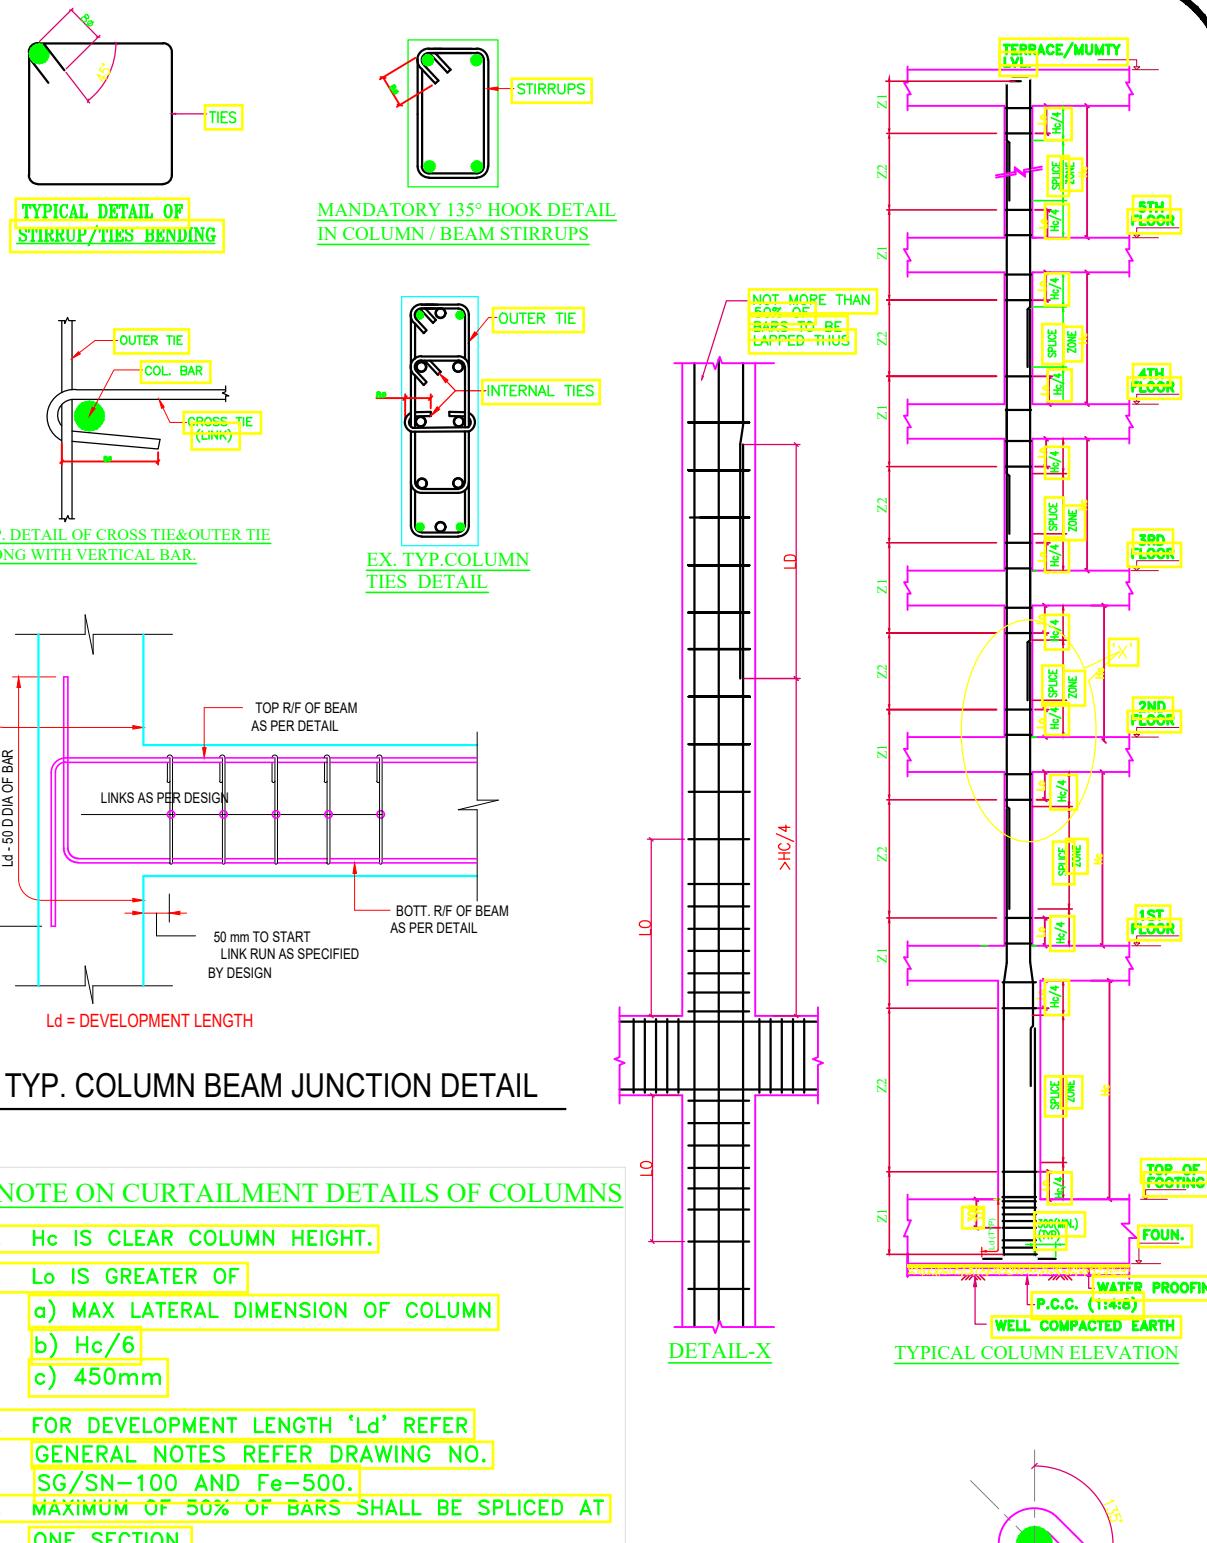


DETAILS OF COLUMN REINFORCEMENT						
COAL. NO AS MKD.	COLUMN SIZE	DETAILS OF COLUMN UP TO TOP				
		REINF.	STIRRUPS	COLUMN SECTION	SHAPE OF LAT. TIES	
C1	10"X14"	4#16 4#12	AS PER DRAWING	14" 10" 8 mm Ø @ 6" C/C ● 4-12 mm Ø ● 4-16 mm Ø		
C2	10"X15"	4#16 4#12	AS PER DRAWING	15" 10" 8 mm Ø @ 6" C/C ● 4-12 mm Ø ● 4-16 mm Ø		
C3	10"X20"	8#16	AS PER DRAWING	20" 10" 8 mm Ø @ 6" C/C ● 8-16 mm Ø		
C4	10"X20"	10#16	AS PER DRAWING	20" 10" 8 mm Ø @ 6" C/C ● 10-16 mm Ø		
C5	10"X20"	4#16 4#12	AS PER DRAWING	20" 10" 8 mm Ø @ 6" C/C ● 4-12 mm Ø ● 4-16 mm Ø		
C6	10"X24"	10#20	AS PER DRAWING	24" 10" 8 mm Ø @ 6" C/C ● 10-20 mm Ø		
C7	10"X24"	10#16	AS PER DRAWING	24" 10" 8 mm Ø @ 6" C/C ● 10-16 mm Ø		
C8	10"X24"	8#16	AS PER DRAWING	24" 10" 8 mm Ø @ 6" C/C ● 8-16 mm Ø		
C9	10"X24"	8#20	AS PER DRAWING	24" 10" 8 mm Ø @ 6" C/C ● 8-20 mm Ø		
C10	10"X24"	6#25 6#16	AS PER DRAWING	24" 10" 8 mm Ø @ 6" C/C ● 6-25 mm Ø ● 6-16 mm Ø		
C11	10"X26"	8#25 4#20	AS PER DRAWING	26" 10" 8 mm Ø @ 6" C/C ● 8-25 mm Ø ● 4-20 mm Ø		
C12	10"X24"	6#20 6#16	AS PER DRAWING	24" 10" 8 mm Ø @ 6" C/C ● 6-20 mm Ø ● 6-16 mm Ø		

COLUMN AND WALL SCHEDULE

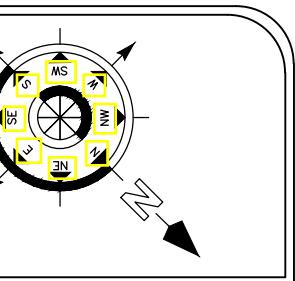NOTES:


- BE = BOUNDARY ELEMENT AS PER IS 13920. PROVIDE CONFINING REINFORCEMENT ACROSS ENTIRE HEIGHT OF WALL IN THE BOUNDARY ELEMENT
- Z1 = SPECIAL CONFINING ZONE AS PER IS 13920, Z2 = REMAINING ZONES AS PER IS 456



NOTE

- Clear Cover of column is $1\frac{1}{2}$ " on each side, for below FGL column min $2\frac{1}{2}$ "
- 28 days compressive strength of Concrete must be $f'_c = 25$ mpa
- Yield Strength of Steel must not be less than $f_y = 500$ mpa
- Only deformed bar is allowed in the construction
- In construction if the arrangement as shown in fig not possible for any reason then bundle steel will be used as of the SP 34 recommendation
- Concrete Mix design as per IS 456 2000 concrete design method
- No casting is allowed in night or during rain.
- Shuttering Material Should be not used which are already had used for too many construction
- Max Slump value 3"
- Shuttering can be removed after 24 hrs
- All Column should be casted in two stage

DETAIL OF HOOKS

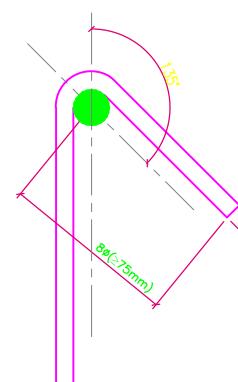

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DRAWN:- AR. DHANESHWARI

DESIGN:- ER. PABITRA

PROJECT TITLE:-

K.I.P SOUMYA

STATUS:

ISSUED FOR CONSTRUCTION

DATE: 04-05-2022

SCALE NTS

DWG NO: 11


DRAWING TITLE:-

COLUMN SCHEDULE & DETAILING



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LAYOUT PLAN OF COLUMN CENTERLINE
FOOTING LAYOUT PLAN

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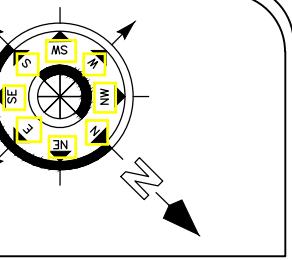
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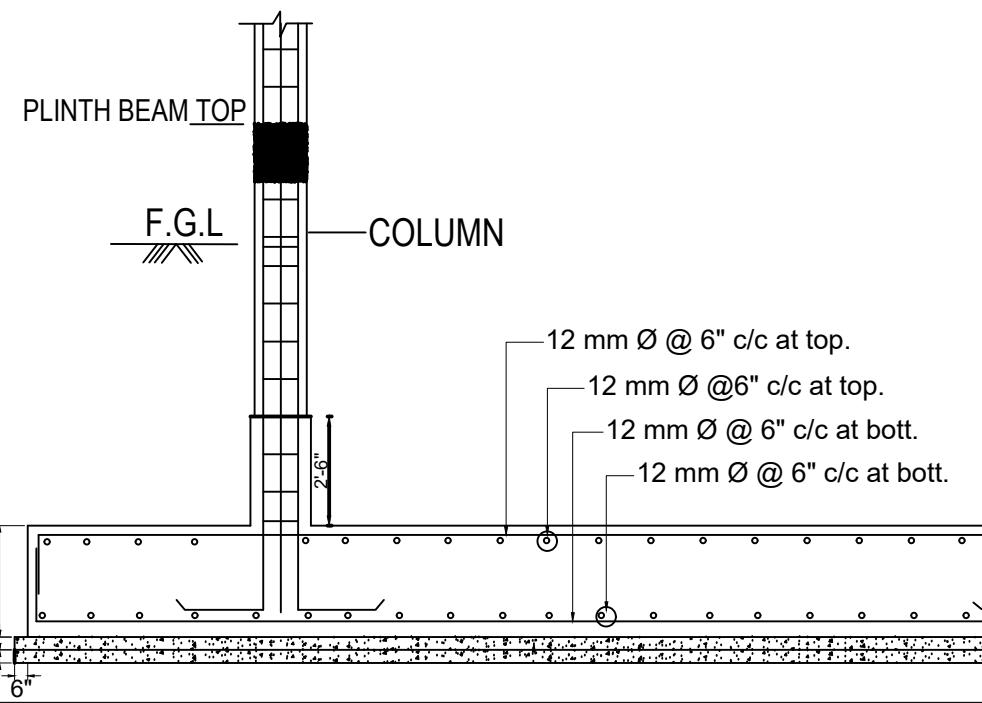
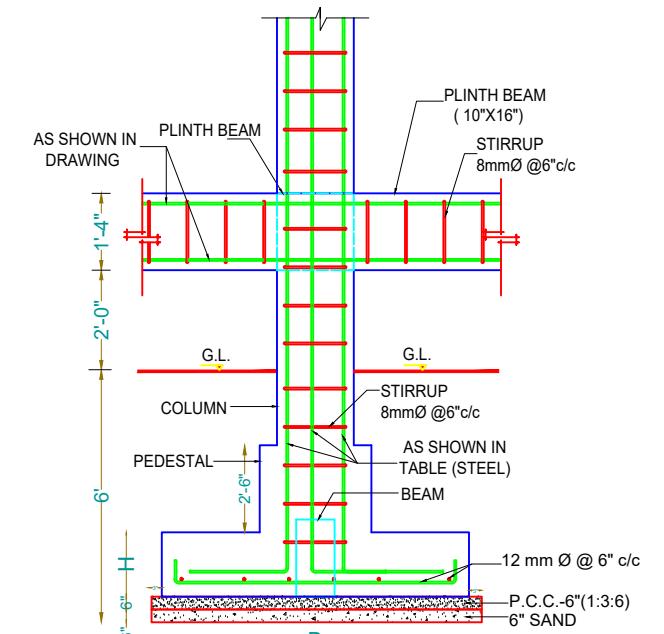
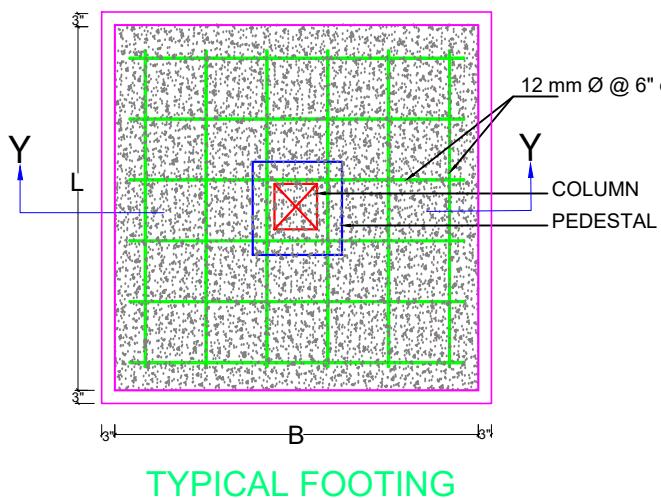
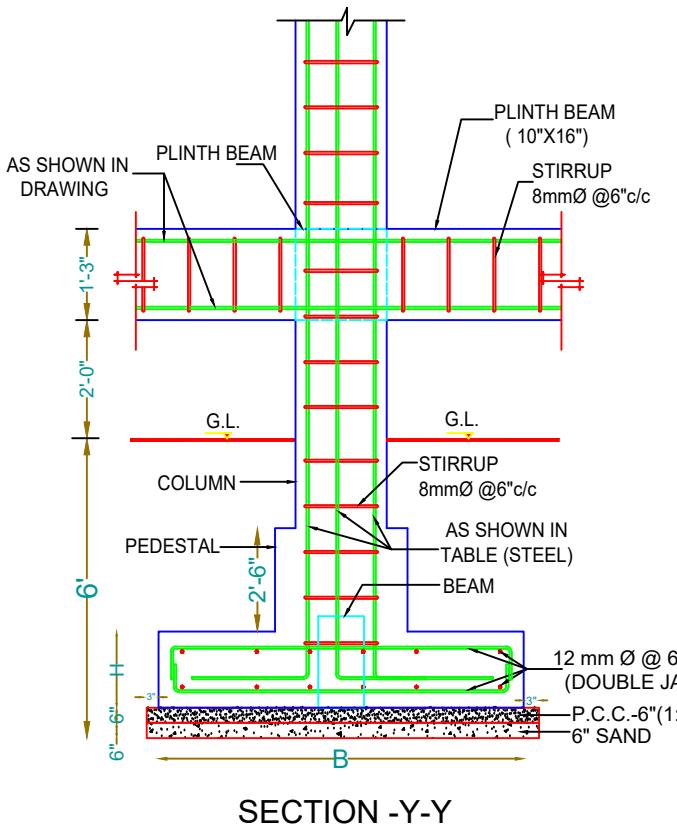
FOOTING LAYOUT
PLAN

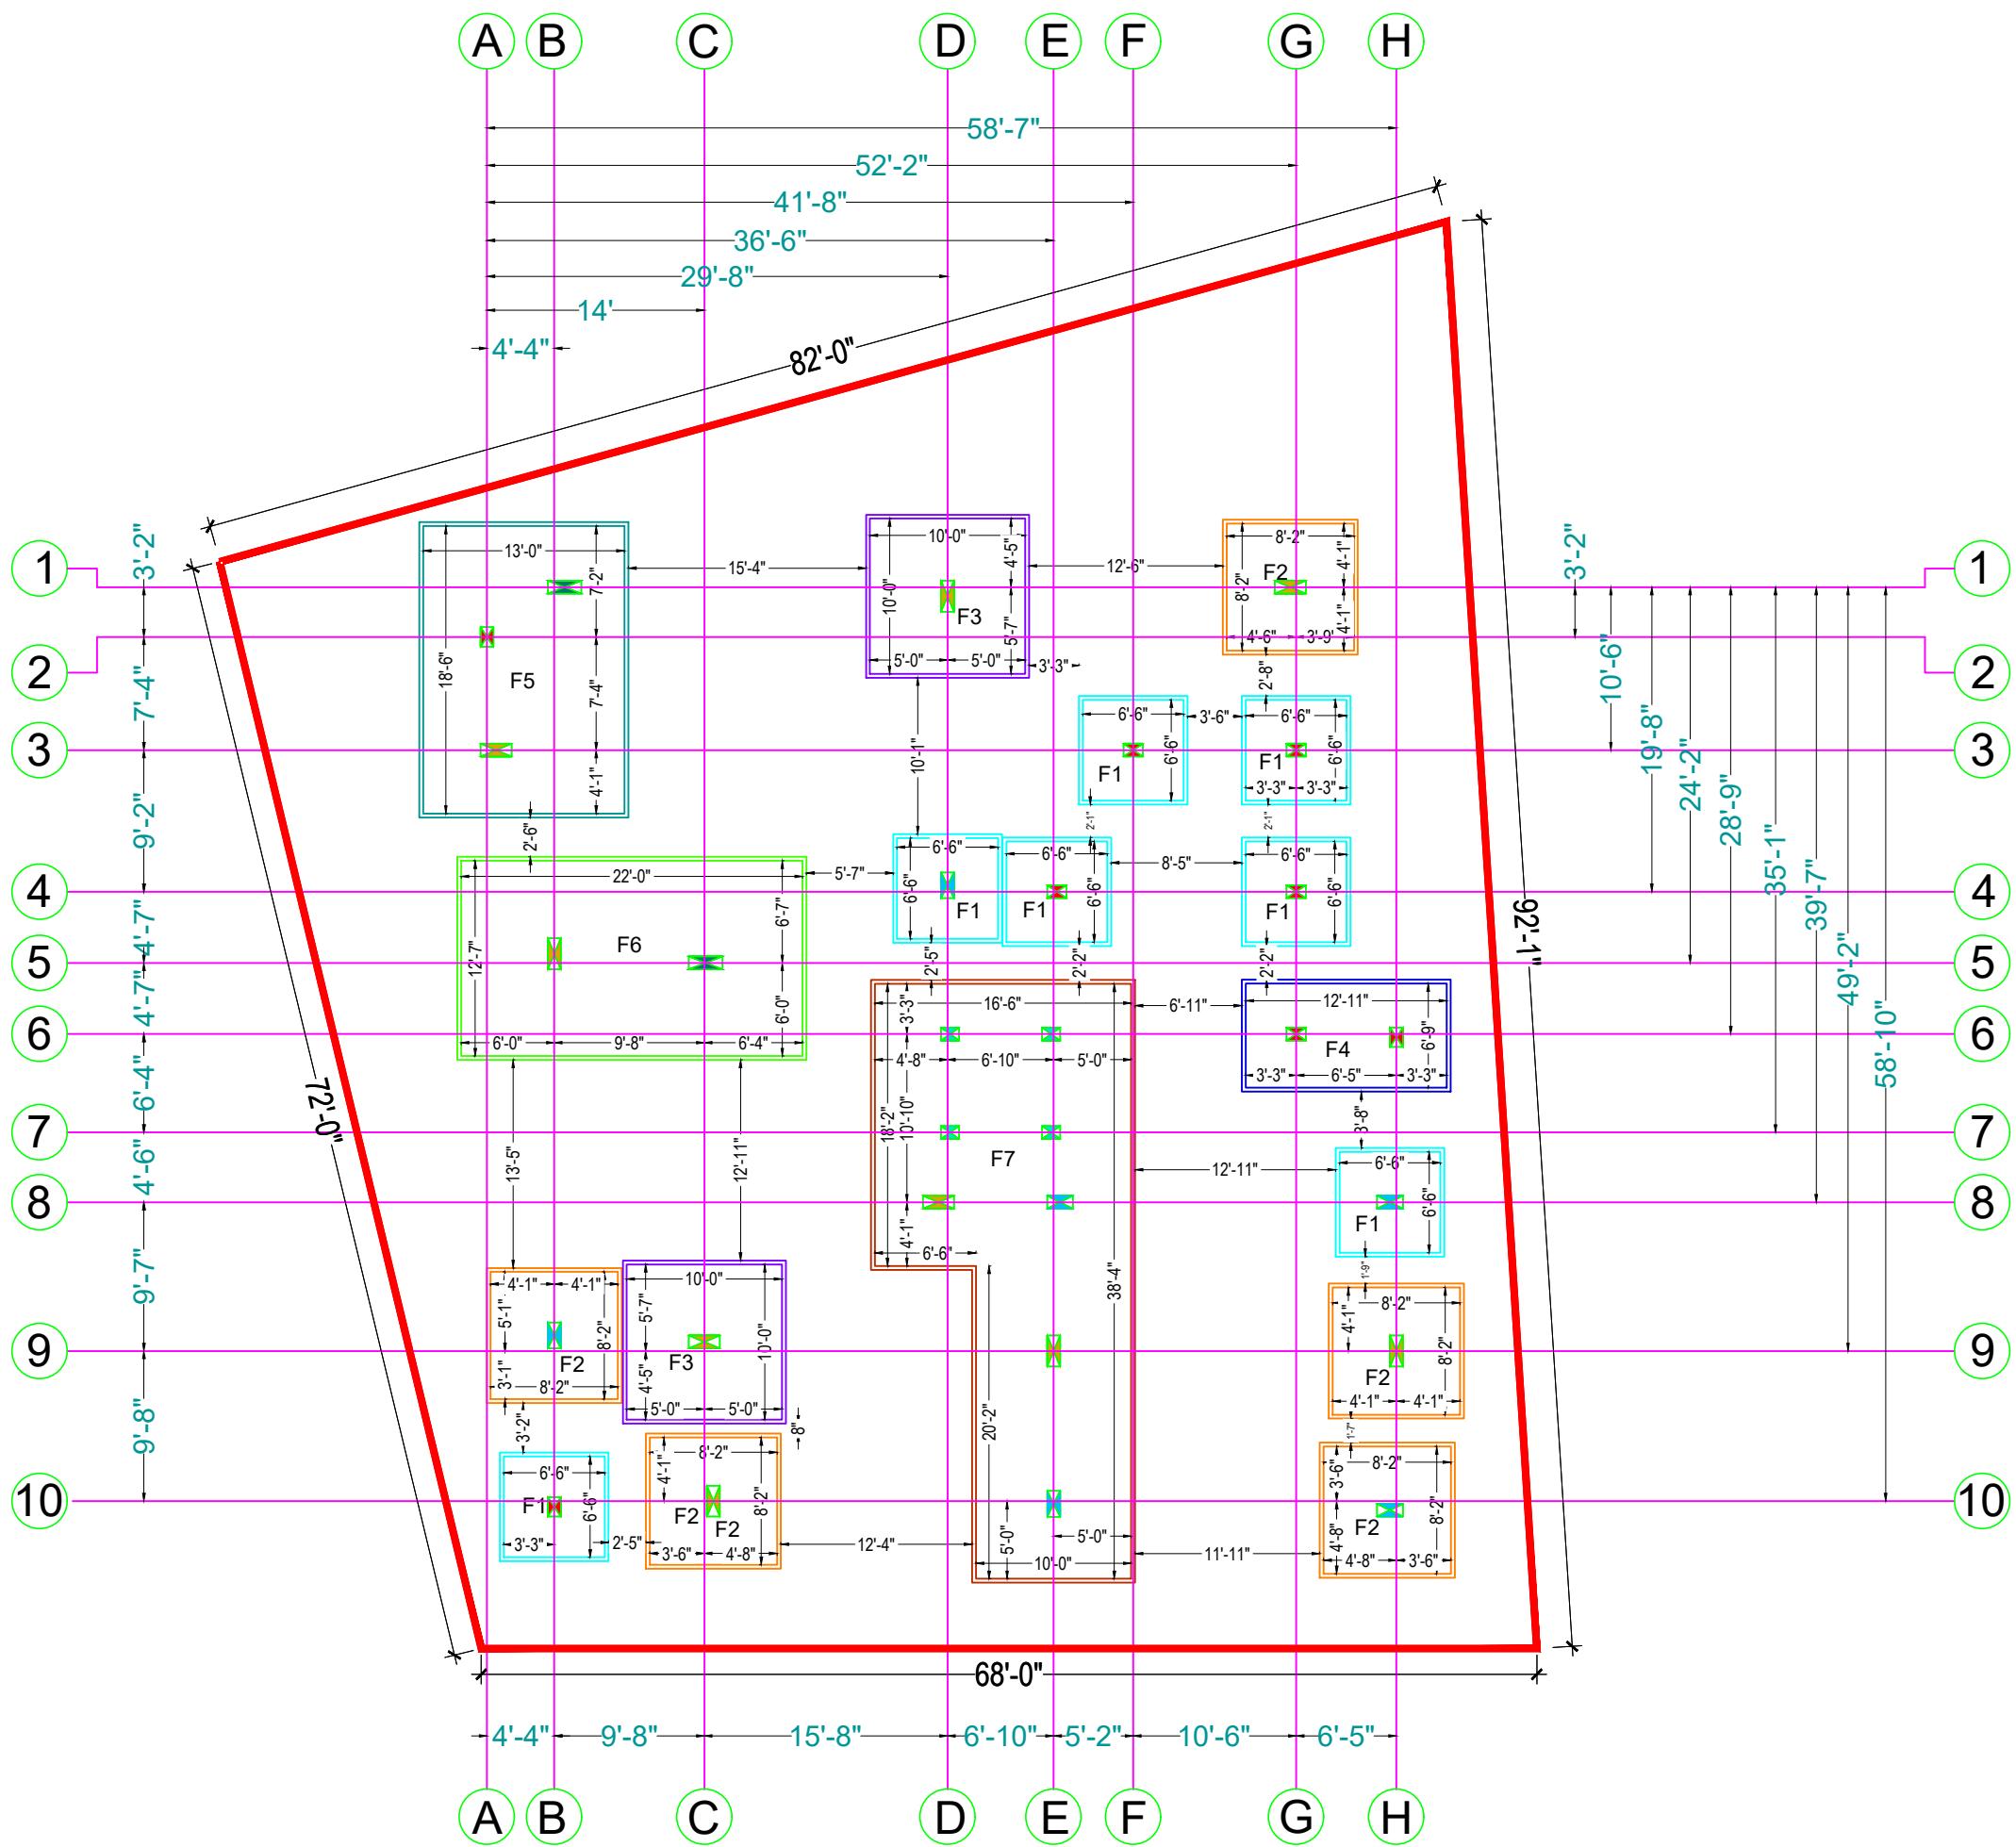




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FOOTING	L	B	H	STEEL	MESH	PEDESTAL
F1	6'-6"	6'-6"	1'-4"	#12@6"C/C B/W	SINGLE MESH	P1
F2	8'-2"	8'-2"	1'-4"	#12@6"C/C B/W	SINGLE MESH	P1
F3	10'-0"	10'-0"	1'-4"	#12@6"C/C B/W	DOUBLE MESH	P2
F4	12'-11"	6'-9"	1'-8"	#12@6"C/C B/W	DOUBLE MESH	P2
F5	13'-0"	18'-6"	1'-10"	#12@6"C/C B/W	DOUBLE MESH	P2
F6	22'-0"	12'-7"	1'-10"	#12@6"C/C B/W	DOUBLE MESH	P2
F7	38'-4"	16'-6"	1'-10"	#12@6"C/C B/W	DOUBLE MESH	P2



PEDESTAL	L	B	H
P1	2'-0"	2'-0"	2'-6"
P2	2'-6"	2'-6"	2'-6"



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DESIGN:- ER. PABITRA
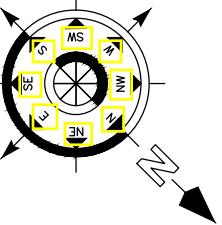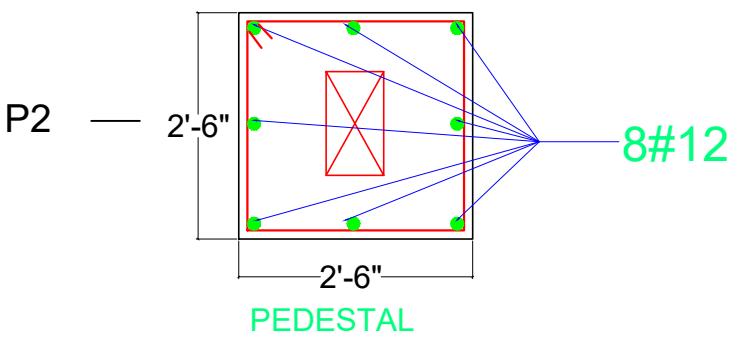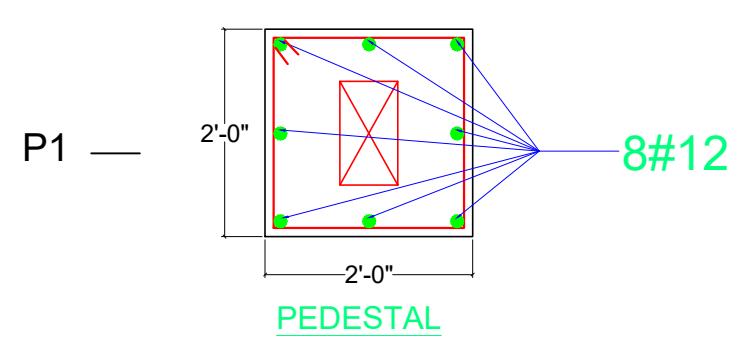
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K.I.P SOUMYA

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DATE: 04-05-2022

SCALE NTS

DWG NO: 13

DRAWING TITLE:-


FOOTING
DETAIL DRAWING




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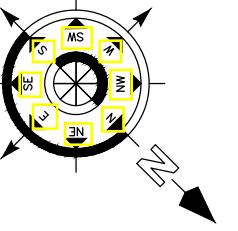
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PLAN



TYPICAL SECTION THROUGH LIFT
WALL(SECTION Z-Z)

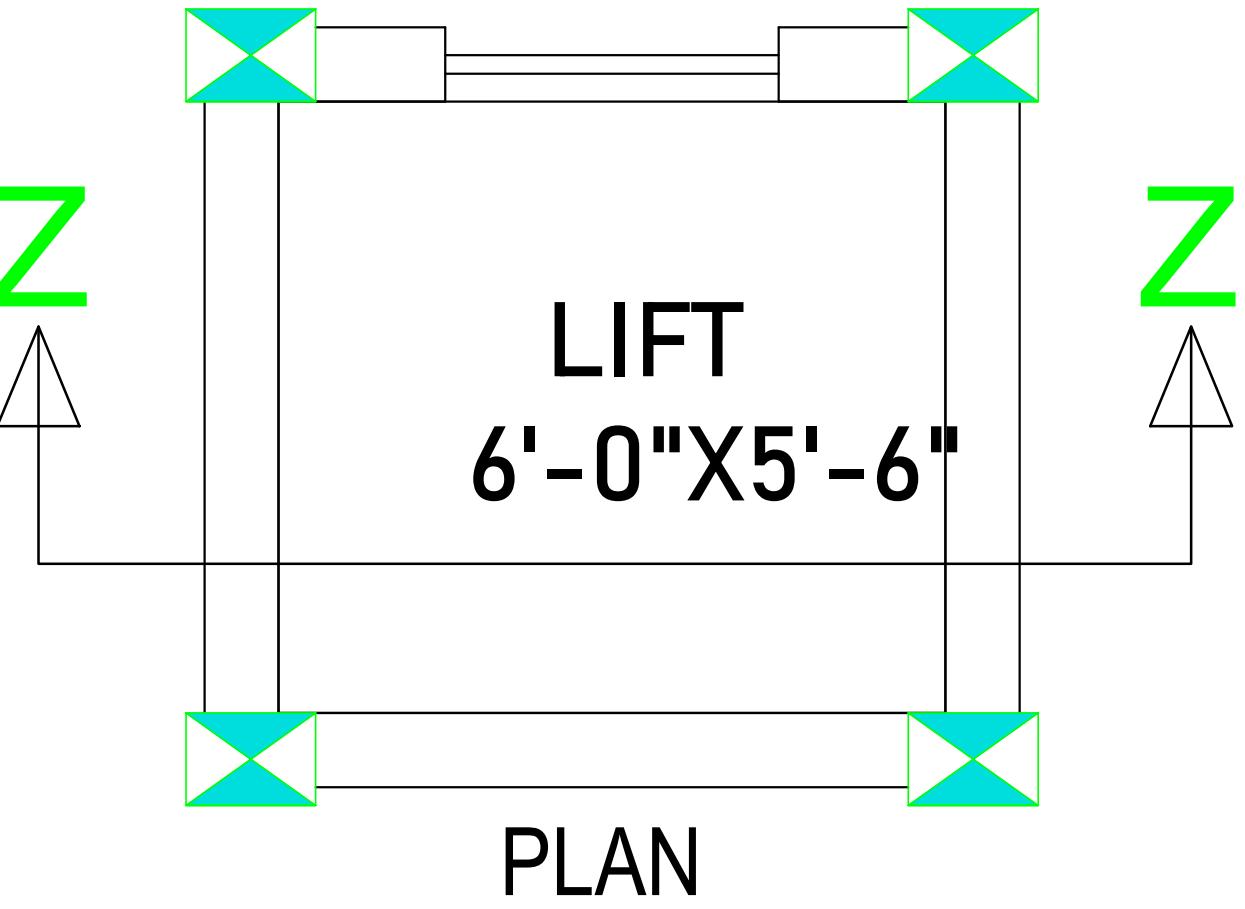

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- MINIMUM DEVELOPMENT LENGTH FOR TOR STEEL SHALL BE 50d, WHERE 'd' IS DIA OF MAIN REINFORCEMENT.
- THE LAP SHALL BE STAGGERED AND AVOIDED AT THE POINT OF MAXIMUM BENDING MOMENT.
- ALL DIMENSION & LEVEL ARE IN FEET-INCH.

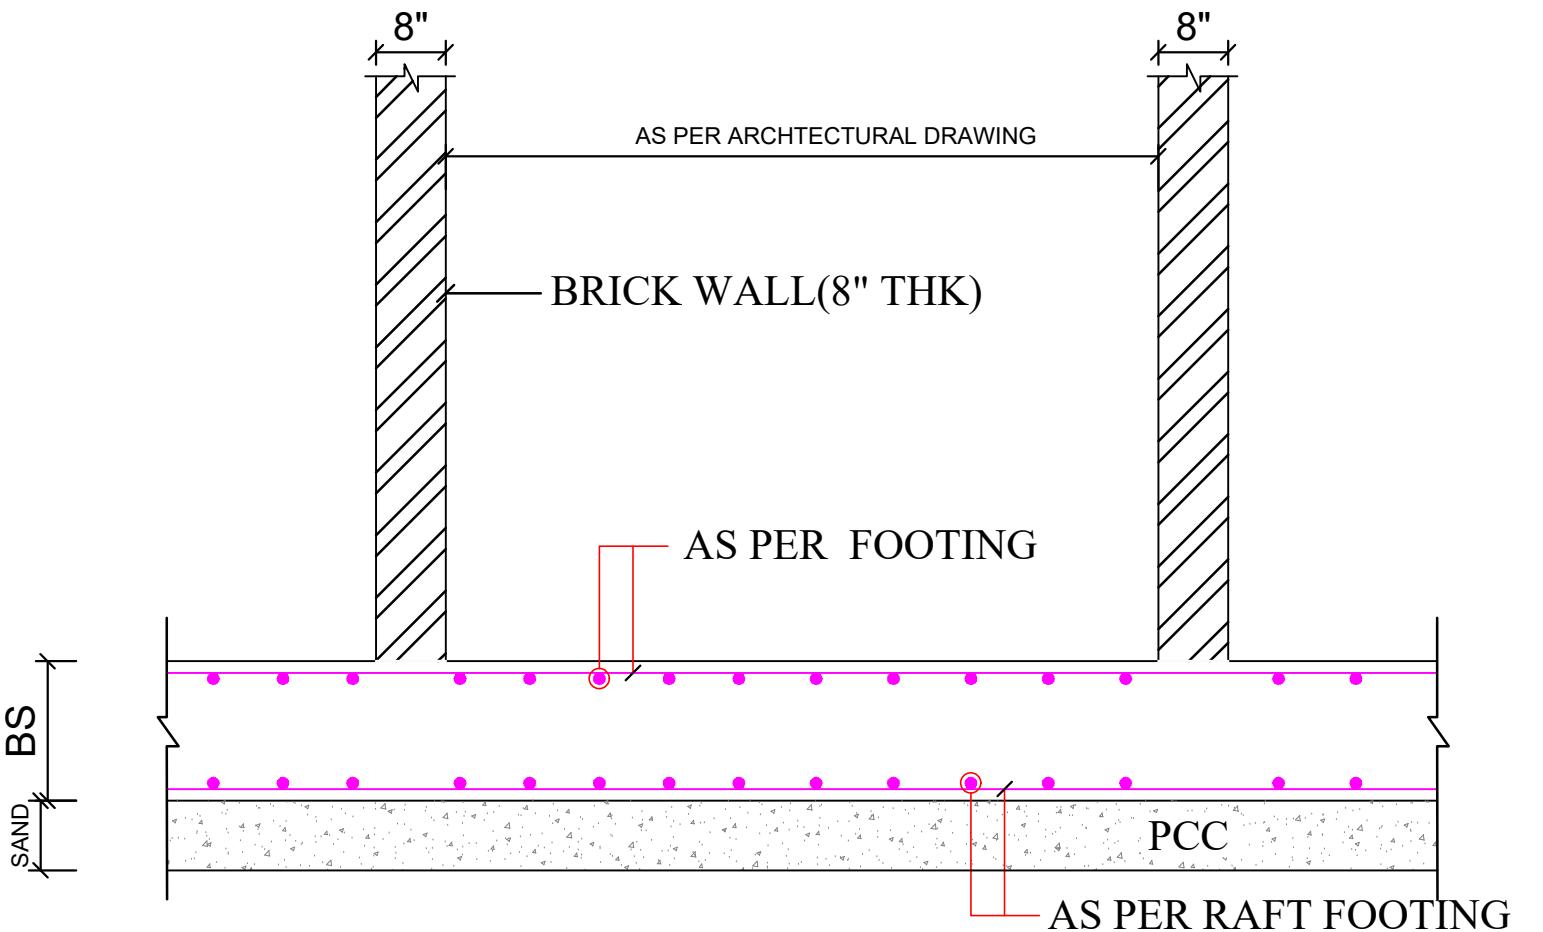SIGNATURE :-

DRAWN:- AR. DHANESHWARI

DESIGN:- ER. PABITRA

PROJECT TITLE:-

K.I.P SOUMYA

STATUS:

ISSUED FOR CONSTRUCTION

DATE:	04-05-2022
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SCALE	NTS
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DWG NO:	14
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DRAWING TITLE:-


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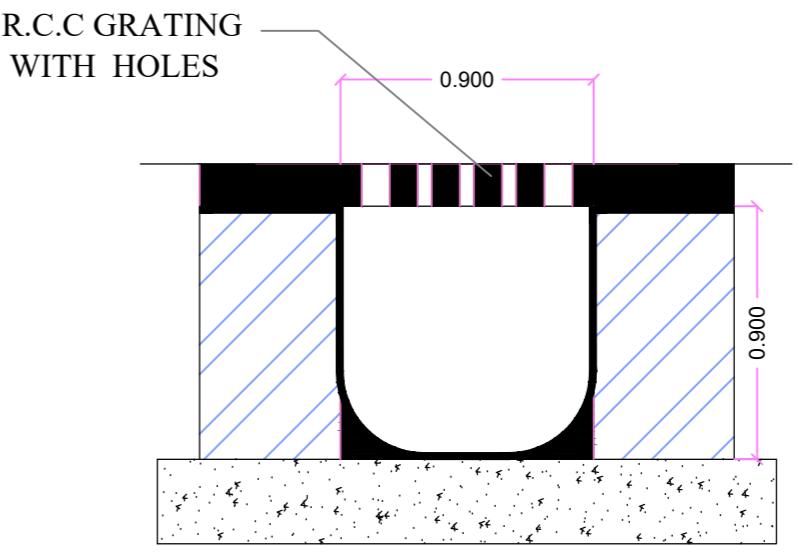
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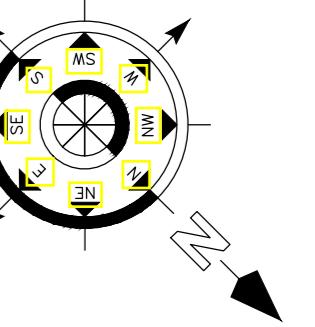
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ARRANGEMENT OF REINFORCEMENT IN A BEAM



DRAIN



Note:
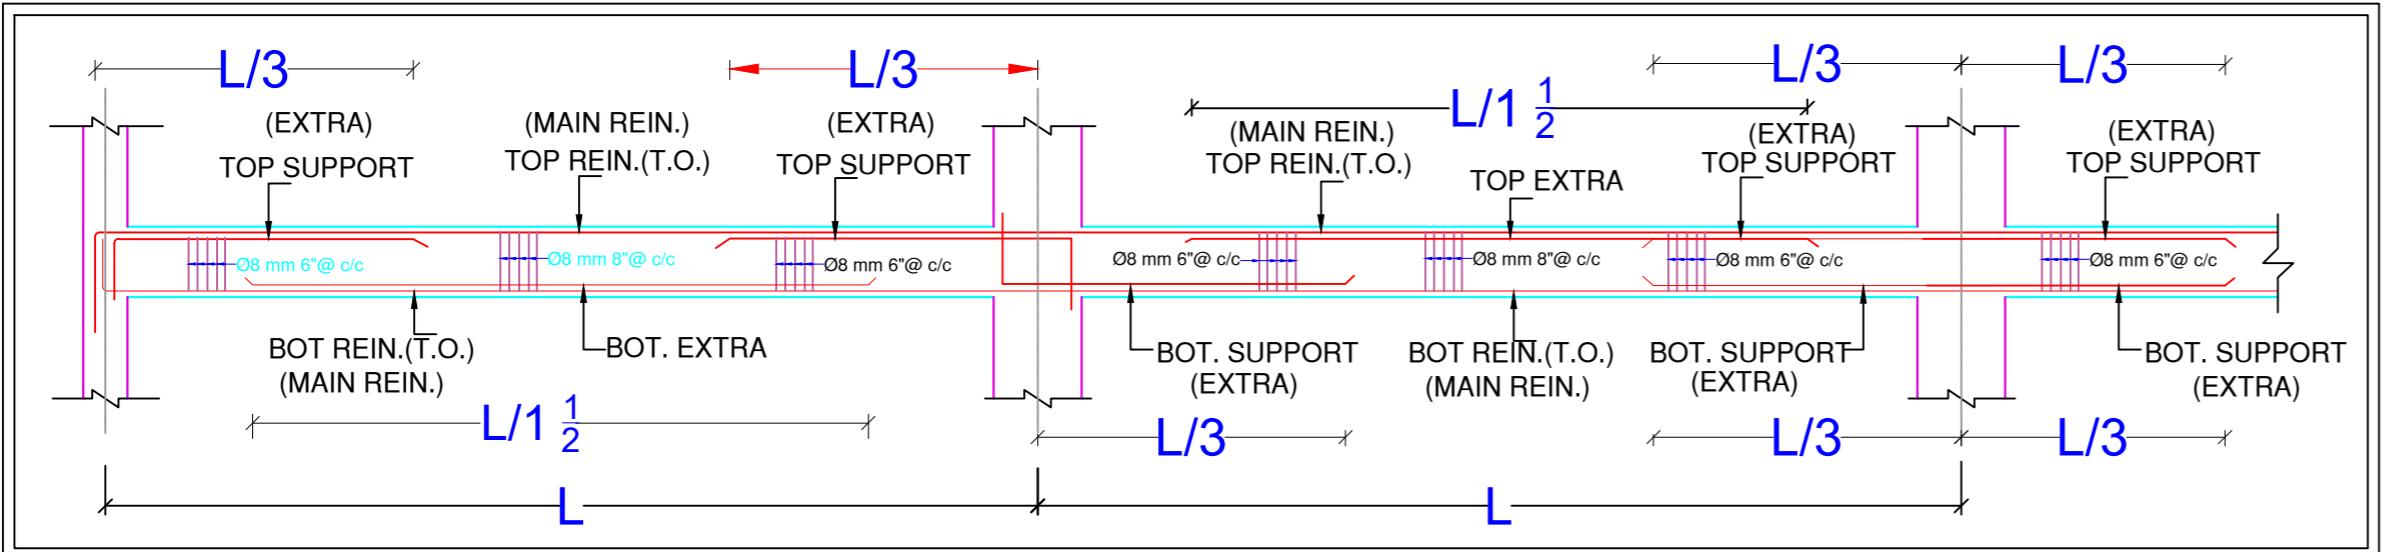
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SIGNATURE :-

DRAWN:- AR. DHANESHWARI

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PROJECT TITLE:-

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DATE: 04-05-2022

SCALE NTS

DWG NO: 15


DRAWING TITLE:-

COMPONENTS




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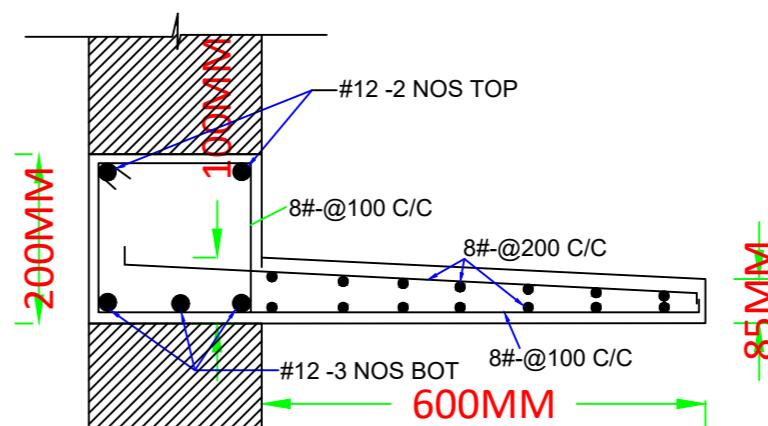
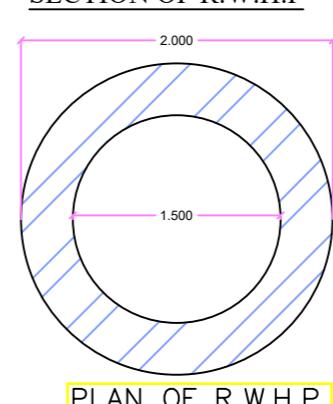
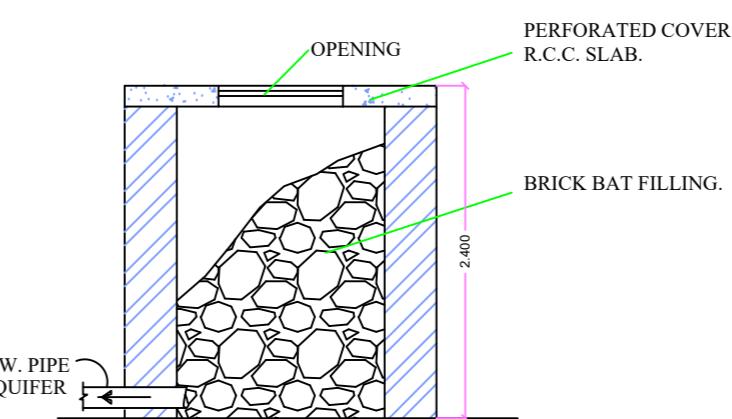


TYPICAL CURTAILMENT DETAIL OF REINFORCEMENT IN SLAB

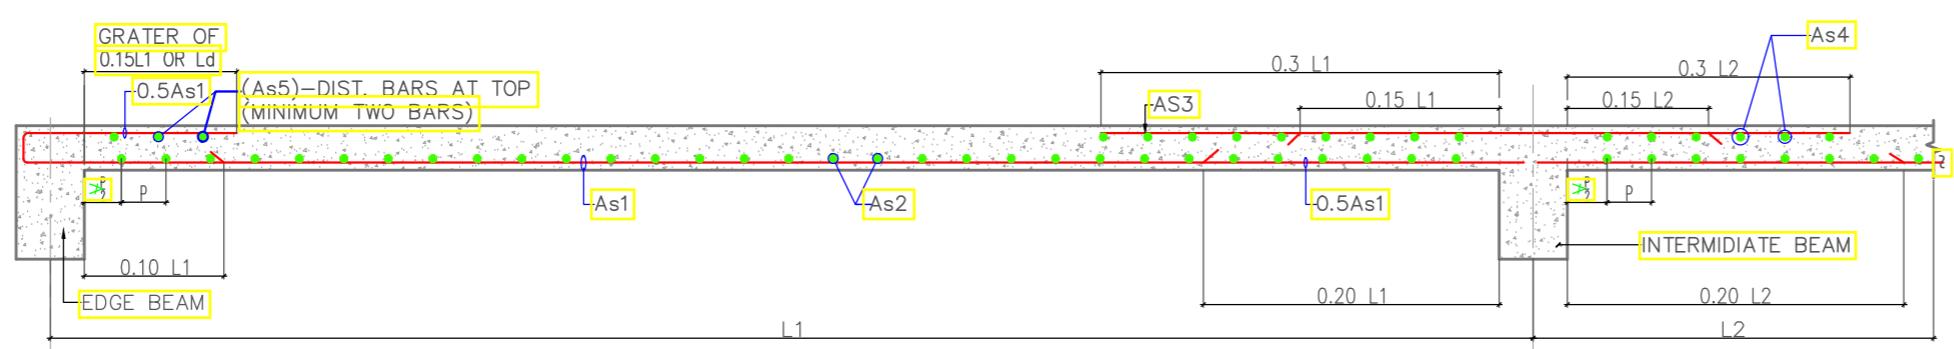
As1 & As2 - BOTTOM REINF.
As3 & As4 - TOP REINF. AT CONTINUOUS EDGE
As5 - TOP REINF. AT DISCONTINUOUS EDGE




DETAILS OF INSPECTION CHAMBER

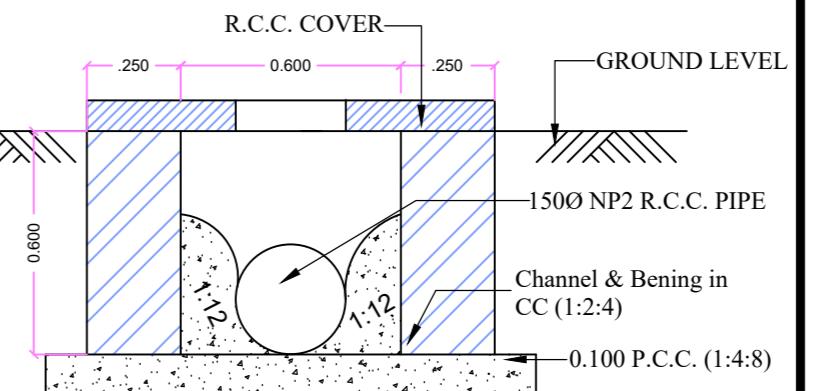


TYP. DETAILS OF LINTEL WITH CHAJJA OVER D & W

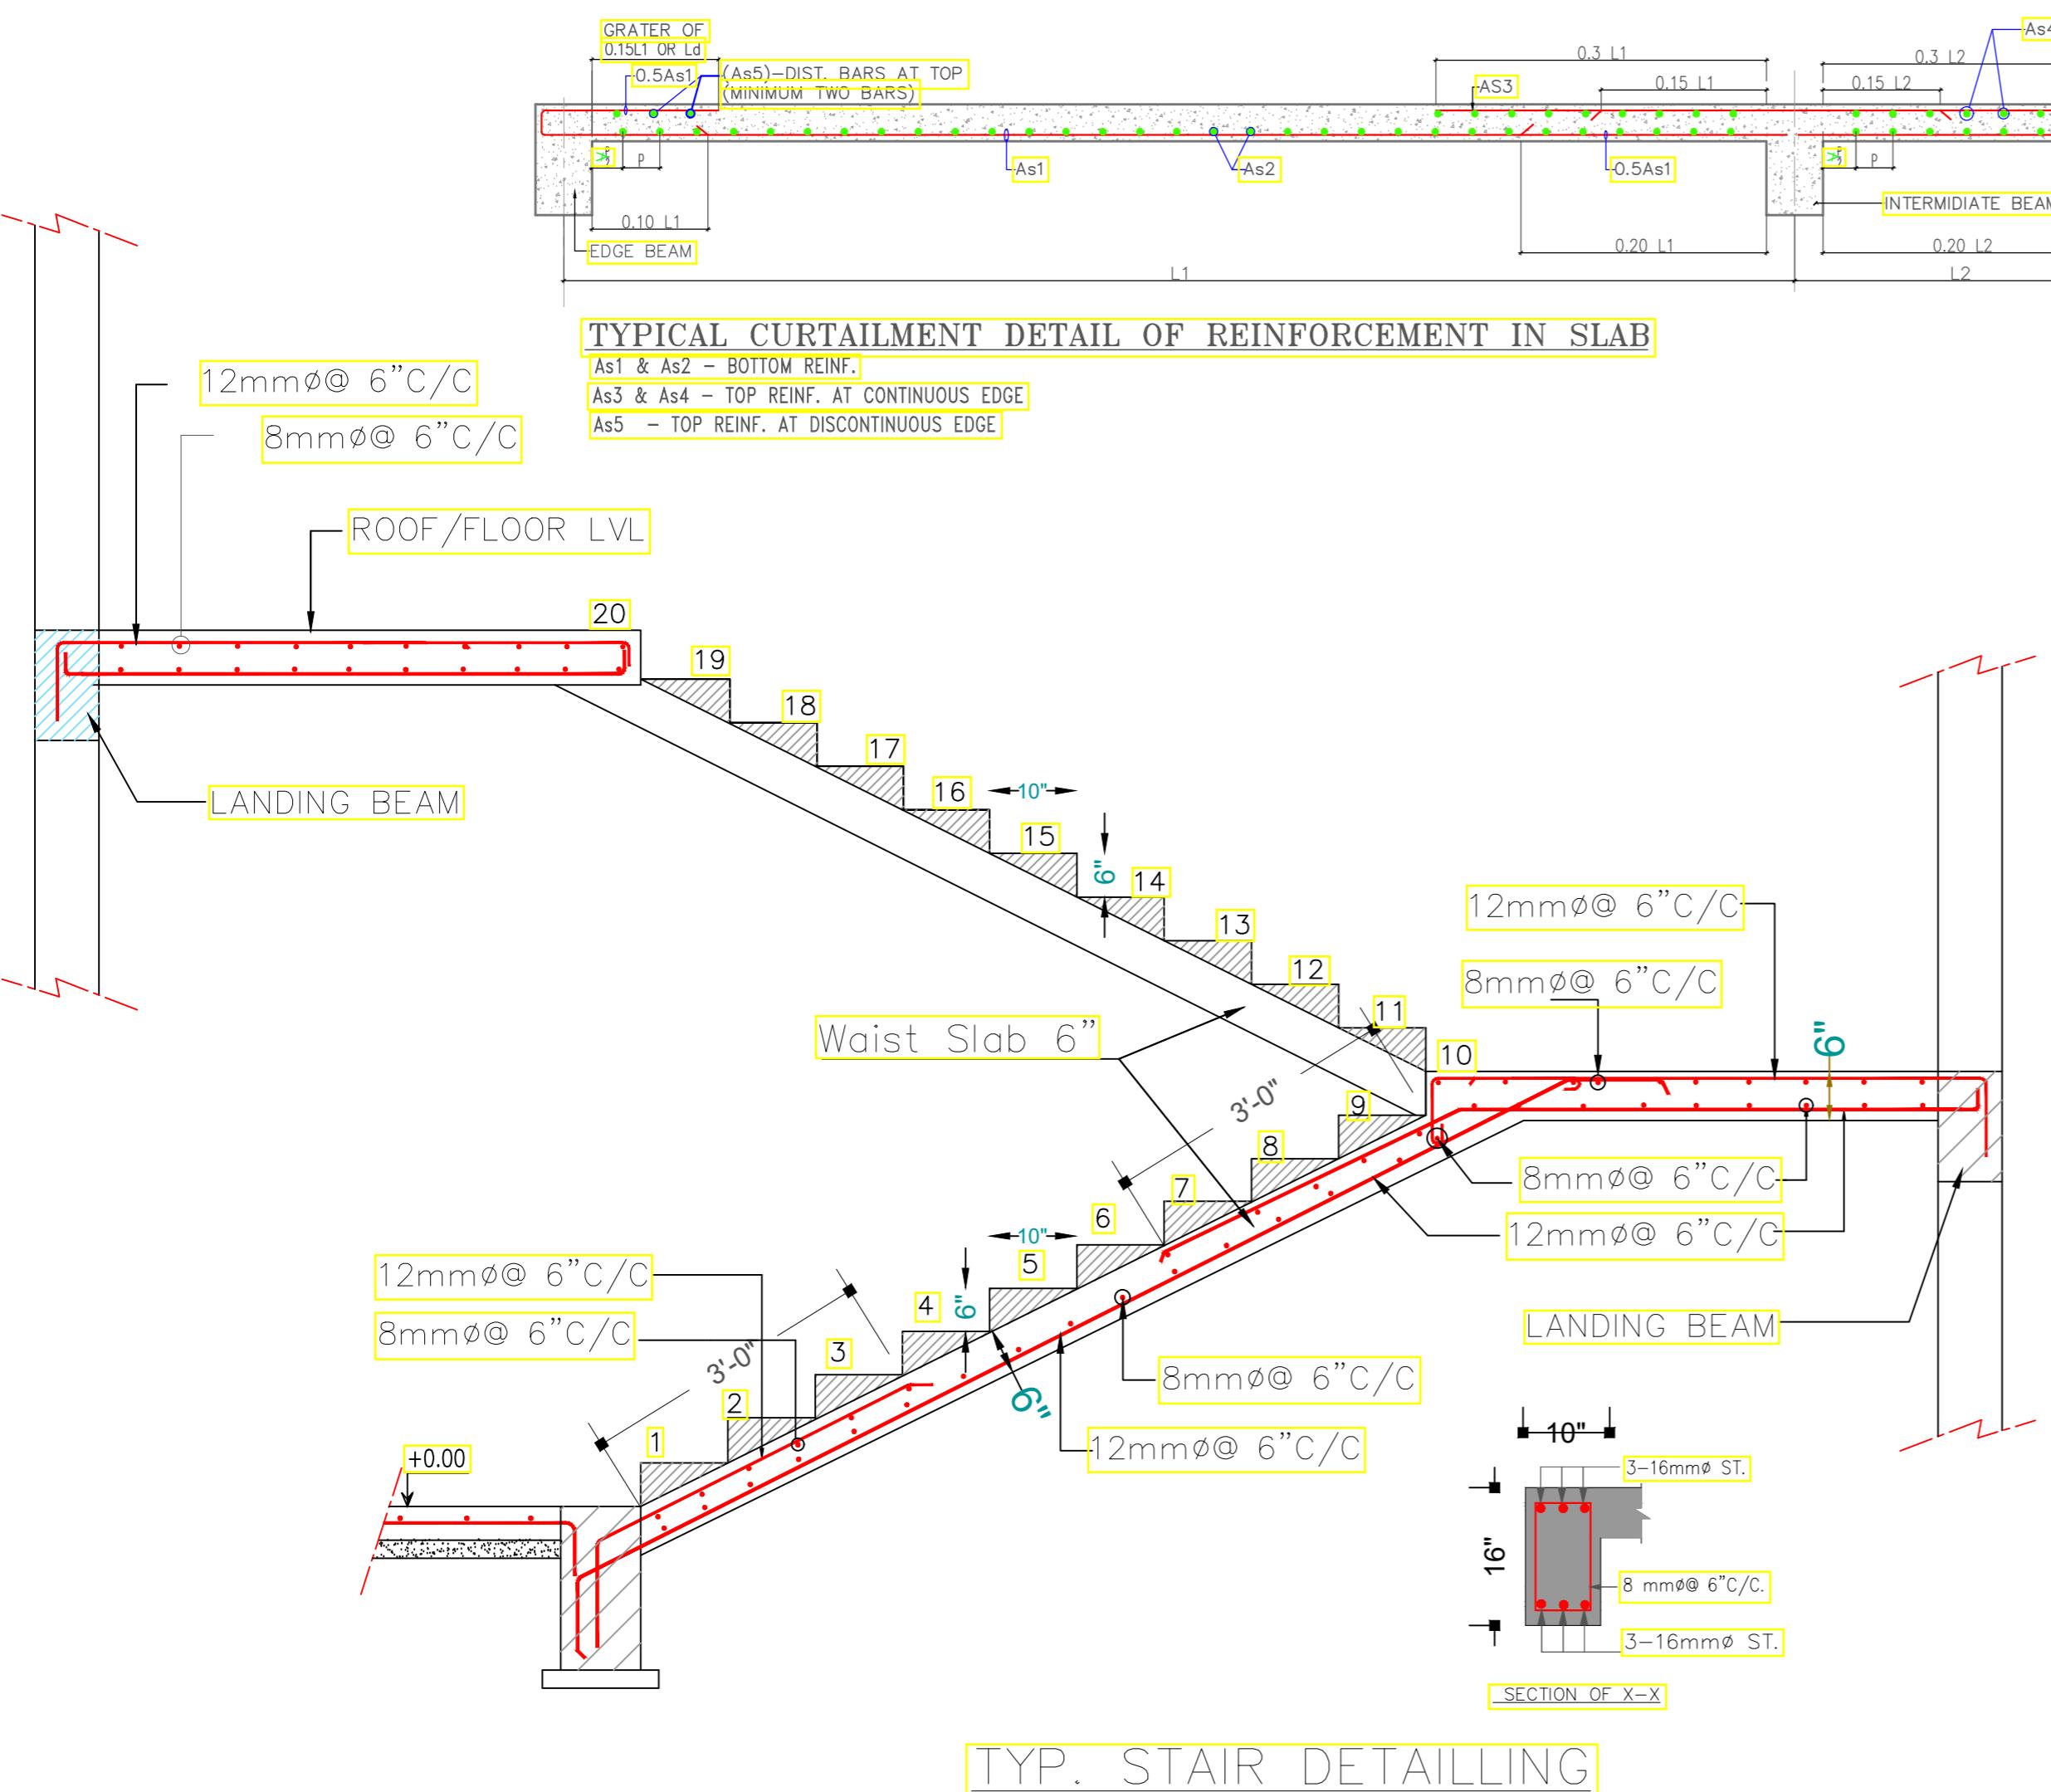

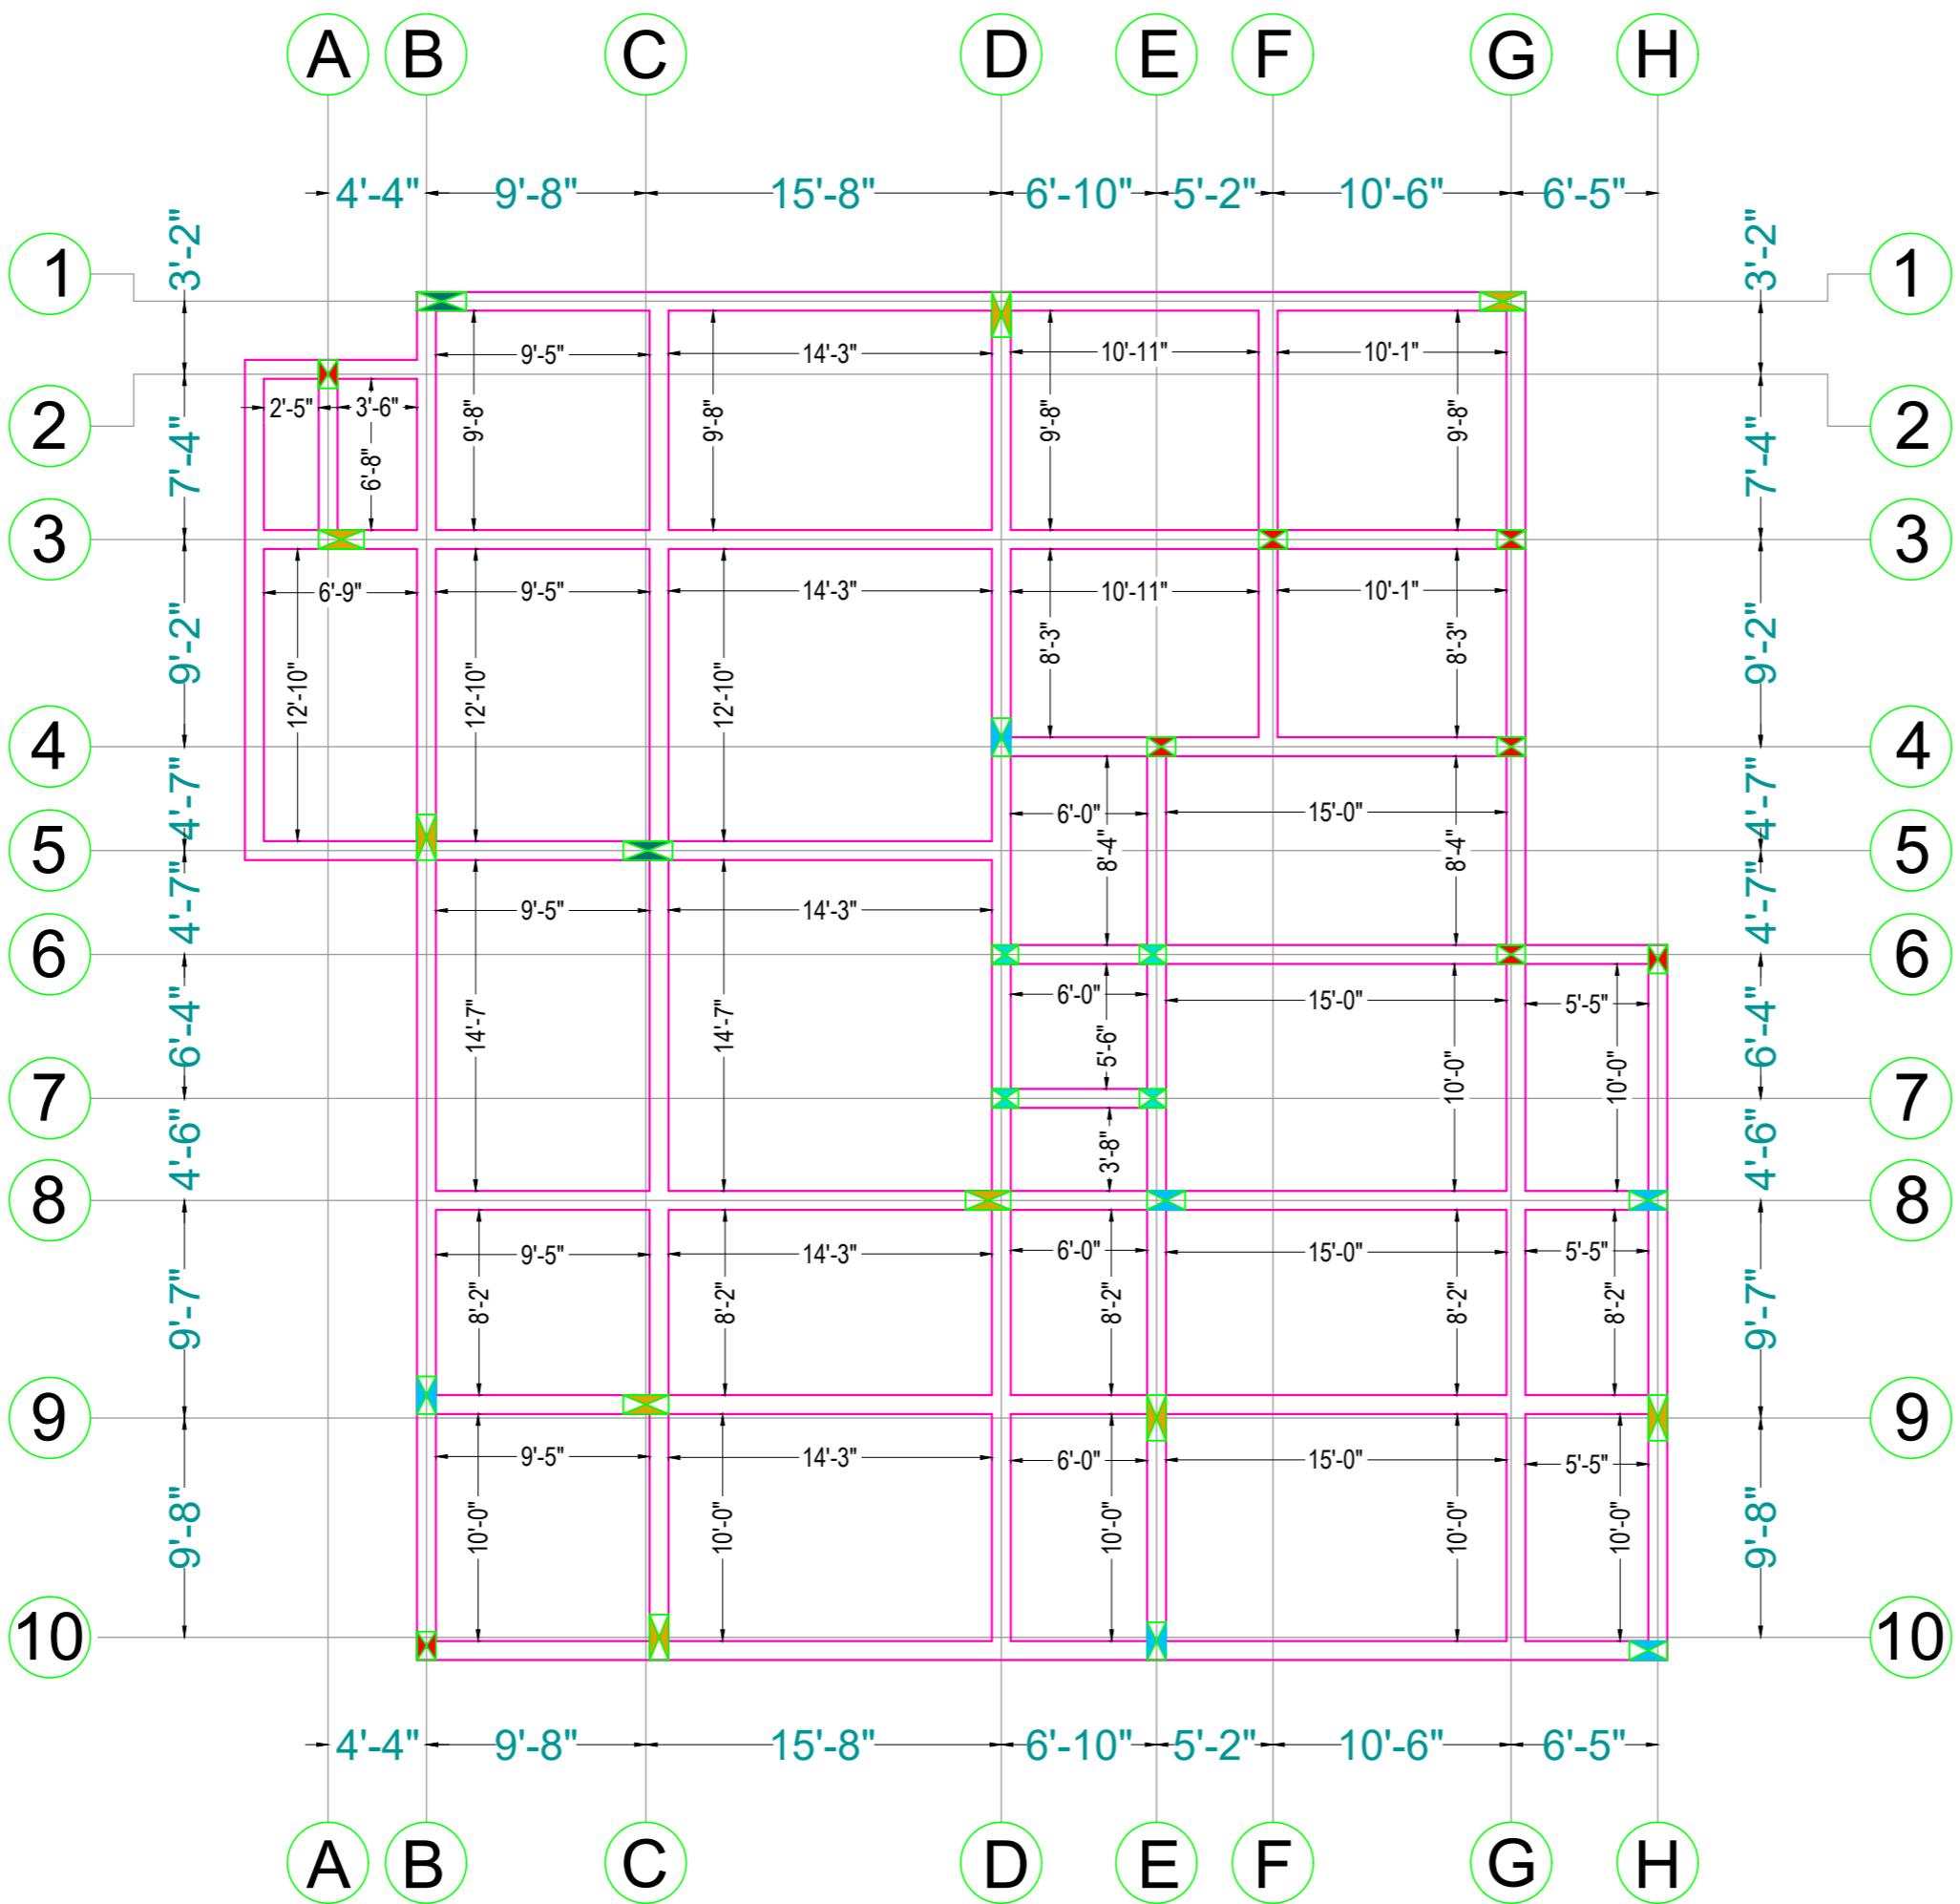


PLINTH BEAM SHUTTERING PLAN


(ALL BEAM SIZE AREA- 10"X16")

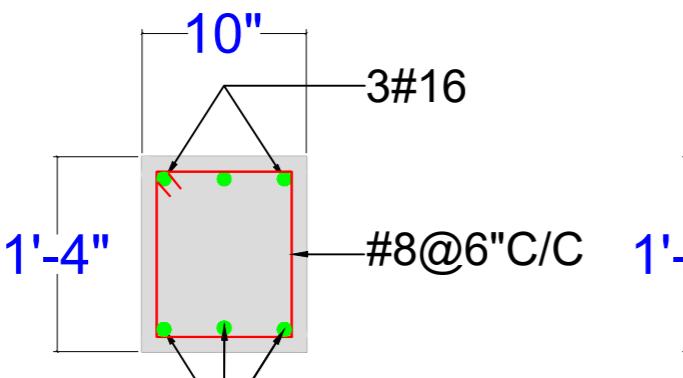

SECTION NEAR SUPPORT

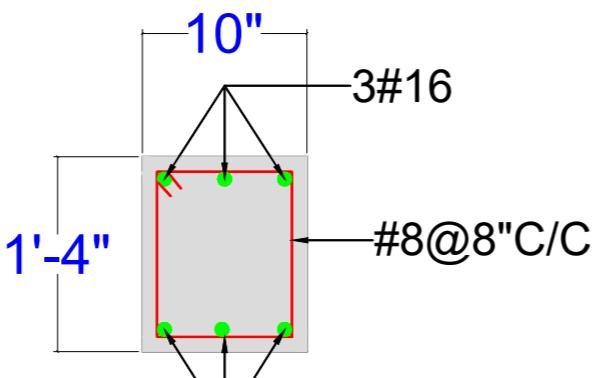


SECTION ON MID

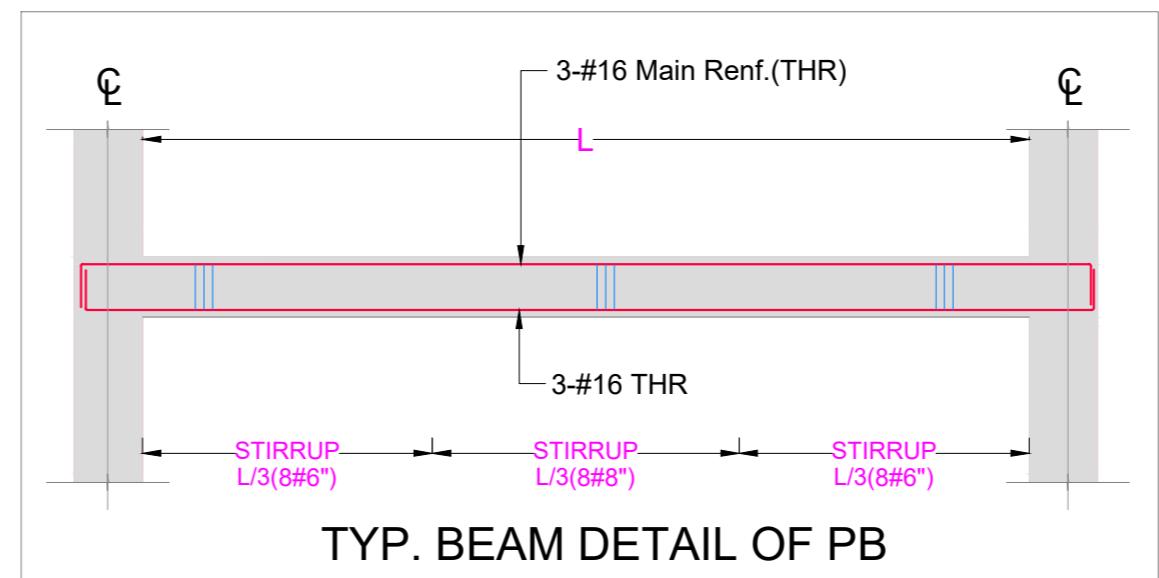

TYP. BEAM DETAIL OF PB

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 - LOAD HAS BEEN TAKEN FOR (G+2) FLOORS ONLY.
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 - FOOTING-50mm, BEAM-25mm, SLAB - 20mm .
 - THE MIX FOR ALL R.C.C. WORK SHALL BE M-20 (1:1.5:3).
 - ALL THE REINFORCEMENT SHALL BE Fe-500(HYSB BARS).
 - MINIMUM DEVELOPMENT LENGTH FOR TOR STEEL SHALL BE 50d, WHERE "d" IS DIA OF MAIN REINFORCEMENT.
 - THE LAP SHALL BE STAGGERED AND AVOIDED AT THE POINT OF MAXIMUM BENDING MOMENT .
 - ALL DIMENSION & LEVEL ARE IN FEET-INCH.

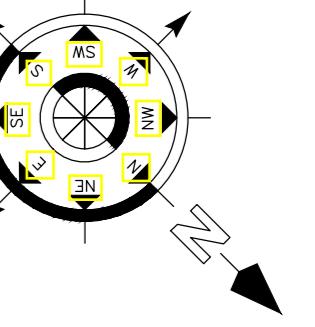SIGNATURE :-

DRAWN:-	AR. DHANESHWARI
DESIGN:-	ER. PABITRA

PROJECT TITLE:-

K.I.P SOUMYA

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SCALE	NTS
DWG NO:	16


DRAWING TITLE:-

PLINTH BEAM SHUTTERING PLAN



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STILT FLOOR ROOF BEAM SHUTTERING PLAN

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- THE LAP SHALL BE STAGGERED AND AVOIDED AT THE POINT OF MAXIMUM BENDING MOMENT .
- ALL DIMENSION & LEVEL ARE IN FEET-INCH.

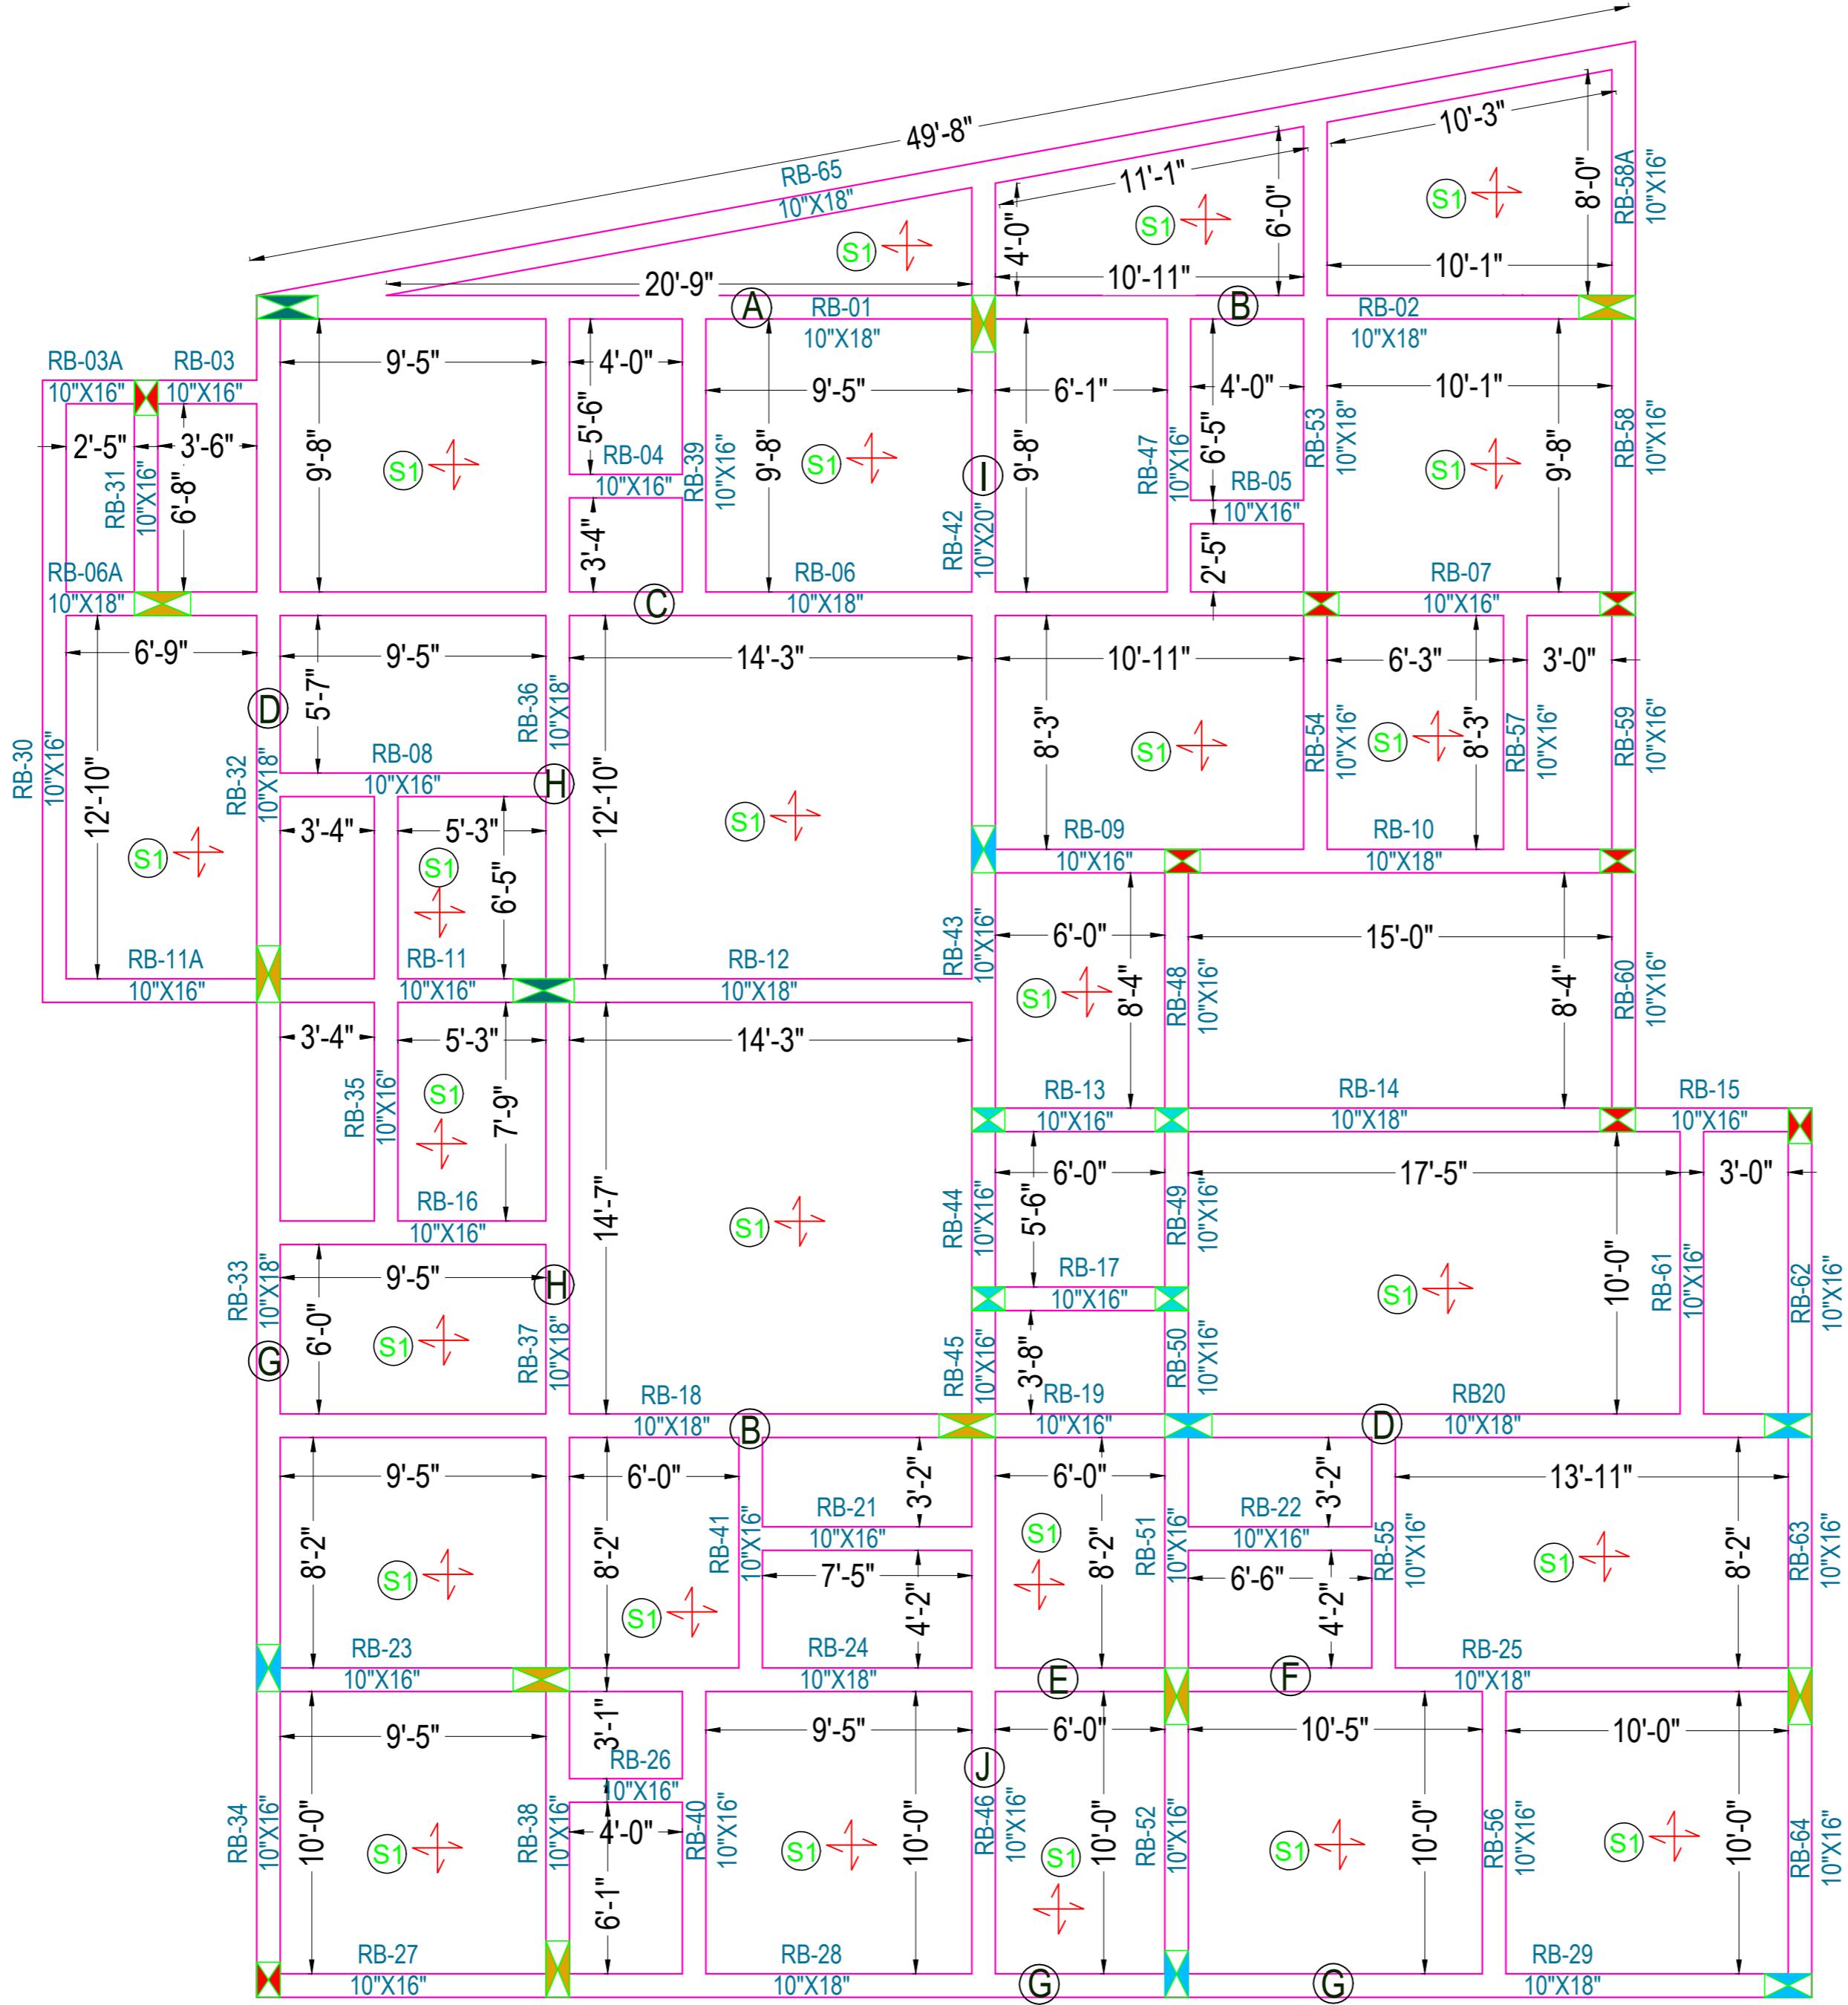SIGNATURE :-

DRAWN:- AR. DHANESHWARI

DESIGN:- ER. PABITRA

PROJECT TITLE:-

K.I.P SOUMYA

STATUS:

ISSUED FOR CONSTRUCTION

DATE:	04-05-2022
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SCALE	NTS
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DWG NO:	17
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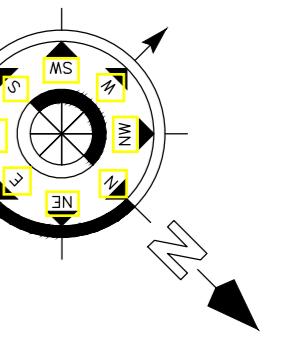
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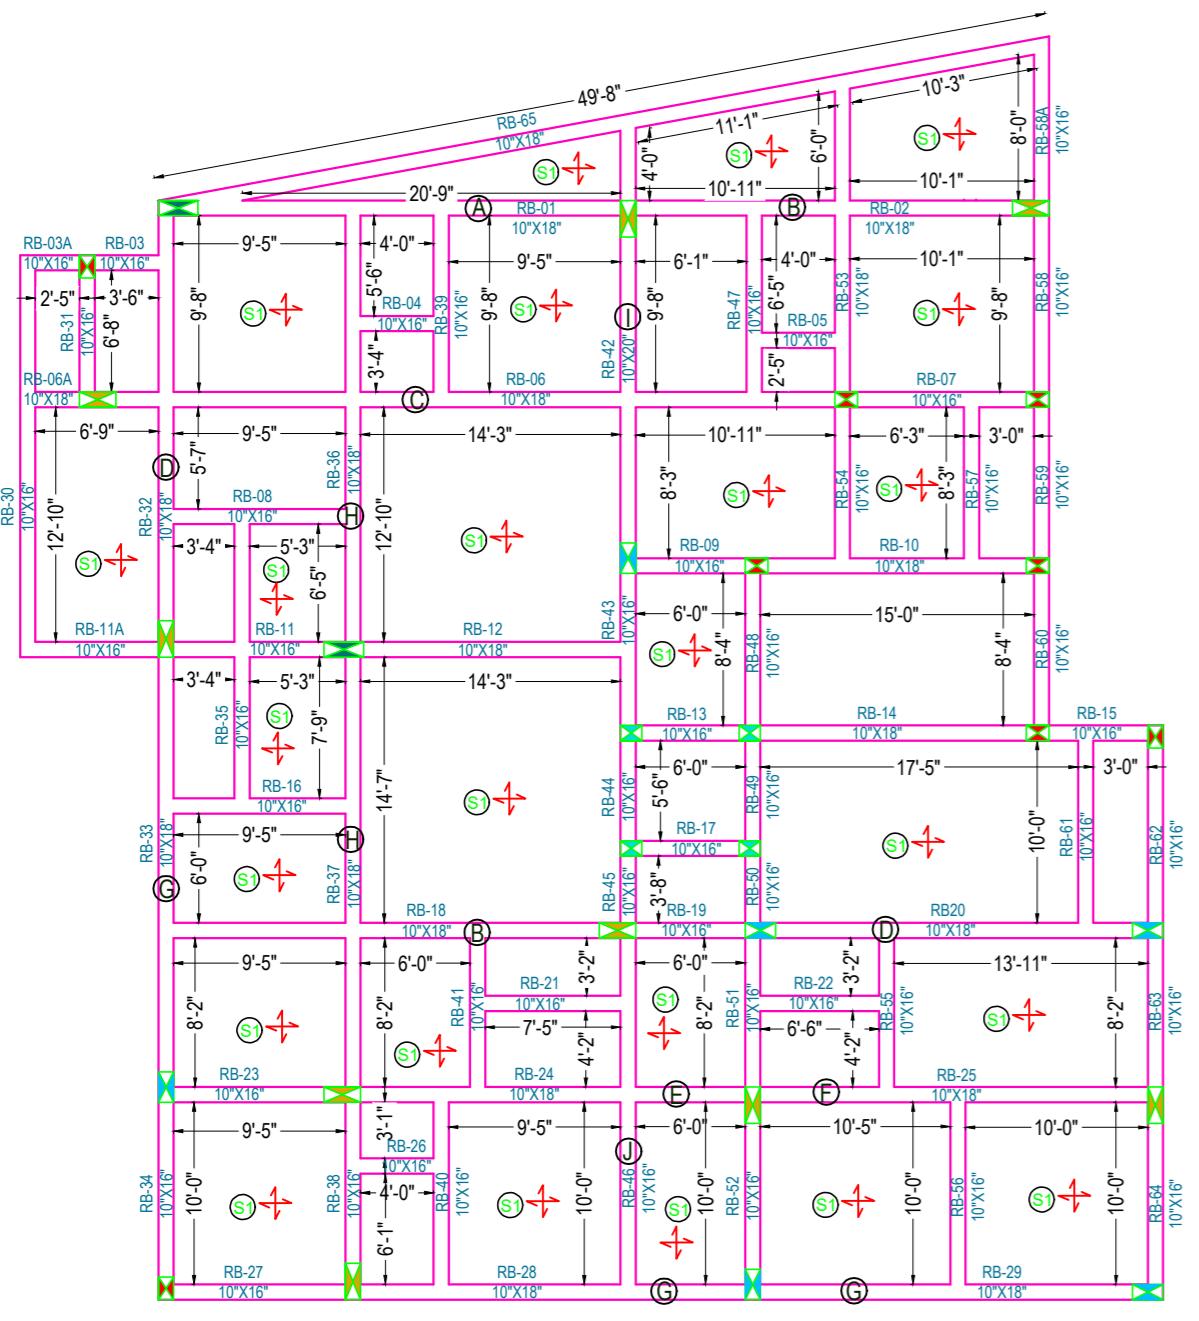
**STILT FLOOR
ROOF BEAM
SHUTTERING PLAN**




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(Signature Placeholder)







STILT FLOOR ROOF BEAM SHUTTERING PLAN

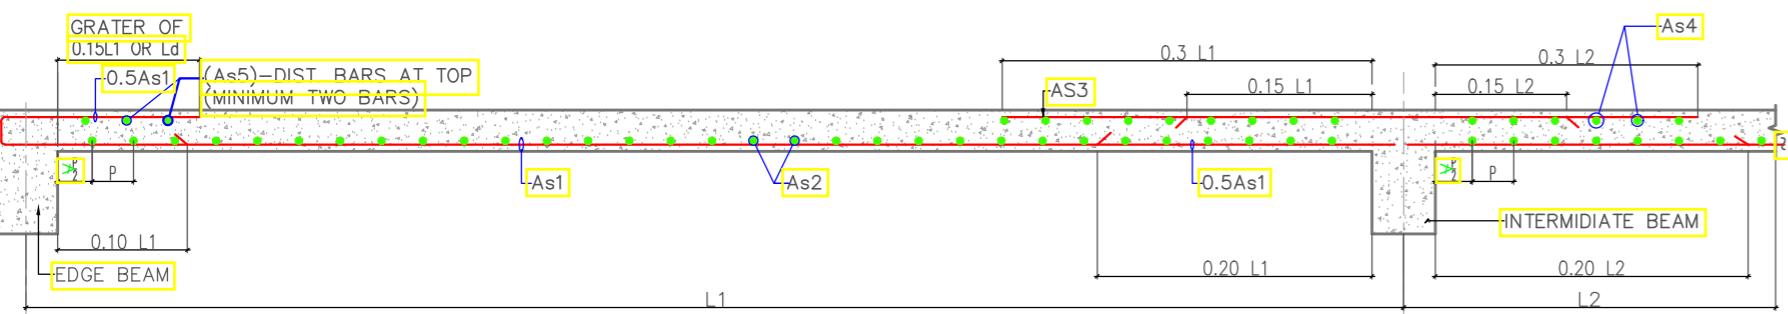

TYPICAL CURTAILMENT DETAIL OF REINFORCEMENT IN SLAB

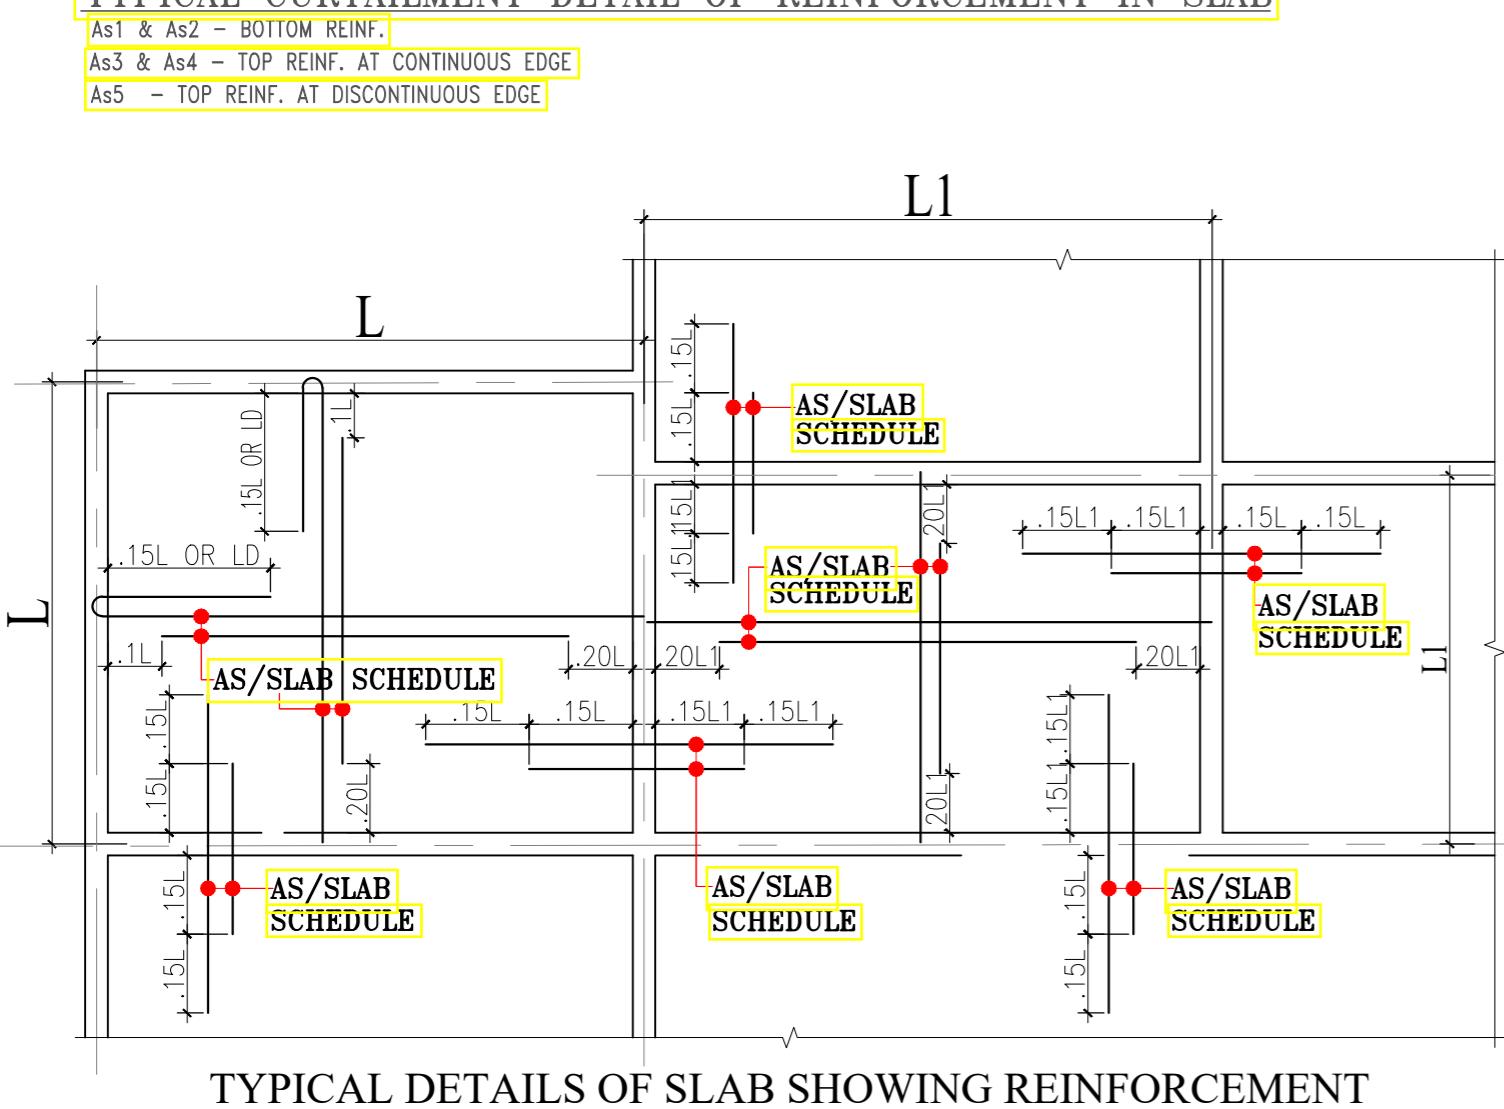


TYPICAL DETAILS OF SLAB SHOWING REINFORCEMENT

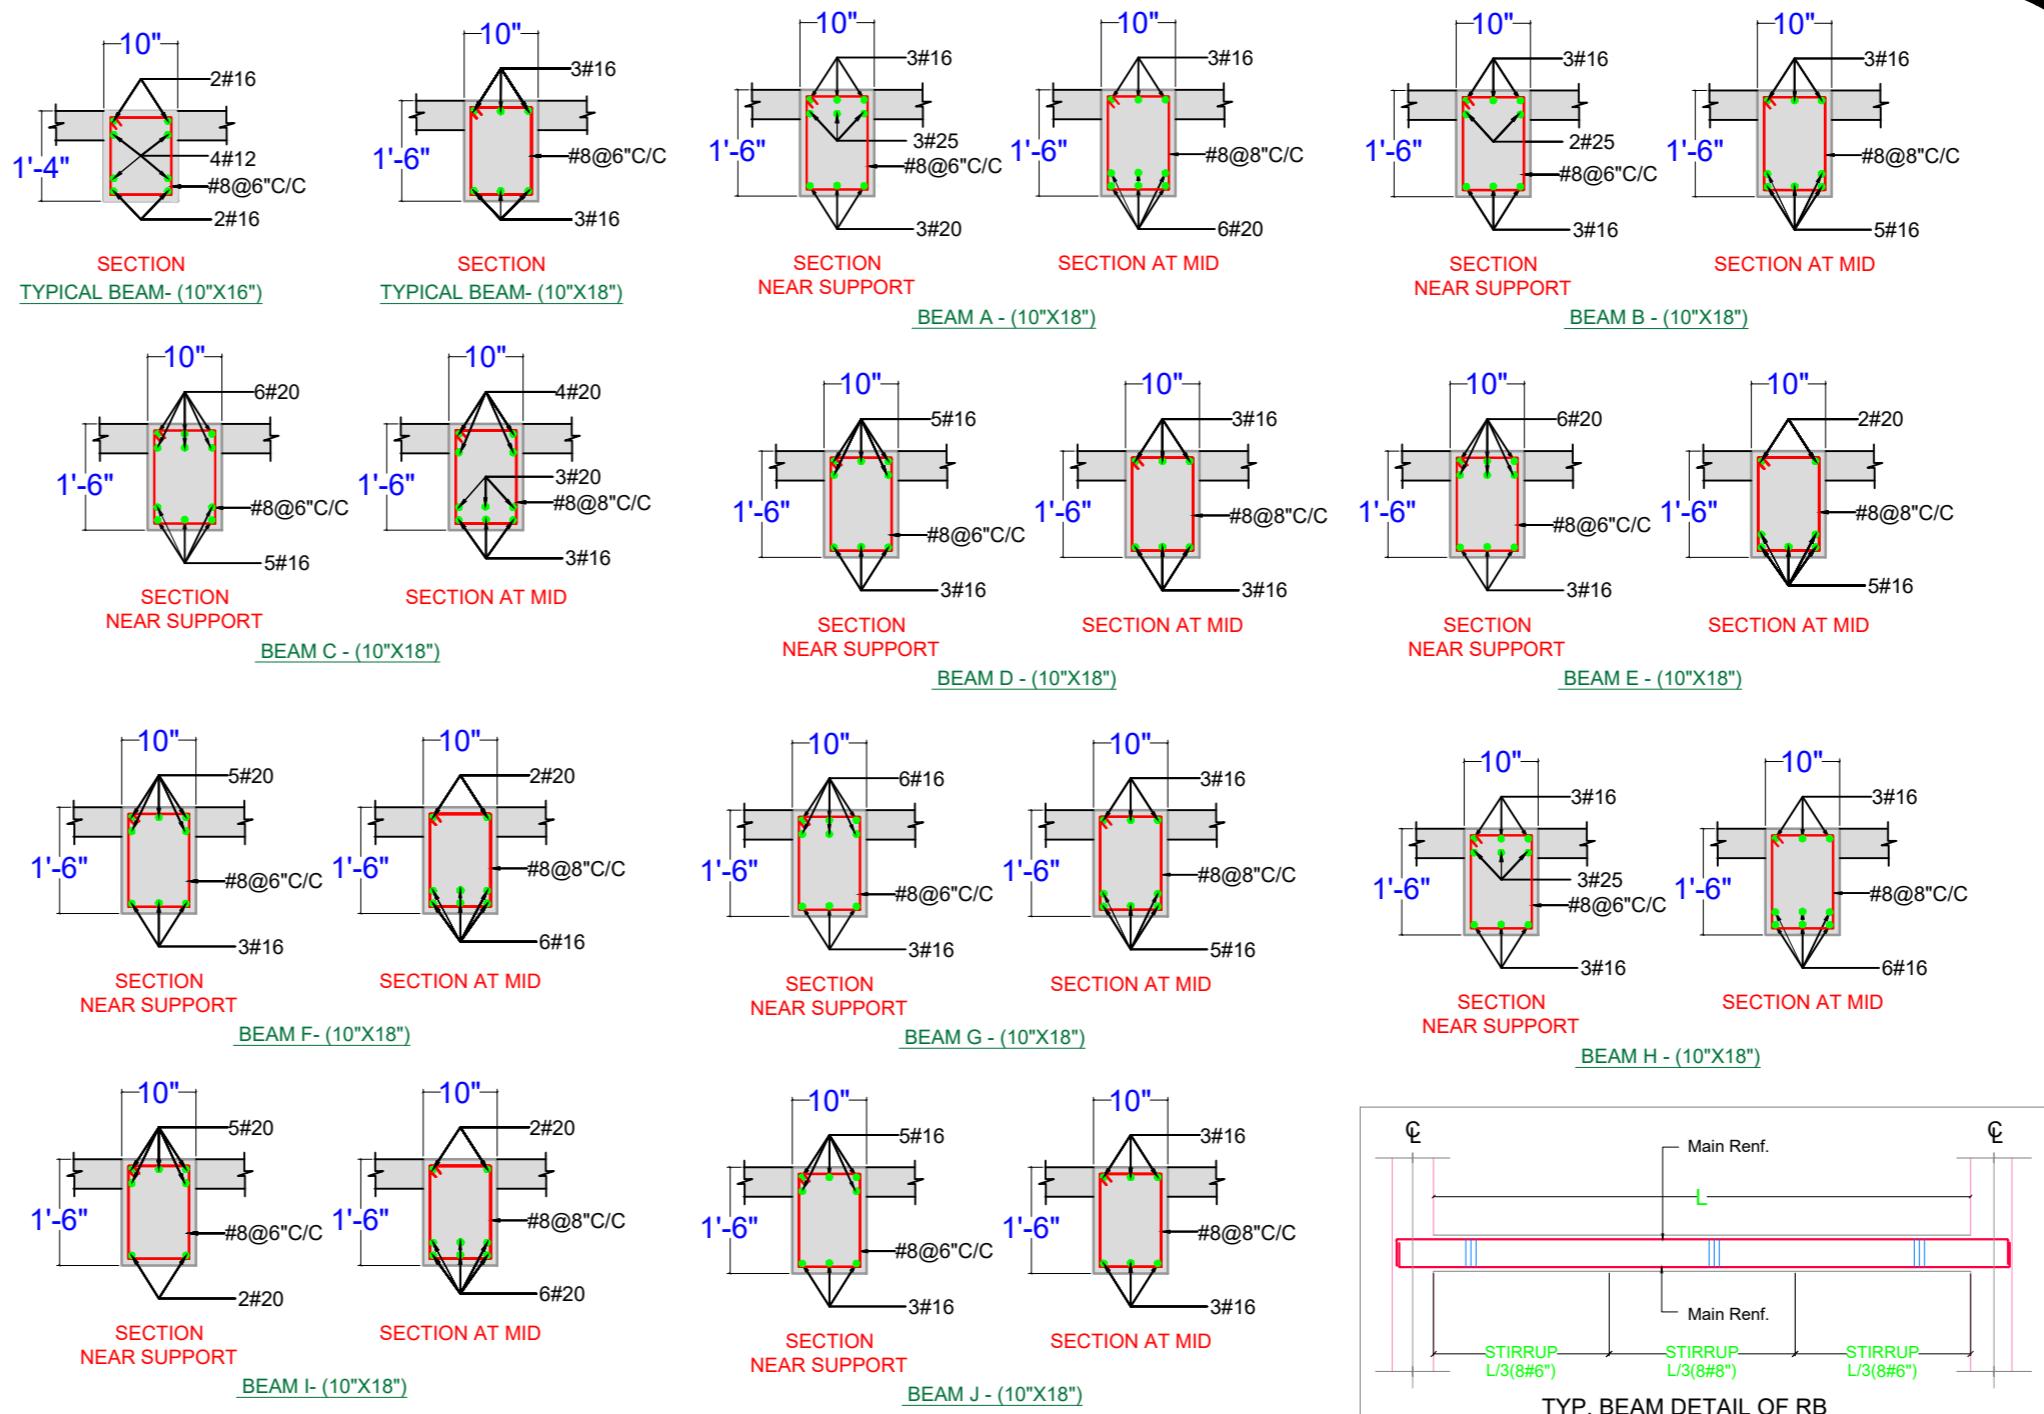


CONC. MIX. SHALL BE M-25 FOR SLAB


SLAB NO.	DEPTH	REINFORCEMENT			
		SPAN(As1/As2)		SUPPORT(As3/As4/As5)	
		SHORTER SPAN	LONGER SPAN	SHORTER SPAN	LONGER SPAN
S1	5"	T8@6°C/C	T8@6°C/C	T8@6°C/C	T8@6°C/C

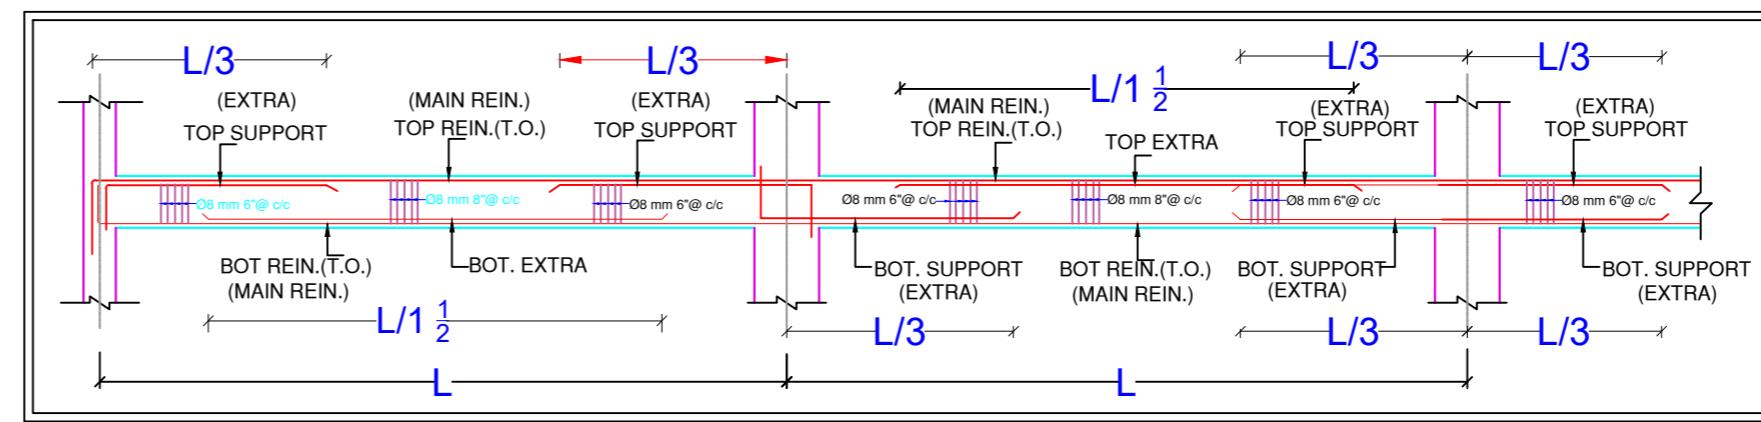

ARRANGEMENT OF REINFORCEMENT IN A BEAM

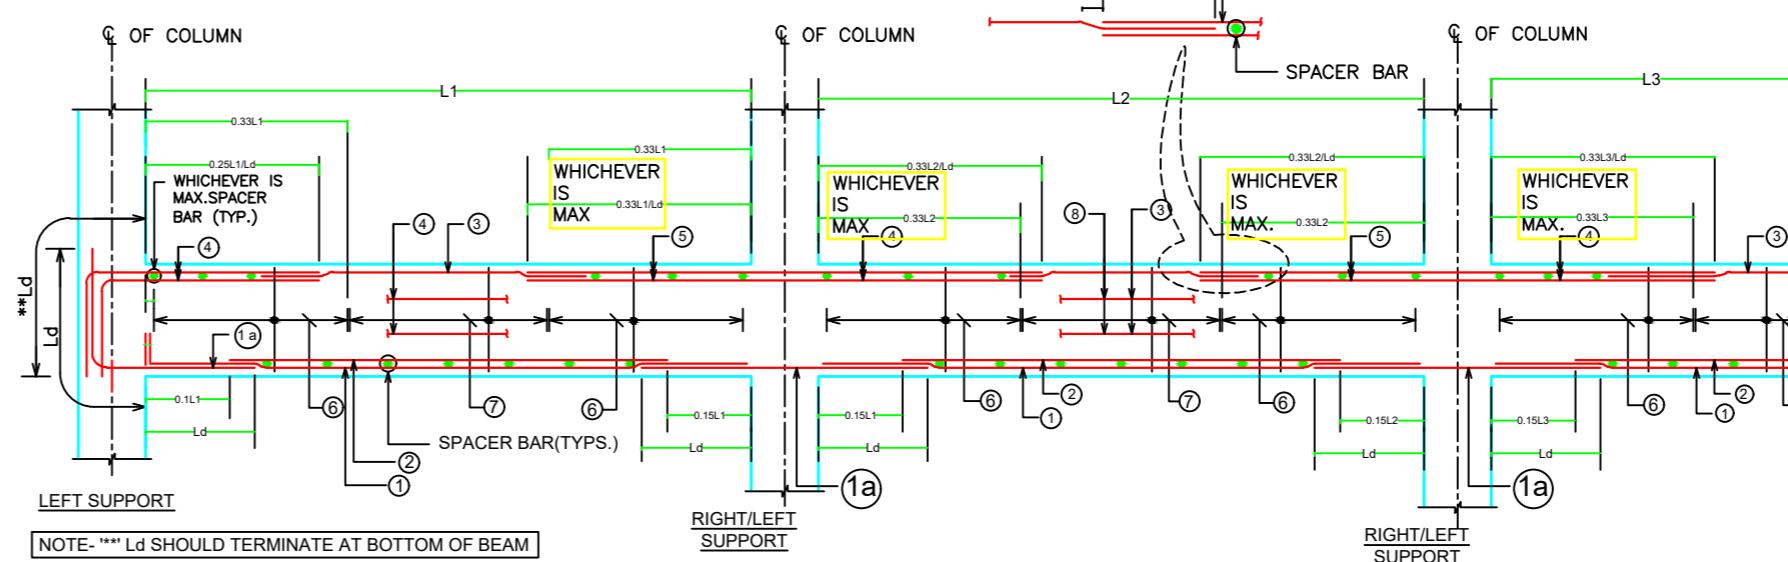

TYPICAL DETAILS OF CONTINUOUS BEAM

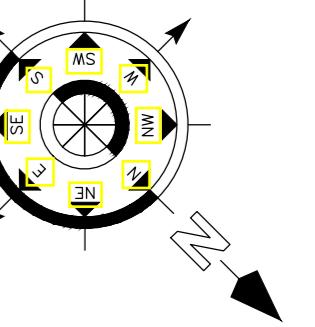

Note:

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- ALL THE REINFORCEMENT SHALL BE F-500(HYD BARS).
- MINIMUM DEVELOPMENT LENGTH FOR TOR STEEL SHALL BE 50d, WHERE "d" IS DIA OF MAIN REINFORCEMENT.
- THE LAP SHALL BE STAGGERED AND AVOIDED AT THE POINT OF MAXIMUM BENDING MOMENT.
- ALL DIMENSION & LEVEL ARE IN FEET-INCH.

SIGNATURE :-

DRAWN:- AR. DHANESHWARI

DESIGN:- ER. PABITRA

PROJECT TITLE:-

K.I.P SOUMYA

STATUS:

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DATE: 04-05-2022

SCALE NTS

DWG NO: 18


DRAWING TITLE:-

**STILT ROOF BEAM
SHUTTERING PLAN**




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FIRST FLOOR ROOF BEAM SHUTTERING PLAN

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DRAWN:- AR. DHANESHWARI

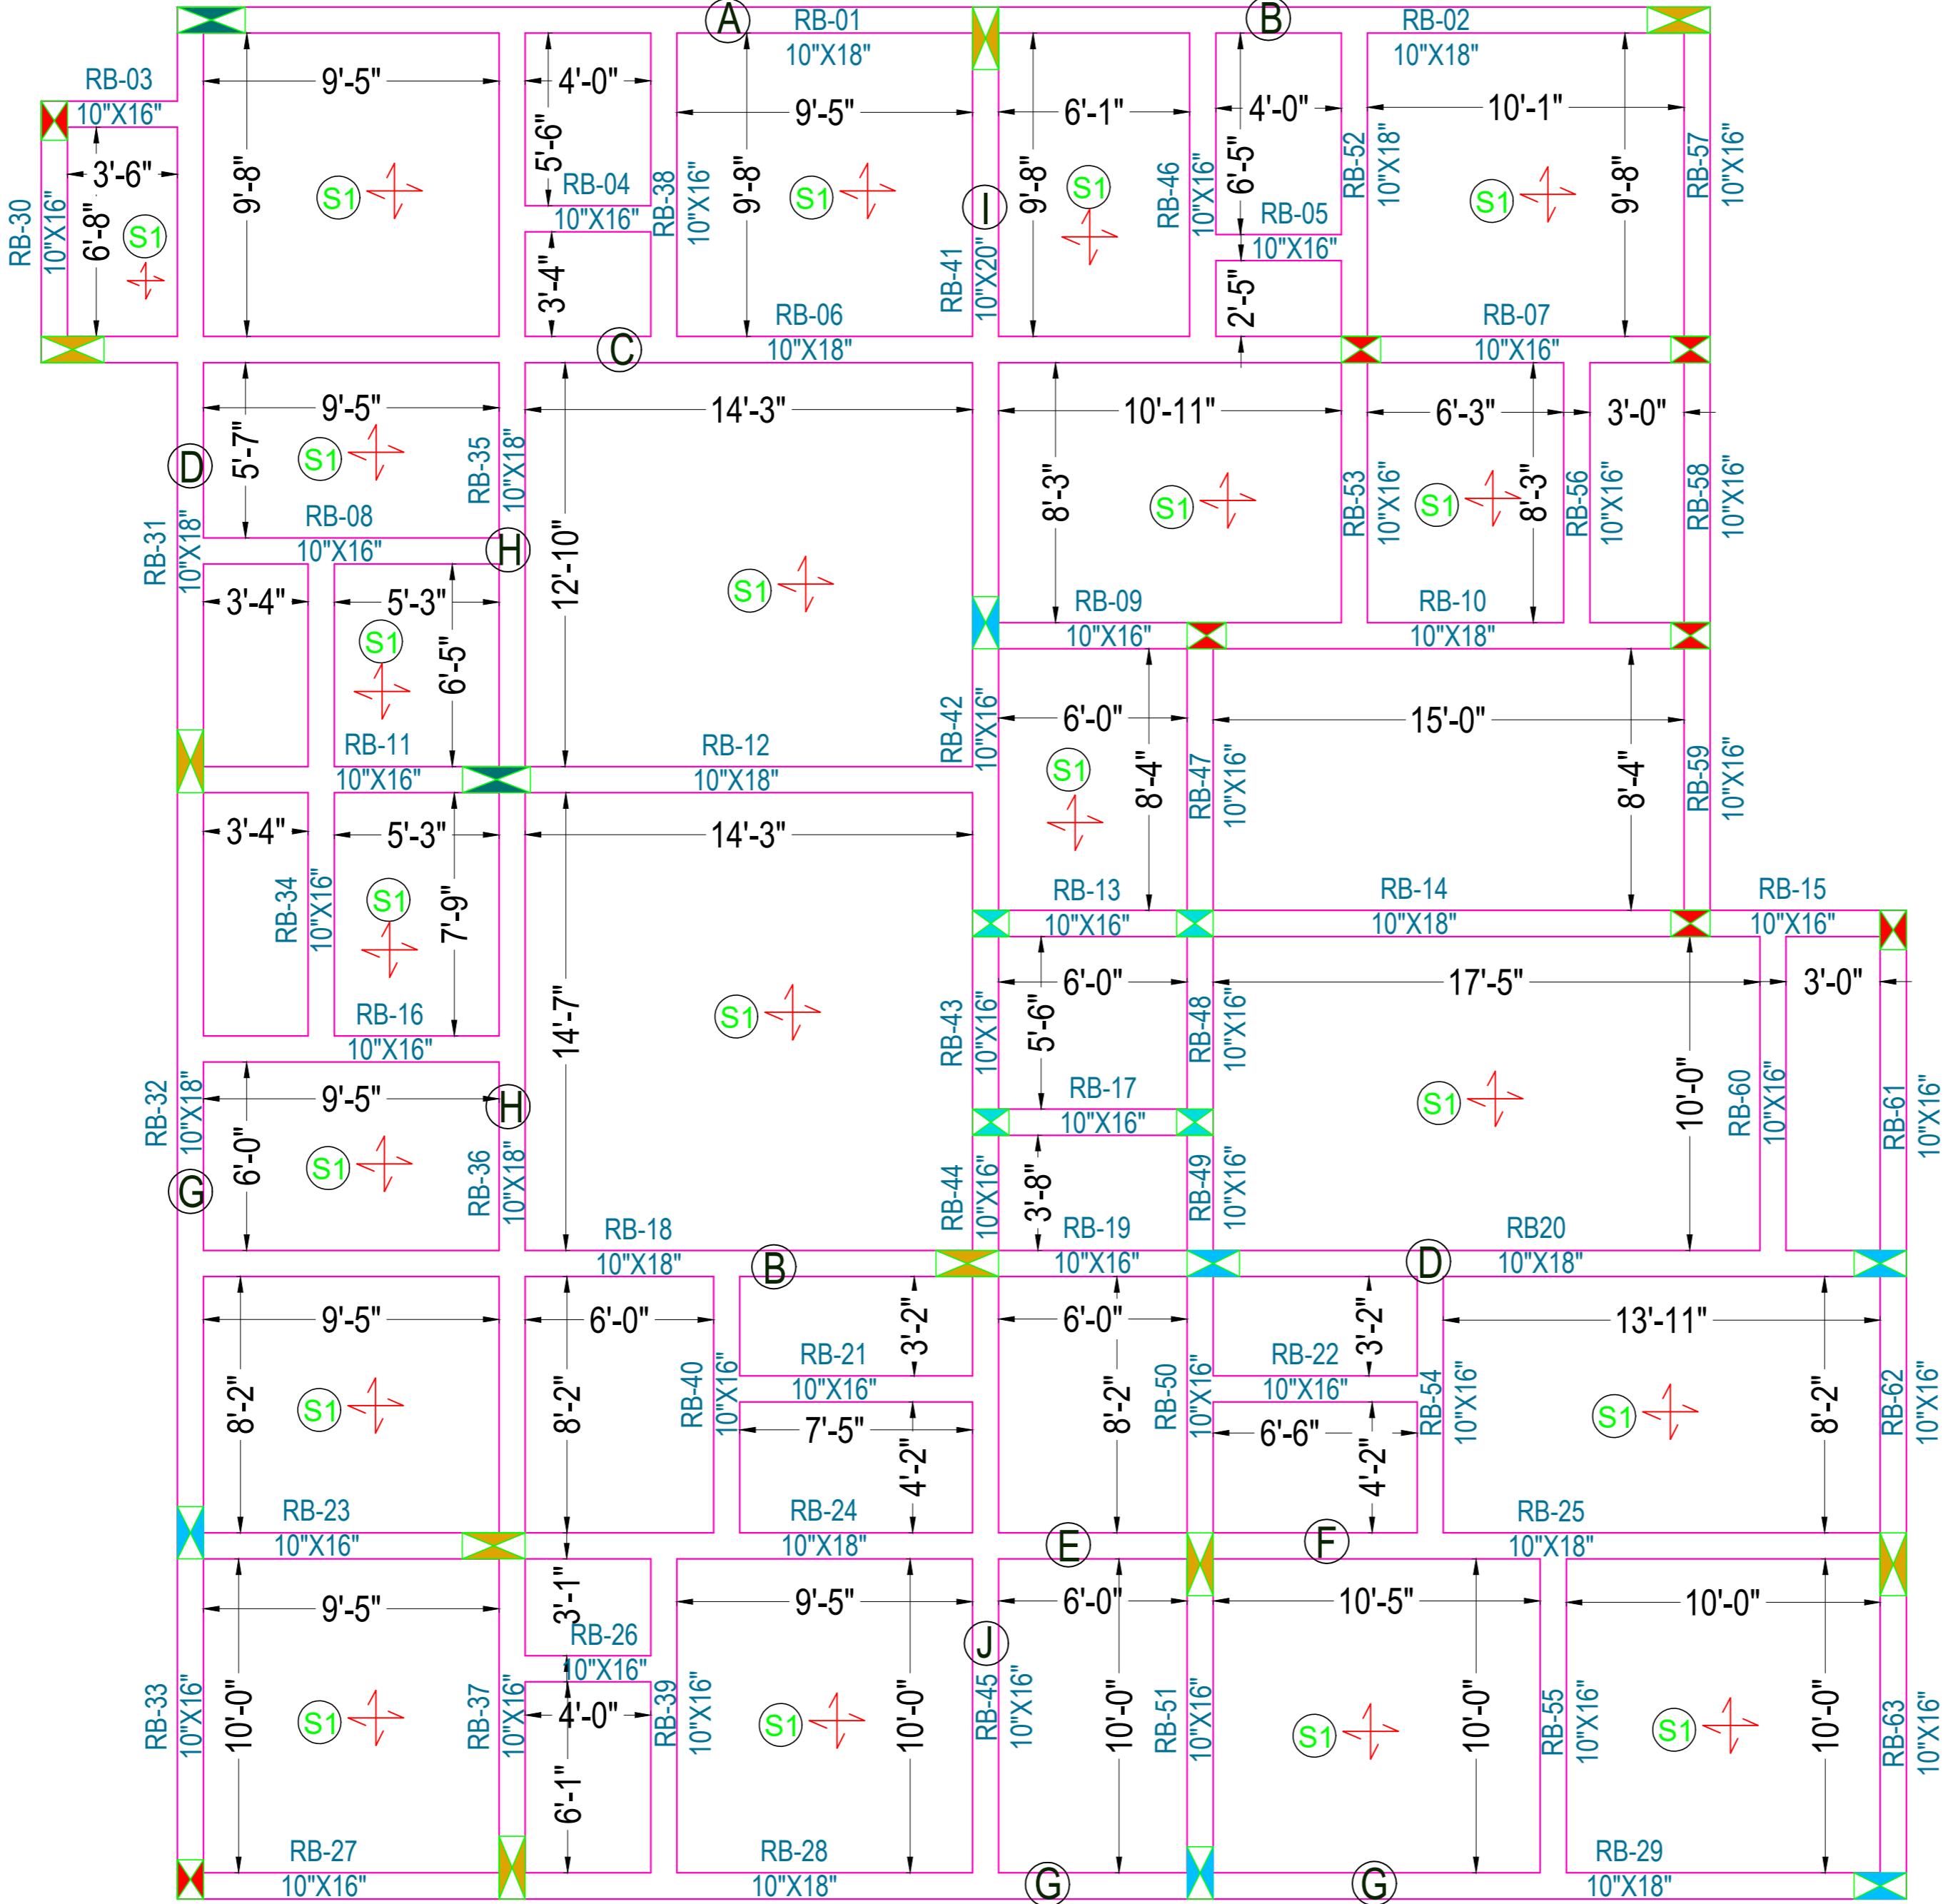DESIGN:- ER. PABITRA

PROJECT TITLE:-

K.I.P SOUMYA

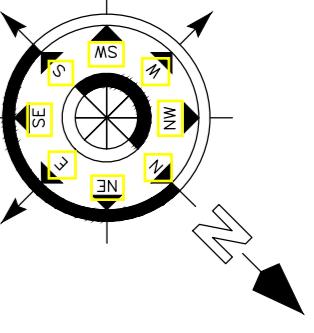STATUS:

ISSUED FOR CONSTRUCTION

DATE: 04-05-2022

SCALE: NTS

DWG NO: 19


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**FIRST FLOOR
ROOF BEAM
SHUTTERING PLAN**




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FIRST FLOOR ROOF BEAM SHUTTERING PLAN




TYPICAL CURTAILMENT DETAIL OF REINFORCEMENT IN SLAB

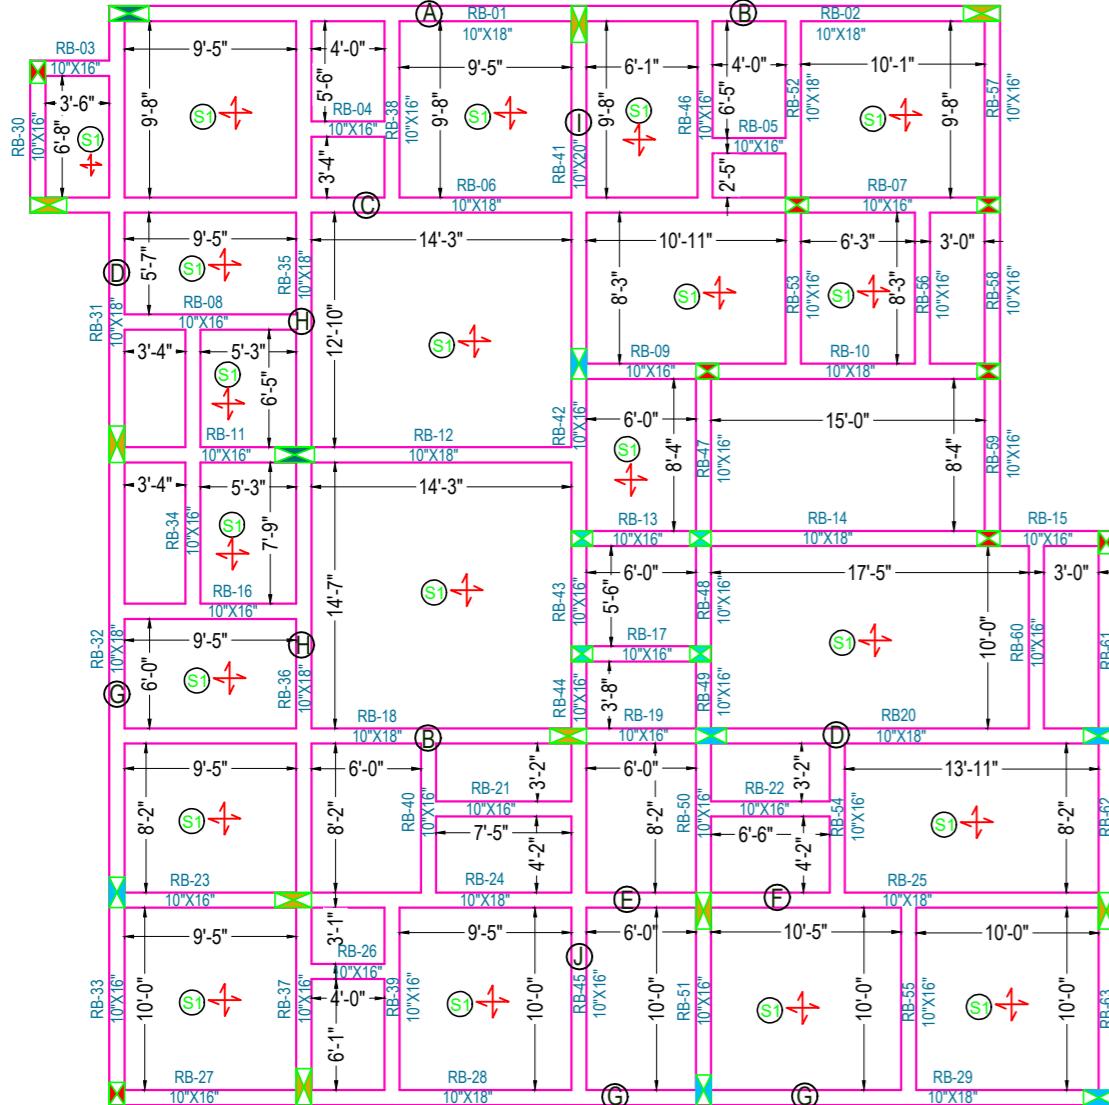
As1 & As2 - BOTTOM REINF.

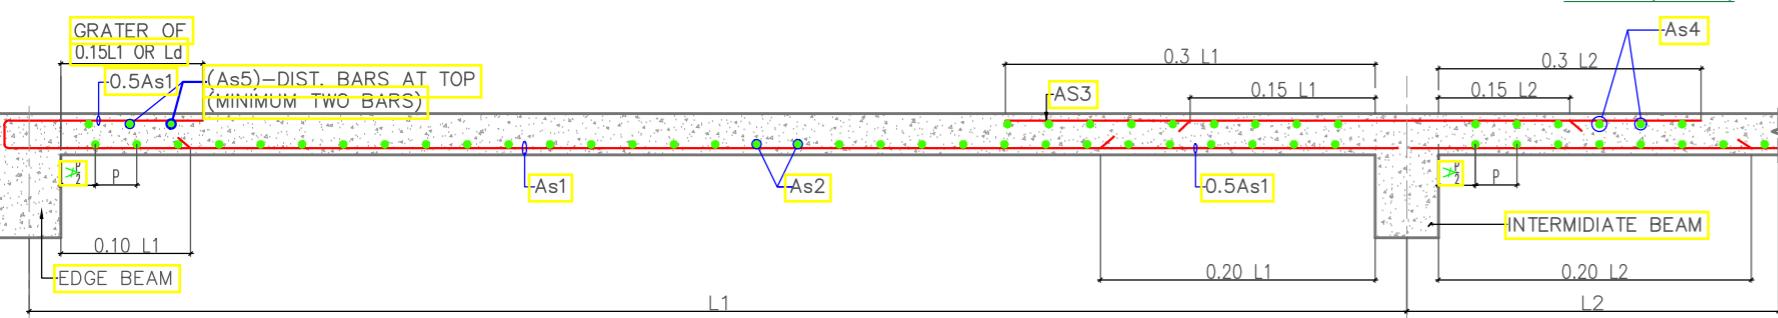As3 & As4 - TOP REINF. AT CONTINUOUS EDGE


As5 - TOP REINF. AT DISCONTINUOUS EDGE

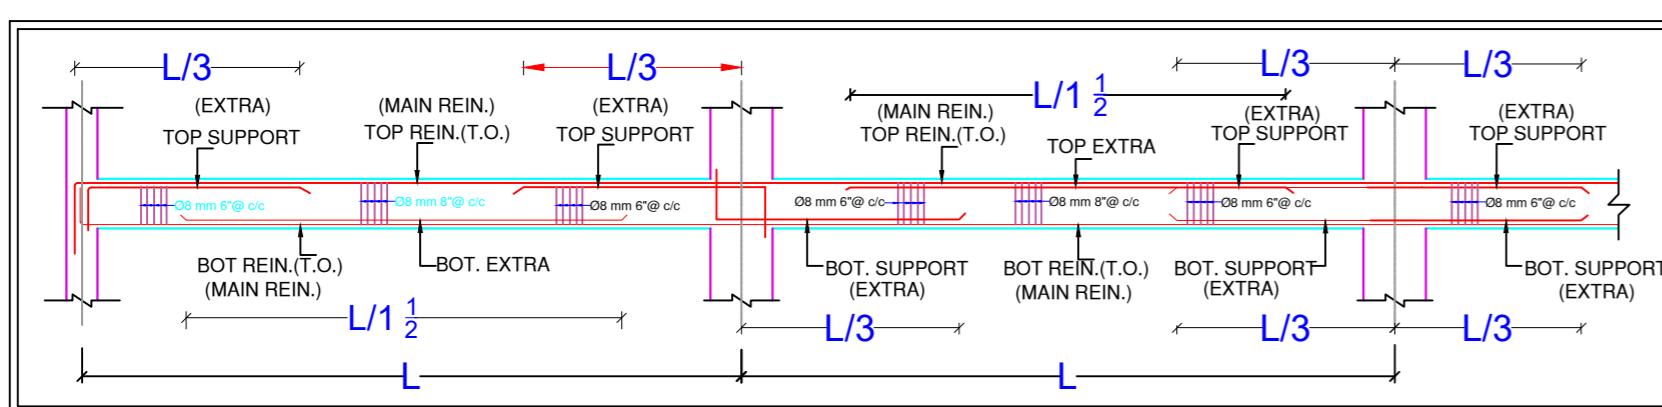

ARRANGEMENT OF REINFORCEMENT IN A BEAM

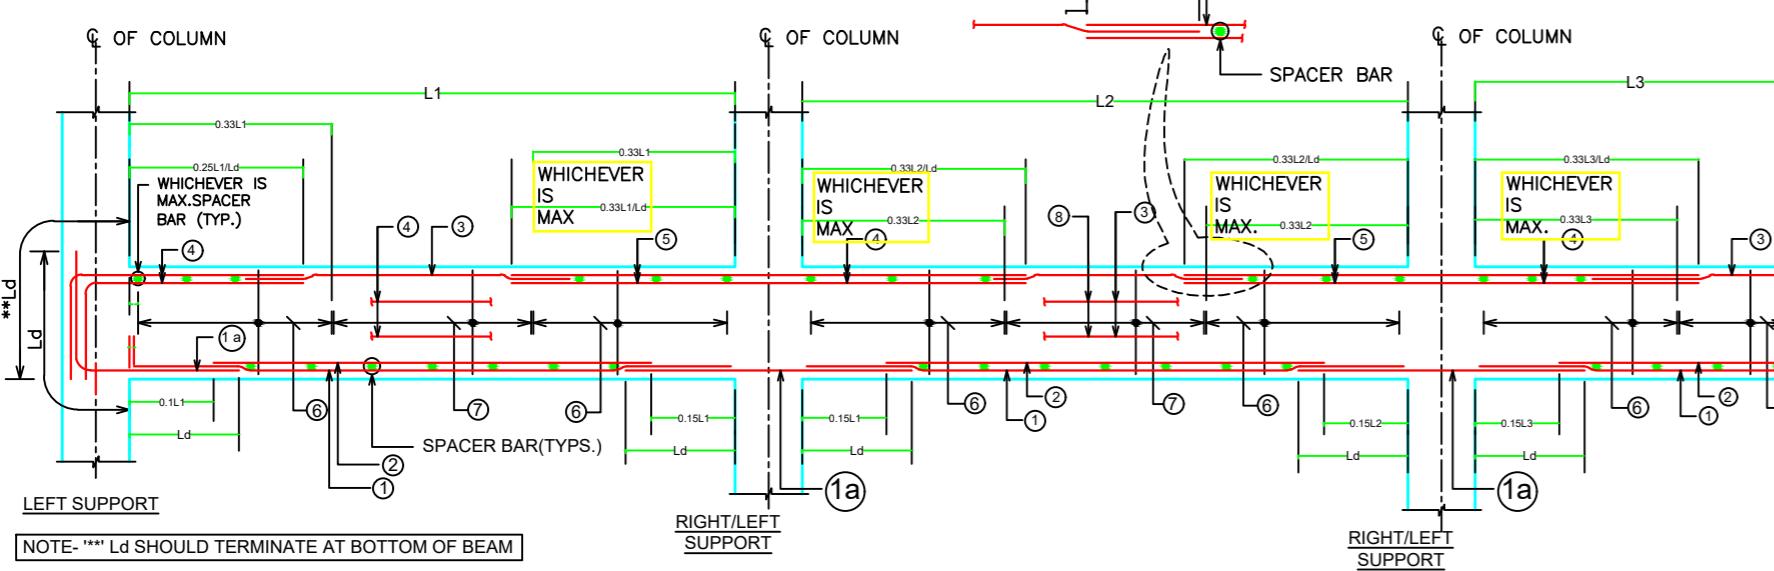


TYPICAL DETAILS OF CONTINUOUS BEAM

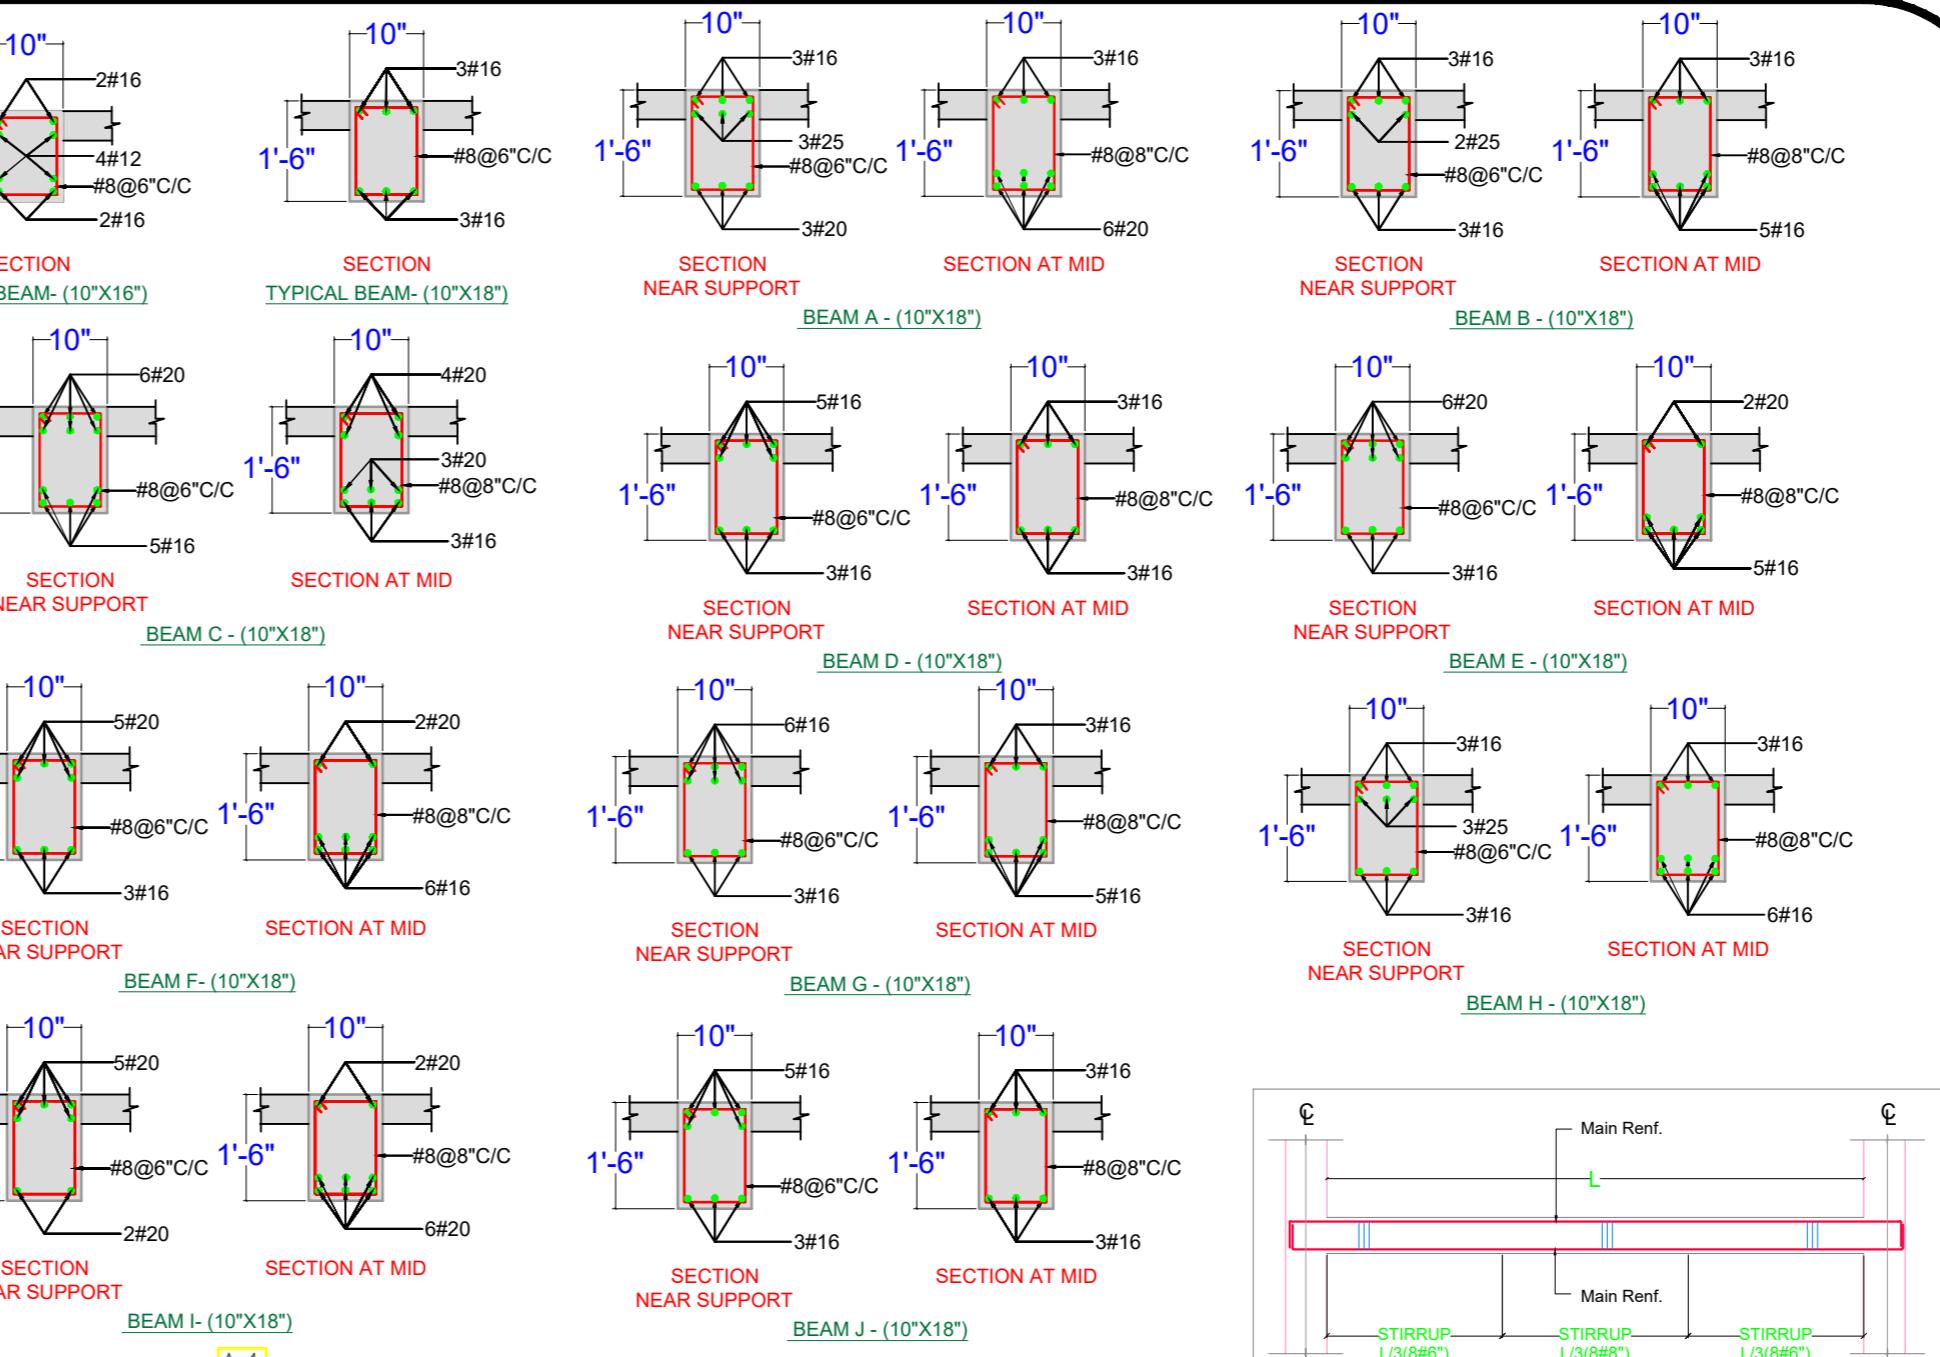


CONC. MIX. SHALL BE M-25 FOR SLAB

SLAB NO.	DEPTH	REINFORCEMENT			
		SPAN(As1/As2)		SUPPORT(As3/As4/As5)	
		SHORTER SPAN	LONGER SPAN	SHORTER SPAN	LONGER SPAN
S1	5"	T8@6"C/C	T8@6"C/C	T8@6"C/C	T8@6"C/C

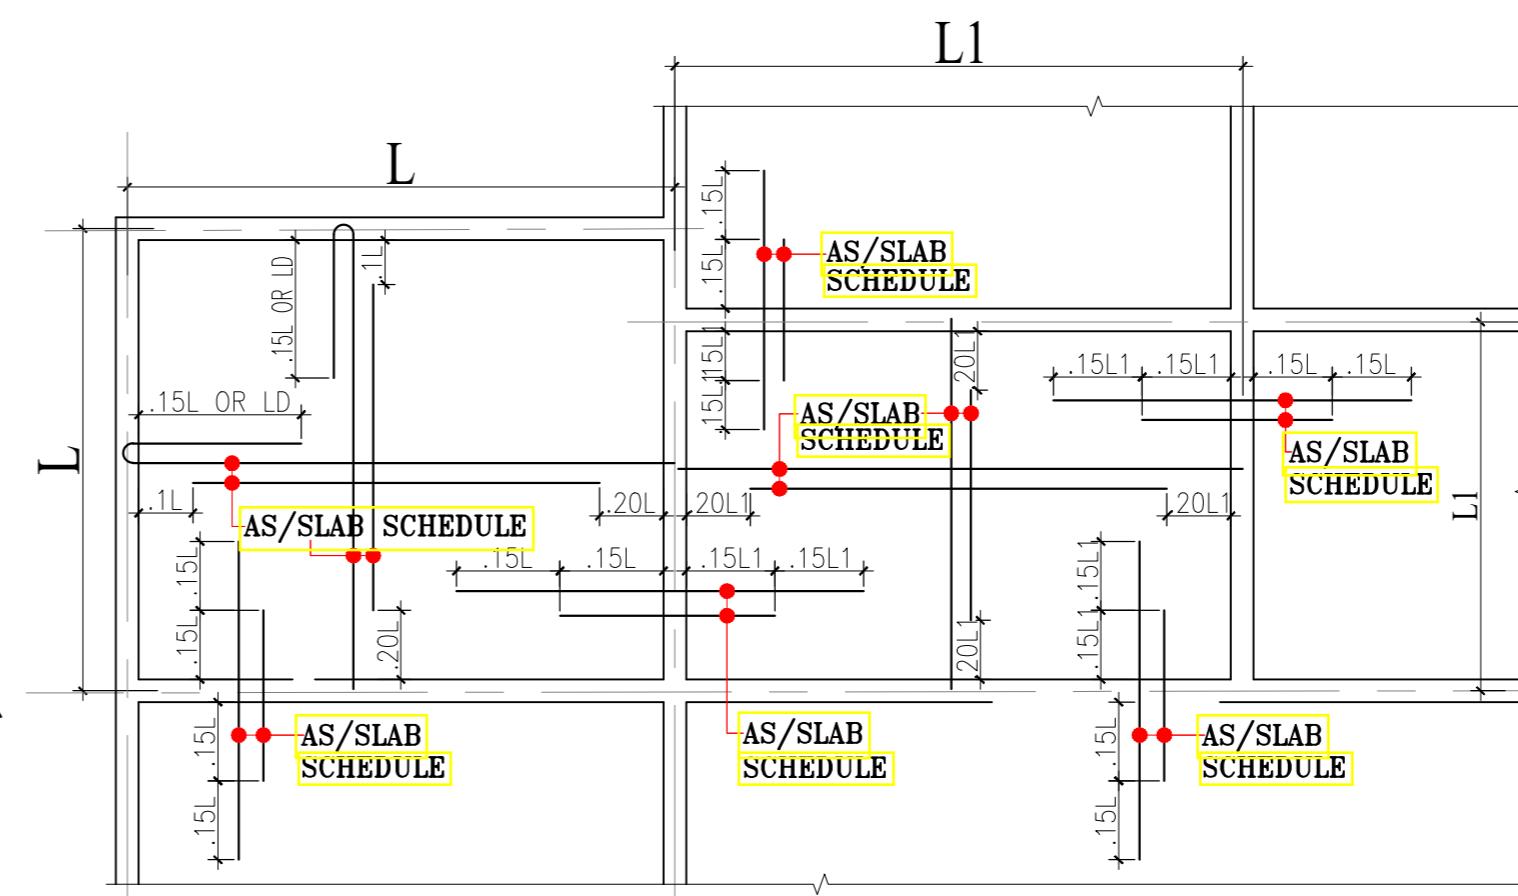

TYPICAL DETAILS OF SLAB SHOWING REINFORCEMENT

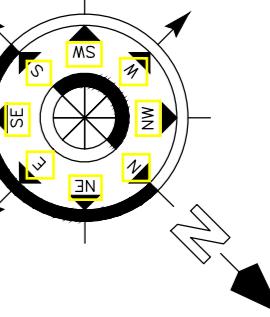

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SIGNATURE :-

DRAWN:- AR. DHANESHWARI

DESIGN:- ER. PABITRA

PROJECT TITLE:-

K.I.P SOUMYA

STATUS:

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DATE: 04-05-2022

SCALE NTS

DWG NO: 20

DRAWING TITLE:-


**FIRST ROOF BEAM
SHUTTERING PLAN
&DETAILING**



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SIGNATURE :-

DRAWN:- AR. DHANESHWARI
DESIGN:- ER. PABITRA

PROJECT TITLE:-
K.I.P SOUMYA

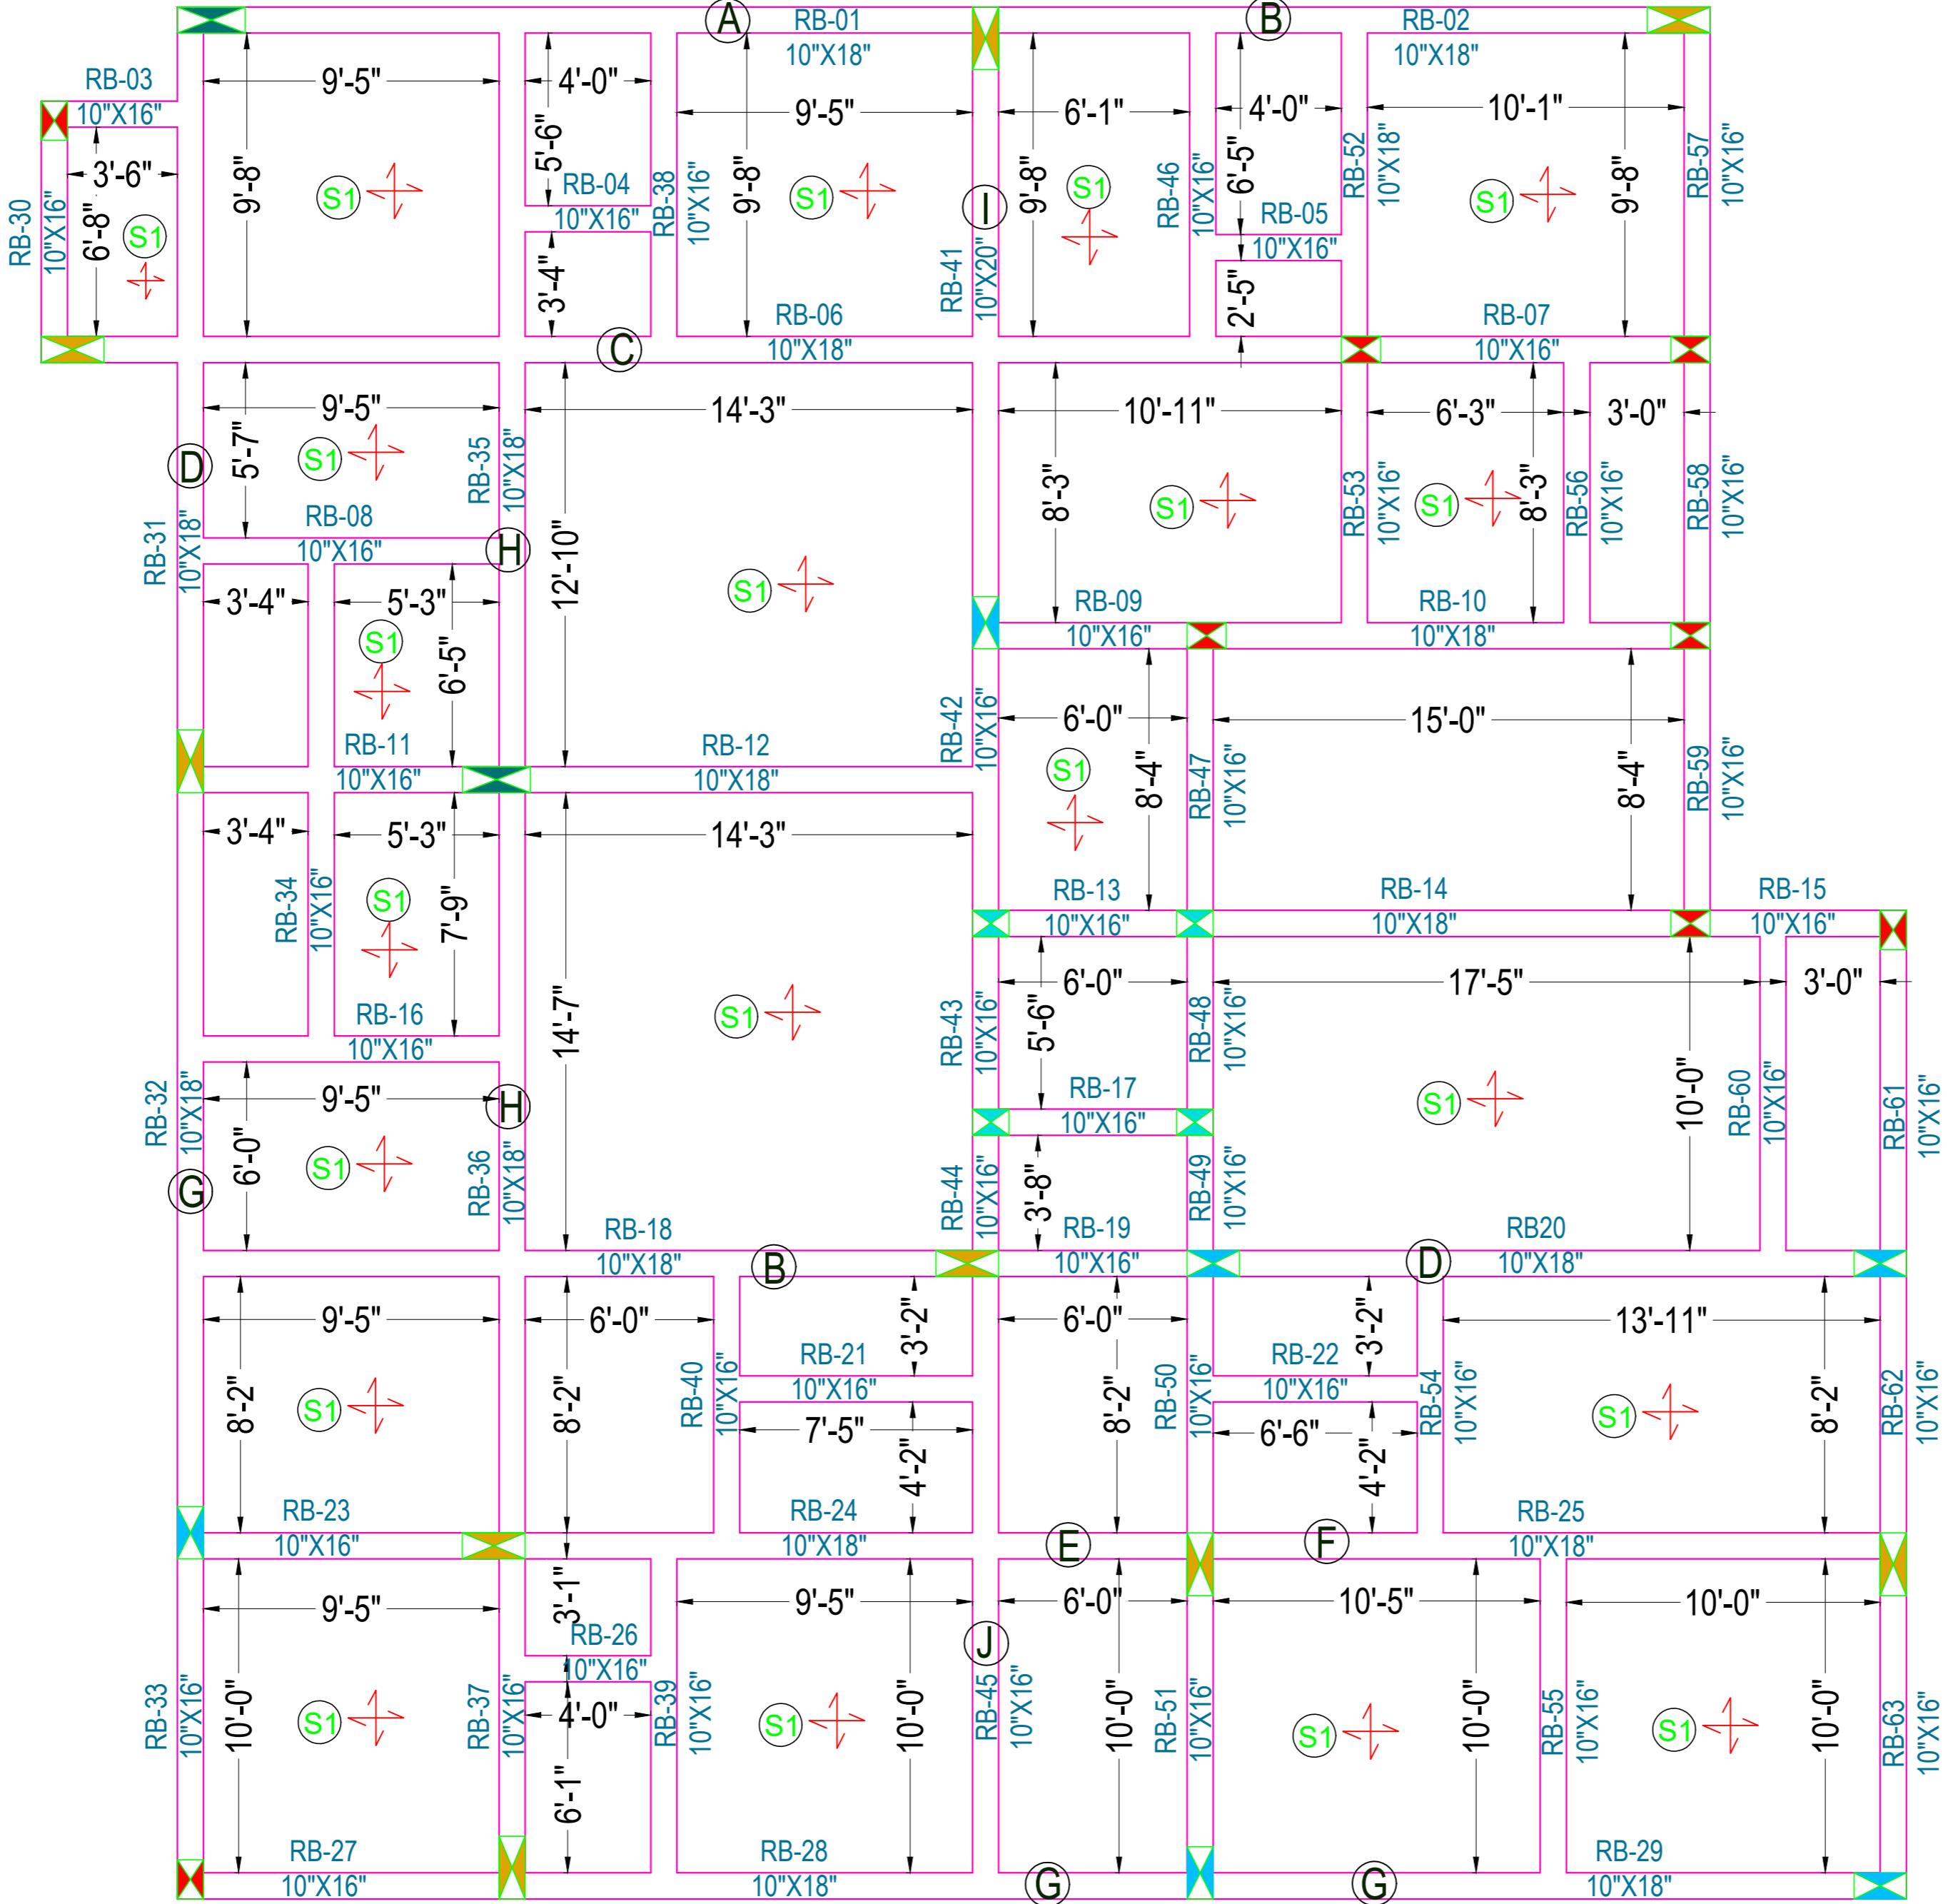
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SCALE: NTS
DWG NO: 21


DRAWING TITLE:-
**SECOND FLOOR
ROOF BEAM
SHUTTERING PLAN**


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SECOND FLOOR ROOF BEAM SHUTTERING PLAN




TYPICAL CURTAILMENT DETAIL OF REINFORCEMENT IN SLAB

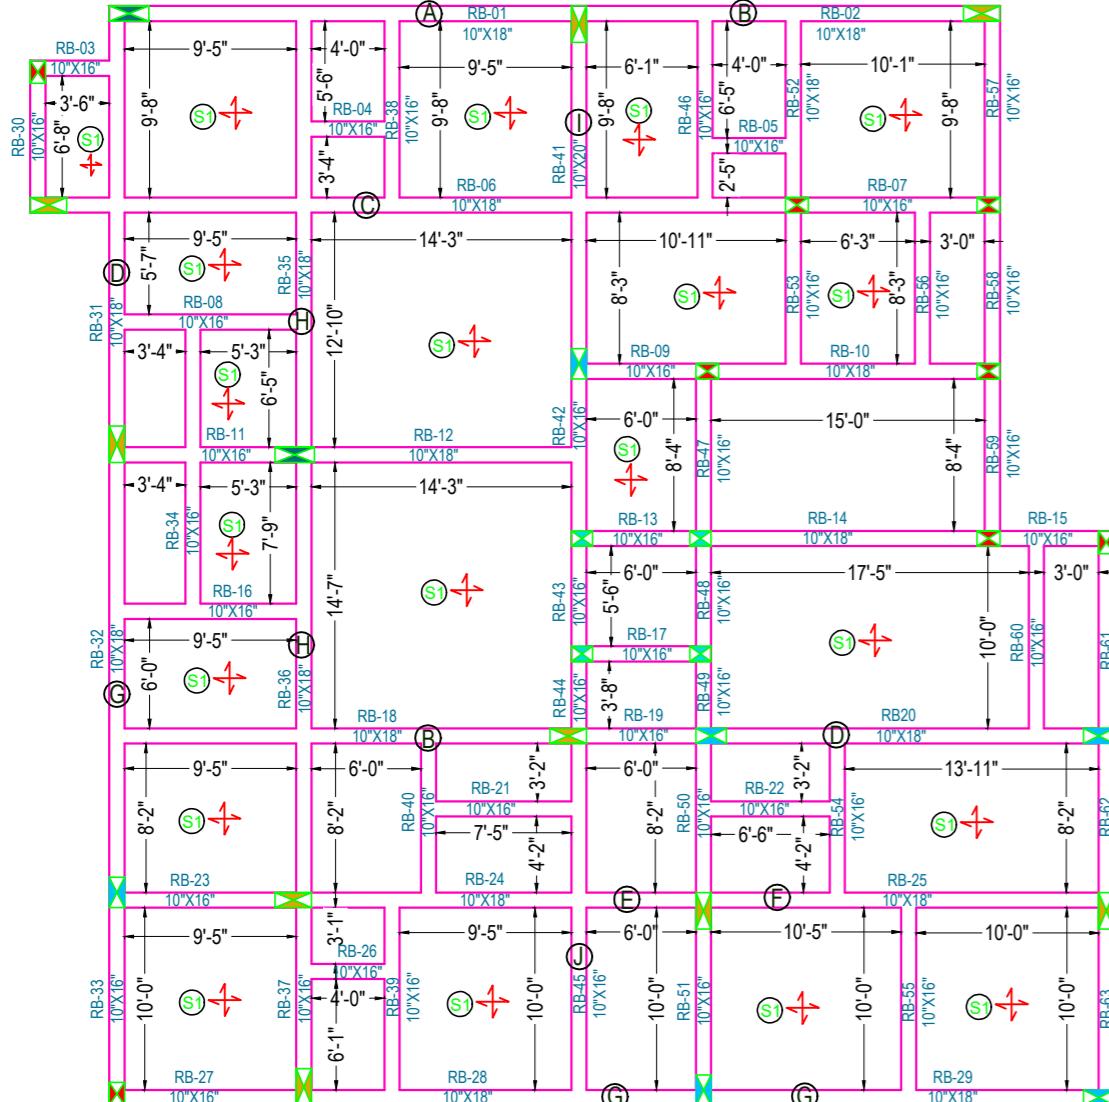
As1 & As2 - BOTTOM REINF.

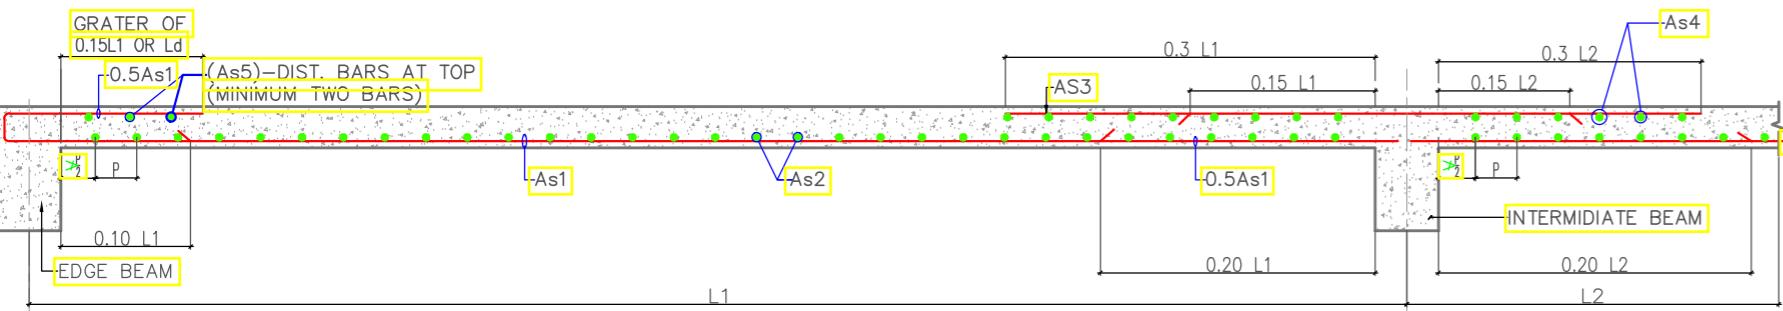As3 & As4 - TOP REINF. AT CONTINUOUS EDGE



As5 - TOP REINF. AT DISCONTINUOUS EDGE

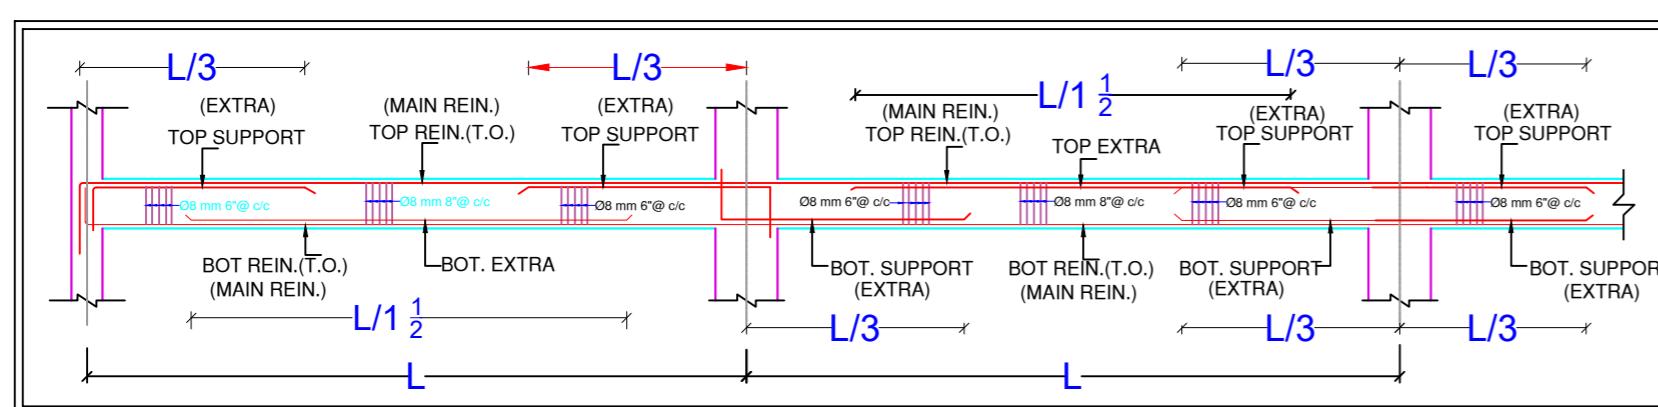

ARRANGEMENT OF REINFORCEMENT IN A BEAM

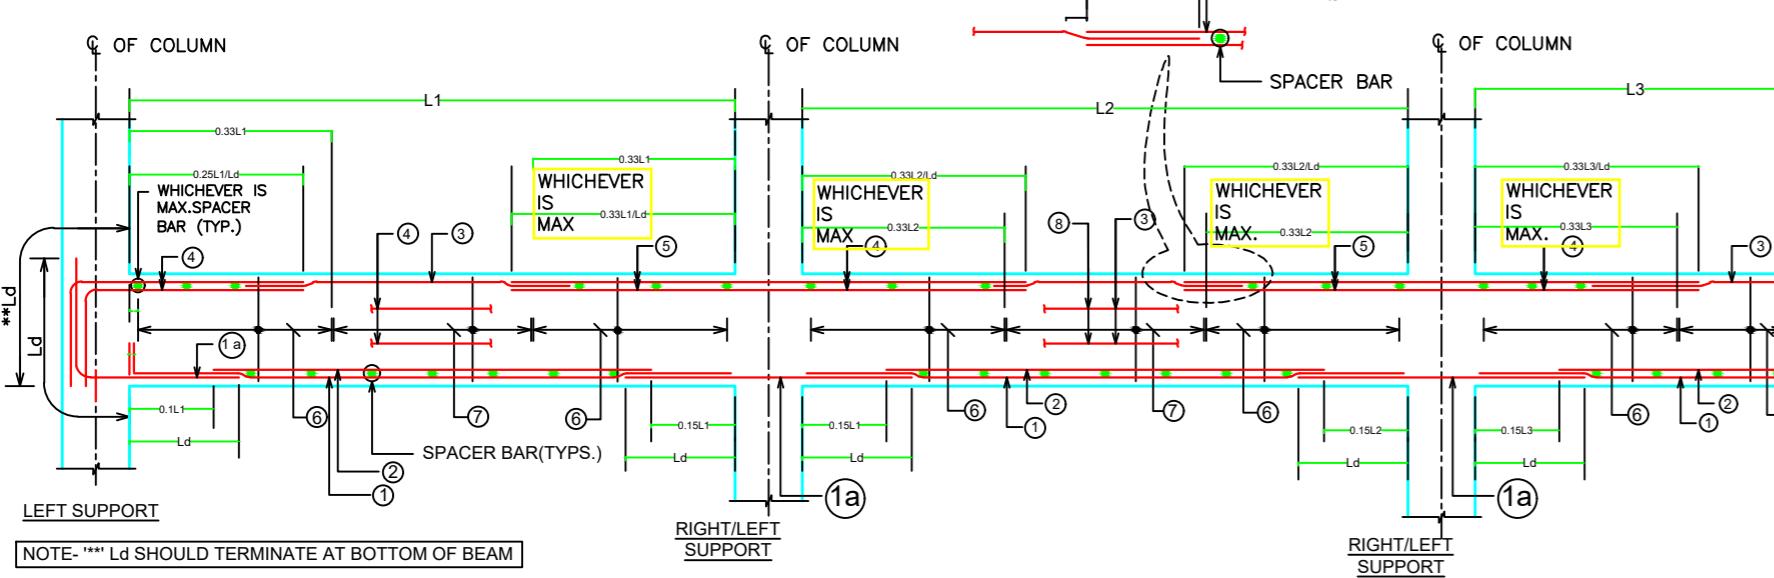


TYPICAL DETAILS OF CONTINUOUS BEAM

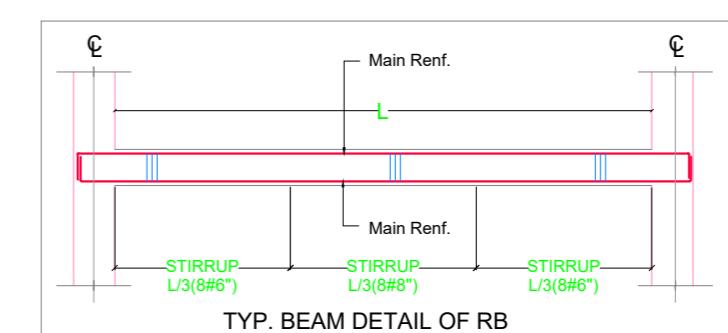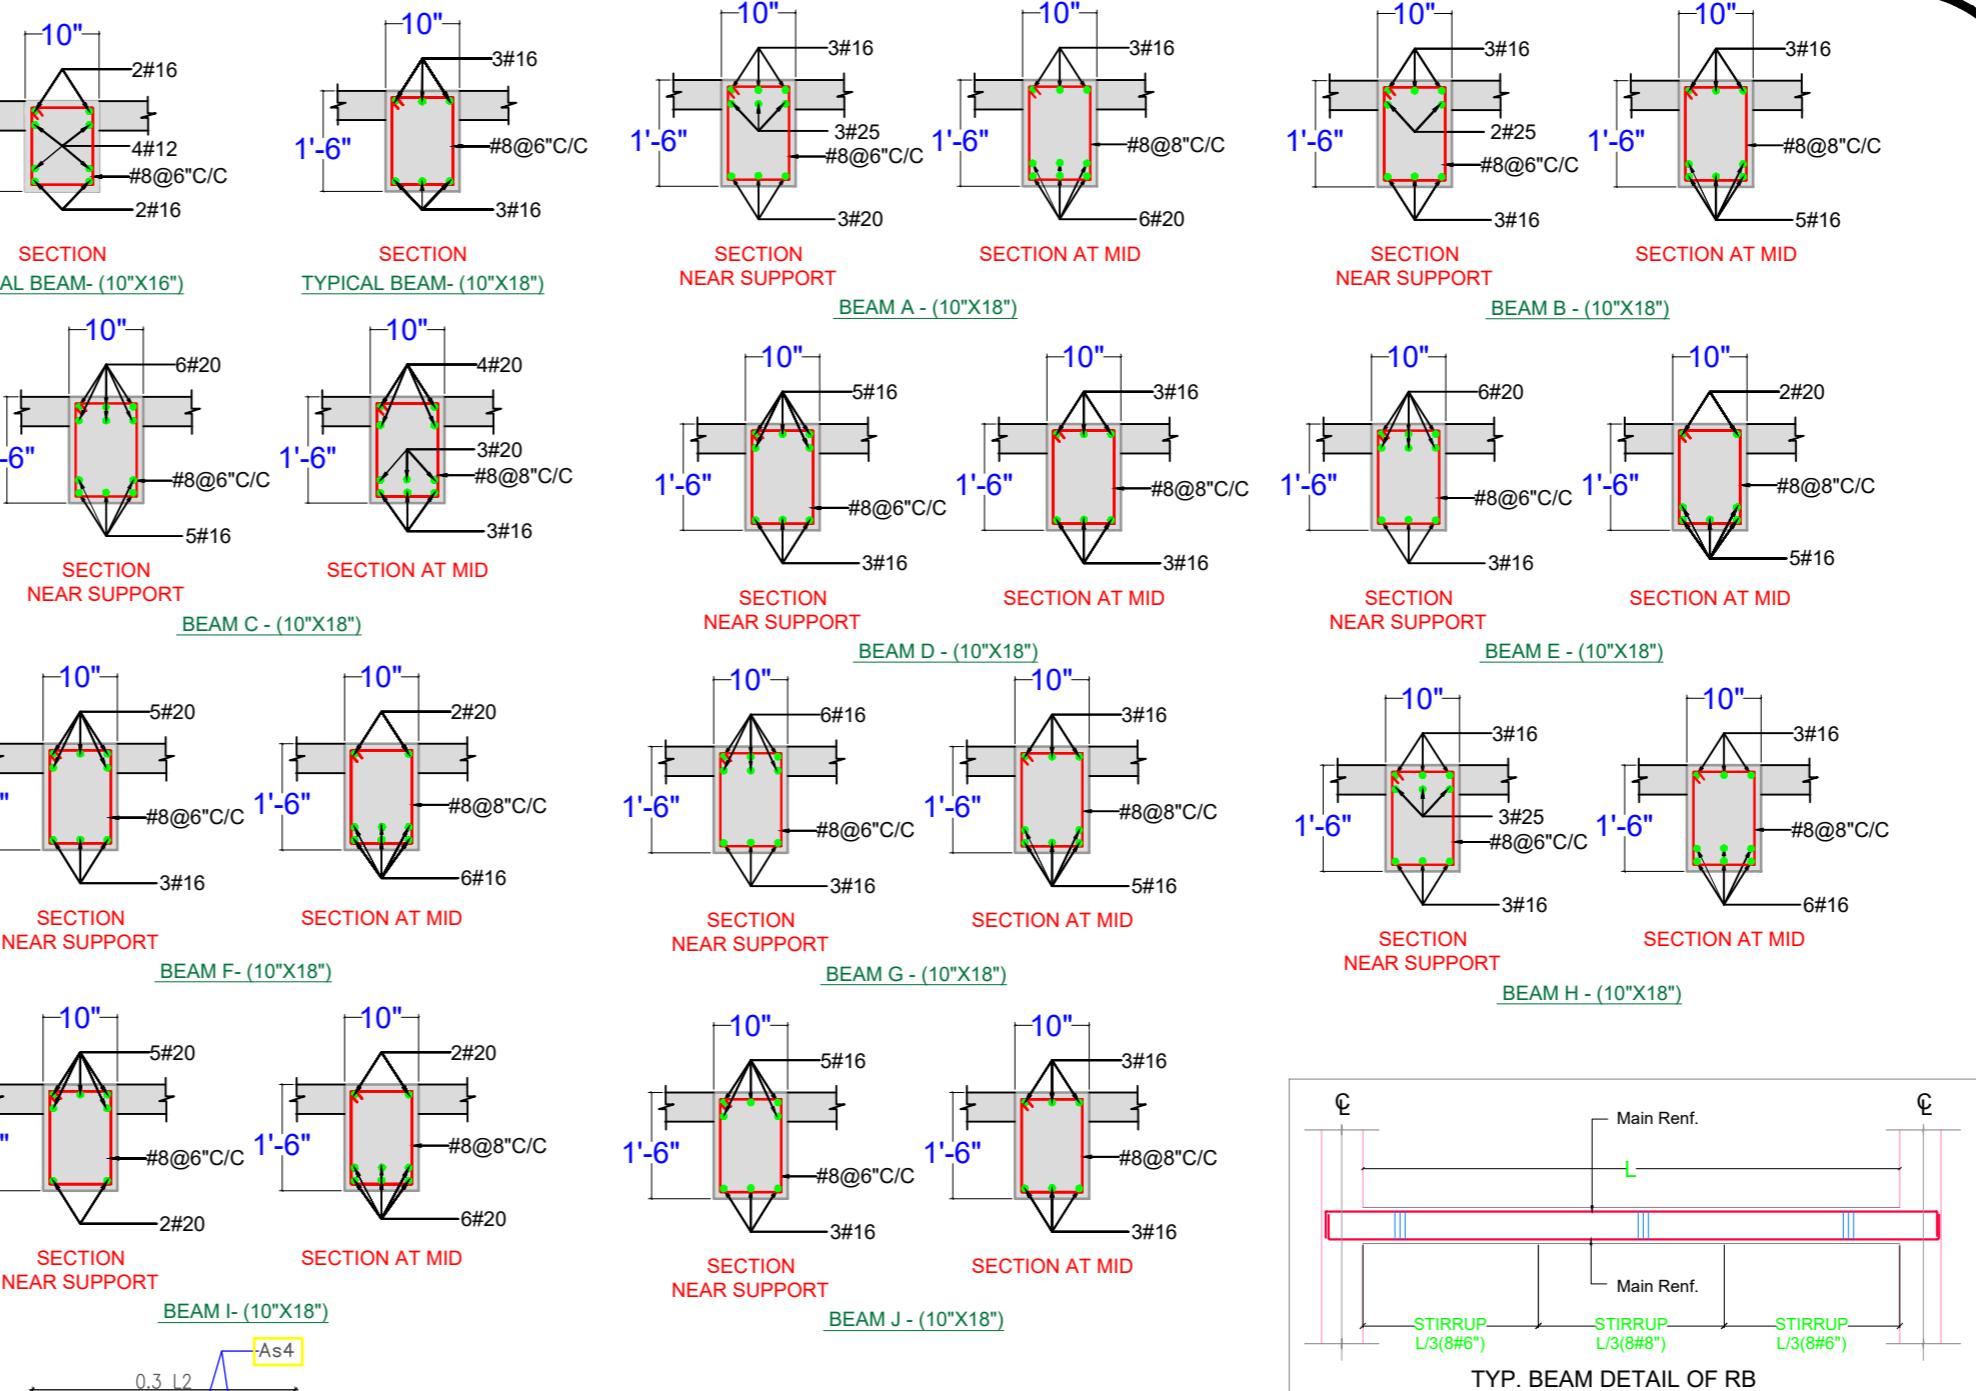


CONC. MIX. SHALL BE M-25 FOR SLAB

SLAB NO.	DEPTH	REINFORCEMENT			
		SPAN(As1/As2)		SUPPORT(As3/As4/As5)	
		SHORTER SPAN	LONGER SPAN	SHORTER SPAN	LONGER SPAN
S1	5"	T8@6"C/C	T8@6"C/C	T8@6"C/C	T8@6"C/C

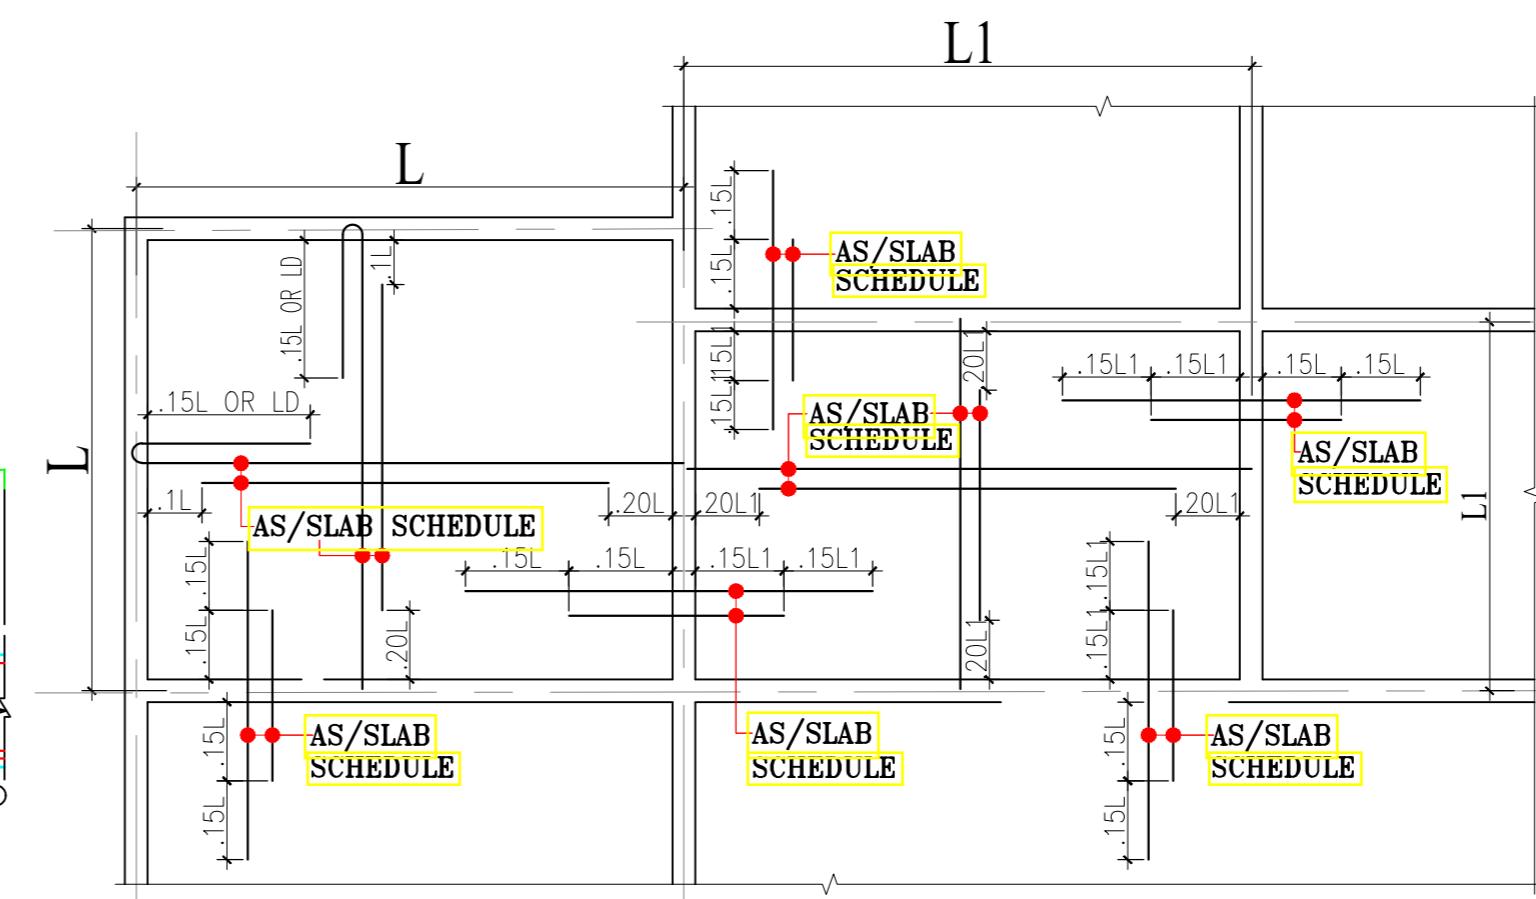

TYPICAL DETAILS OF SLAB SHOWING REINFORCEMENT

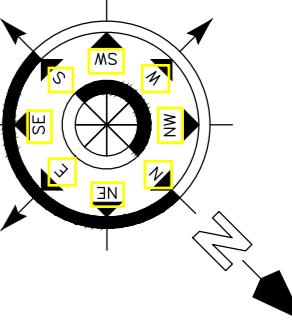

Note:

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- THIS DRAWING SHOULD BE READ IN CONVENTION WITH RELEVANT ARCHITECTURAL DRAWINGS AND SITE CONDITIONS.
- ANY DISCREPANCY IN THE DRAWING SHOULD BE BROUGHT TO THE KNOWLEDGE OF CONSULTANT BEFORE EXECUTION.
- ALL SPACES TAKEN FOR (G+2) FLOORS ONLY.
- CLEAR COVER TO MAIN REINFORCEMENT SHALL BE FOR COLUMN - 40MM, PLINTH BEAM - 30MM
- FOOTING-50mm, BEAM-25mm, SLAB - 20mm .
- THE MIX FOR ALL R.C.C. WORK SHALL BE M-20 (1:1.5:3).
- ALL THE REINFORCEMENT SHALL BE F-500(HYD BARS).
- MINIMUM DEVELOPMENT LENGTH FOR TOR STEEL SHALL BE 50d, WHERE "d" IS DIA OF MAIN REINFORCEMENT.
- THE LAP SHALL BE STAGGERED AND AVOIDED AT THE POINT OF MAXIMUM BENDING MOMENT.
- ALL DIMENSION & LEVEL ARE IN FEET-INCH.

SIGNATURE :-

DRAWN:- AR. DHANESHWARI

DESIGN:- ER. PABITRA

PROJECT TITLE:-

K.I.P SOUMYA

STATUS:

ISSUED FOR CONSTRUCTION

DATE: 04-05-2022

SCALE NTS

DWG NO: 22

DRAWING TITLE:-


SECOND FLOOR
BEAM SHUTTERING
PLAN & DETAILING



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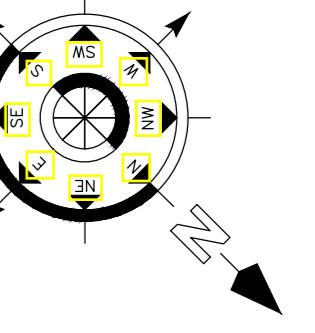
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THIRD FLOOR ROOF BEAM SHUTTERING PLAN

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 - ANY DISCREPANCY IN THE DRAWING SHOULD BE BROUGHT TO THE KNOWLEDGE OF CONSULTANT BEFORE EXECUTION.
 - LOAD HAS BEEN TAKEN FOR (G+2) FLOORS ONLY.
 - CLEAR COVER TO MAIN REINFORCEMENT SHALL BE FOR COLUMN - 40MM, PLINTH BEAM - 50MM
 - FOOTING-50mm, BEAM-25mm, SLAB - 20mm .
 - THE MIX FOR ALL R.C.C. WORK SHALL BE M-20 (1:1.5:3).
 - ALL THE REINFORCEMENT SHALL BE Fe-500(HYSB BARS).
 - MINIMUM DEVELOPMENT LENGTH FOR TOR STEEL SHALL BE 50d, WHERE "d" IS DIA OF MAIN REINFORCEMENT.
 - THE LAP SHALL BE STAGGERED AND AVOIDED AT THE POINT OF MAXIMUM BENDING MOMENT .
 - ALL DIMENSION & LEVEL ARE IN FEET-INCH.

SIGNATURE :-

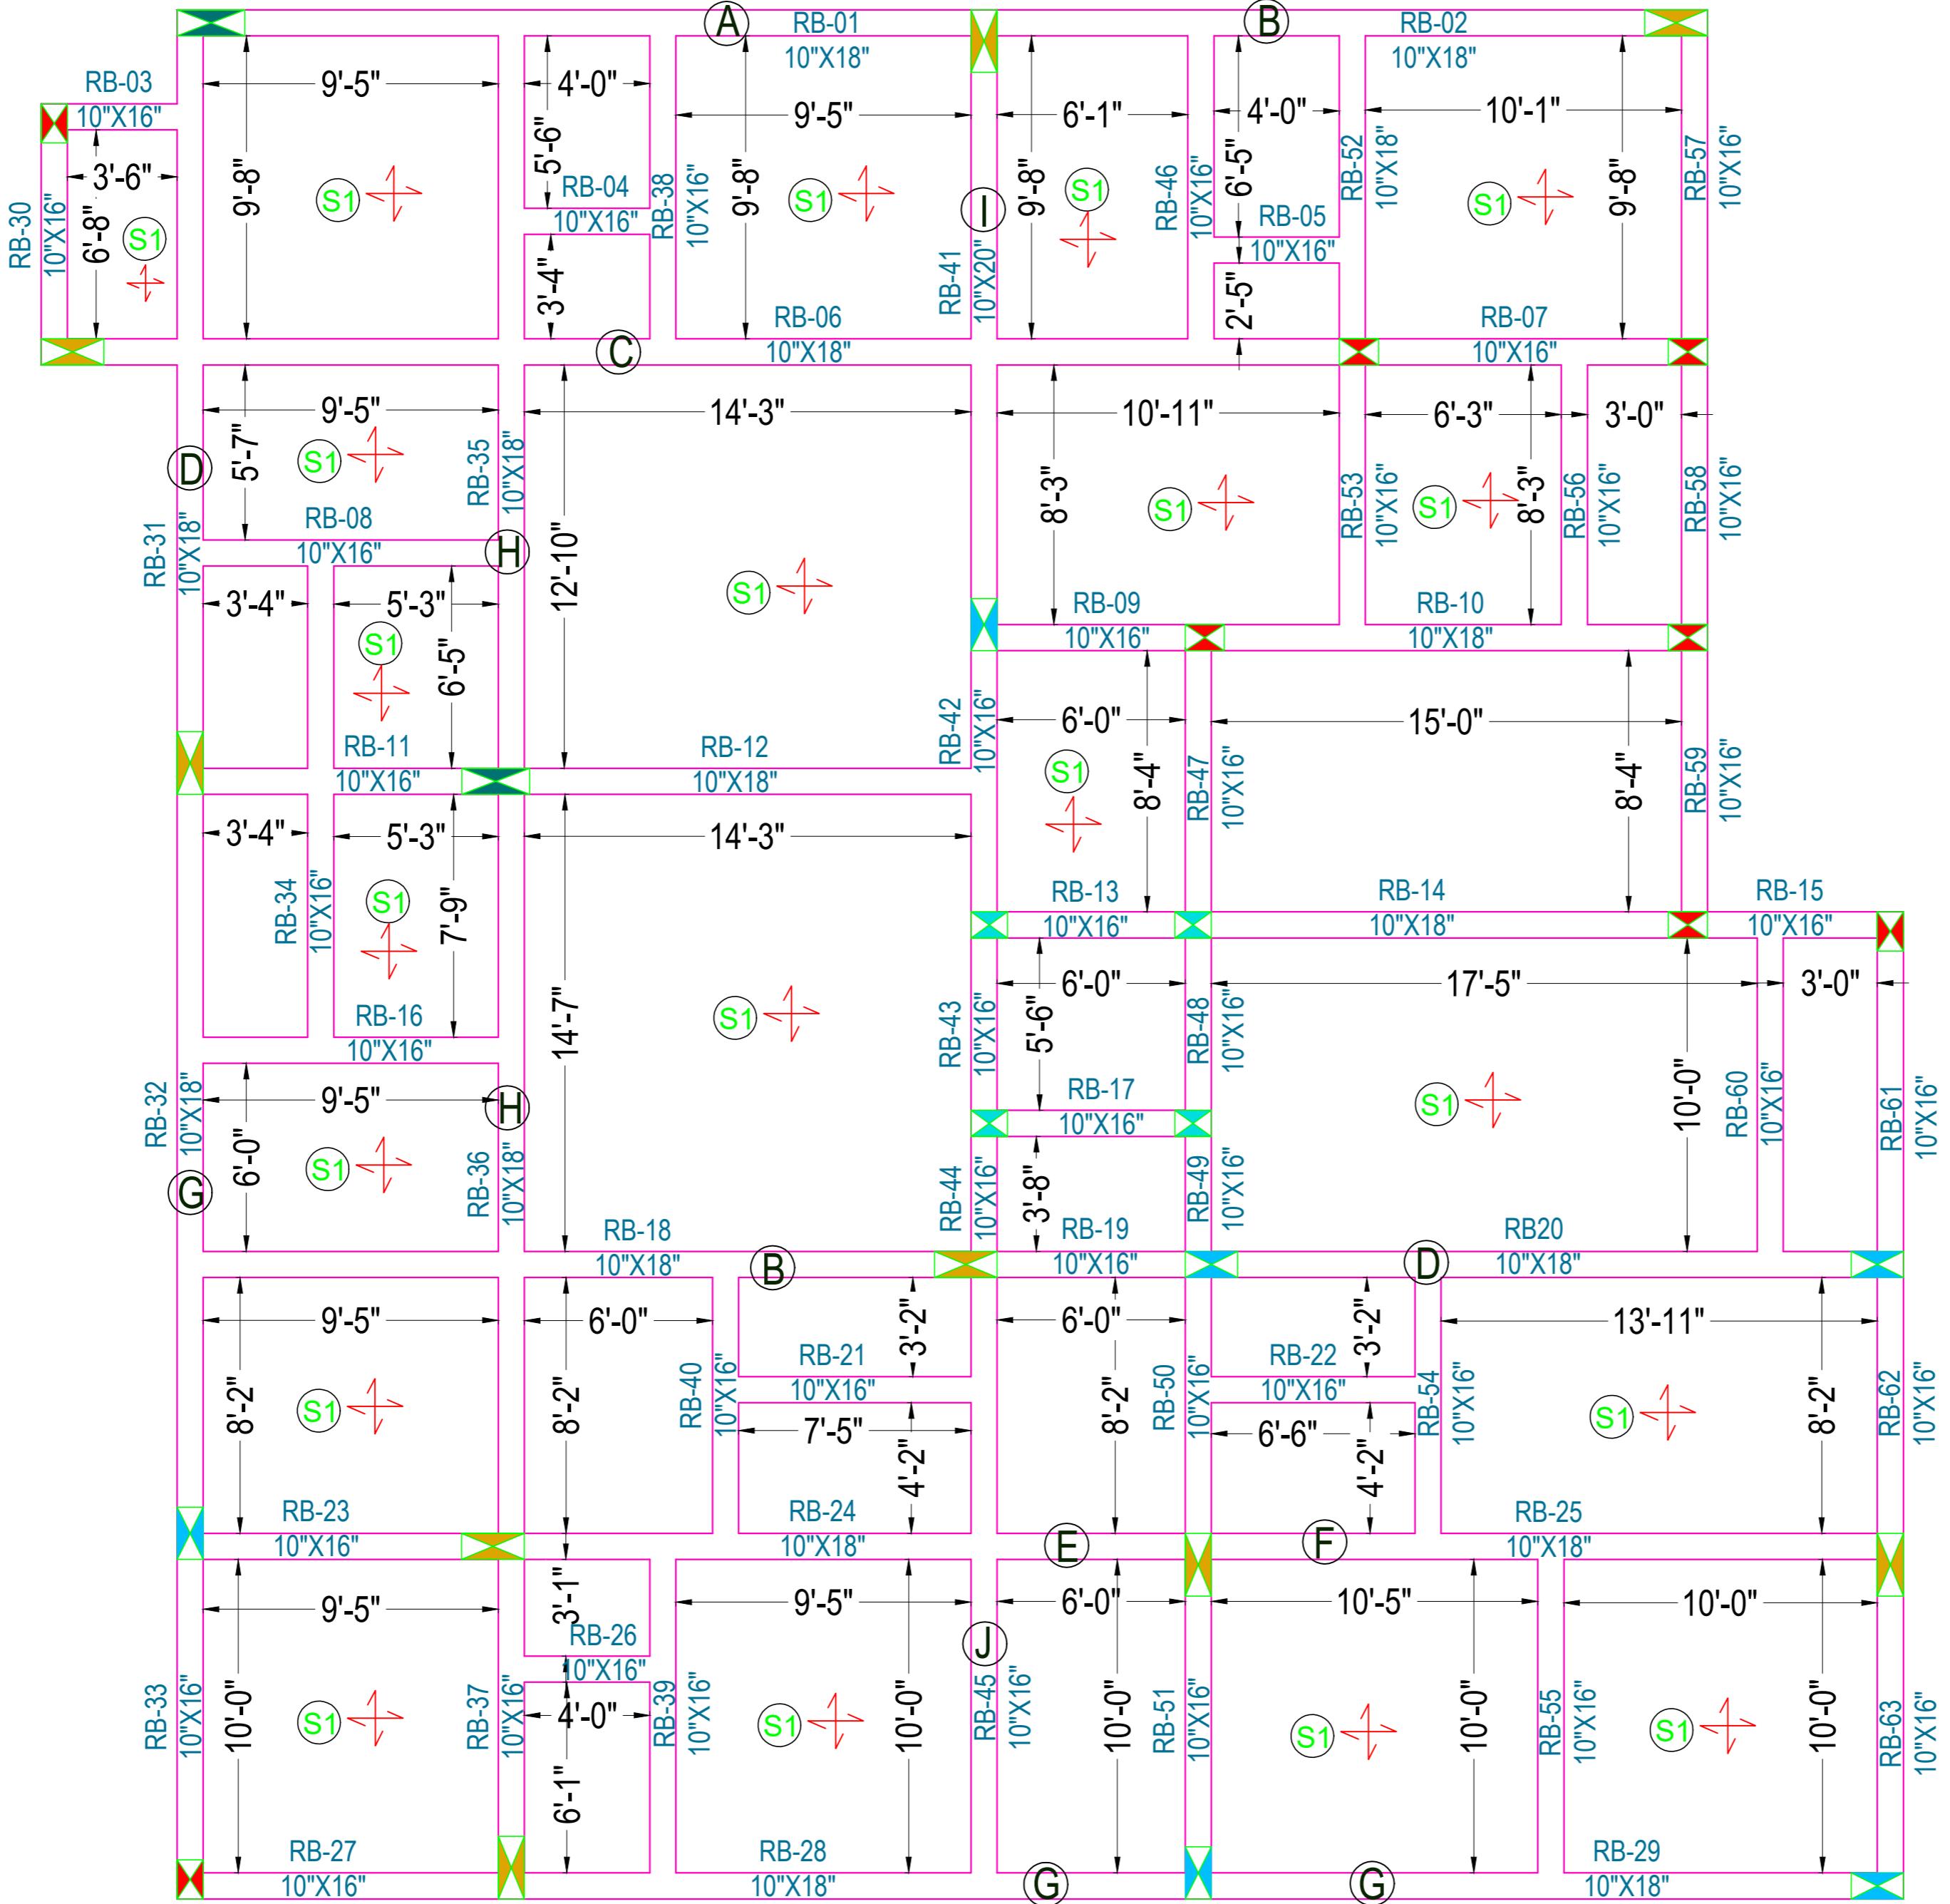DRAWN:-	AR. DHANESHWARI
DESIGN:-	ER. PABITRA

PROJECT TITLE:-

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STATUS:

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DATE:	04-05-2022
SCALE	NTS
DWG NO:	23


DRAWING TITLE:-

THIRD FLOOR ROOF BEAM SHUTTERING PLAN




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THIRD FLOOR ROOF BEAM SHUTTERING PLAN

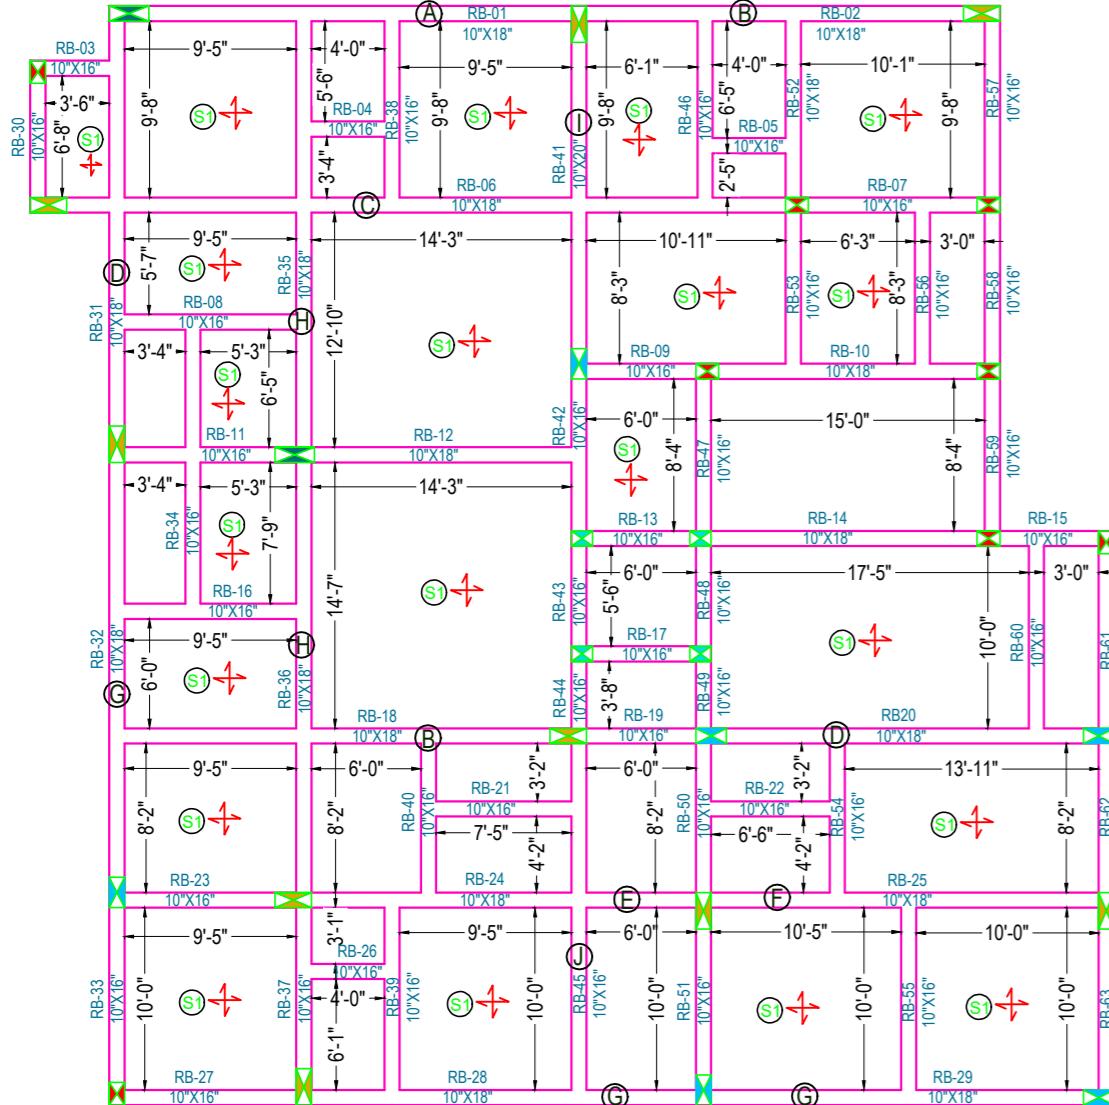


TYPICAL CURTAILMENT DETAIL OF REINFORCEMENT IN SLAB


As1 & As2 - BOTTOM REINF.

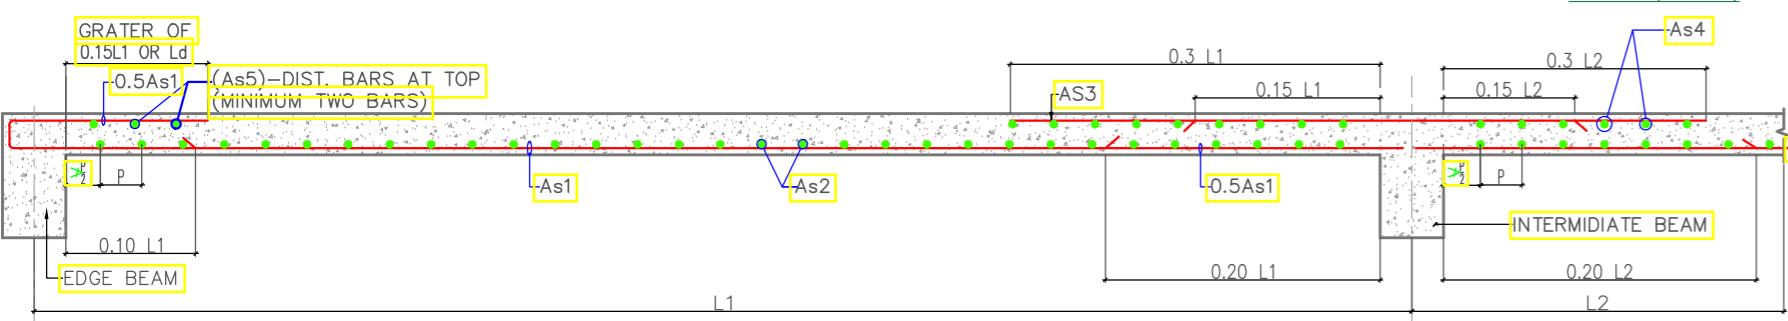As3 & As4 - TOP REINF. AT CONTINUOUS EDGE


As5 - TOP REINF. AT DISCONTINUOUS EDGE

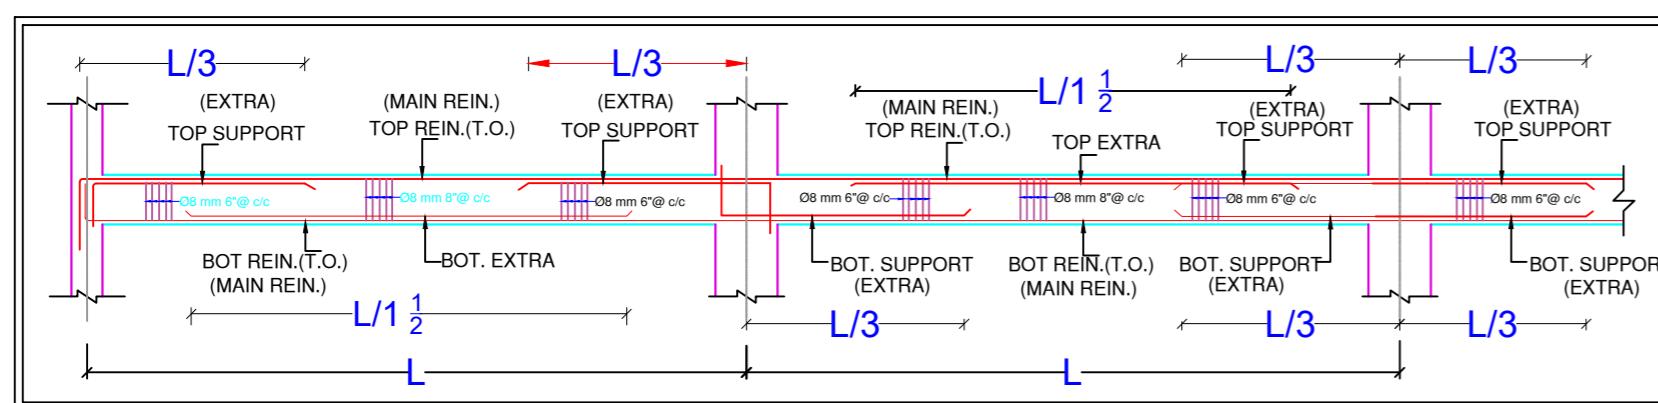

ARRANGEMENT OF REINFORCEMENT IN A BEAM

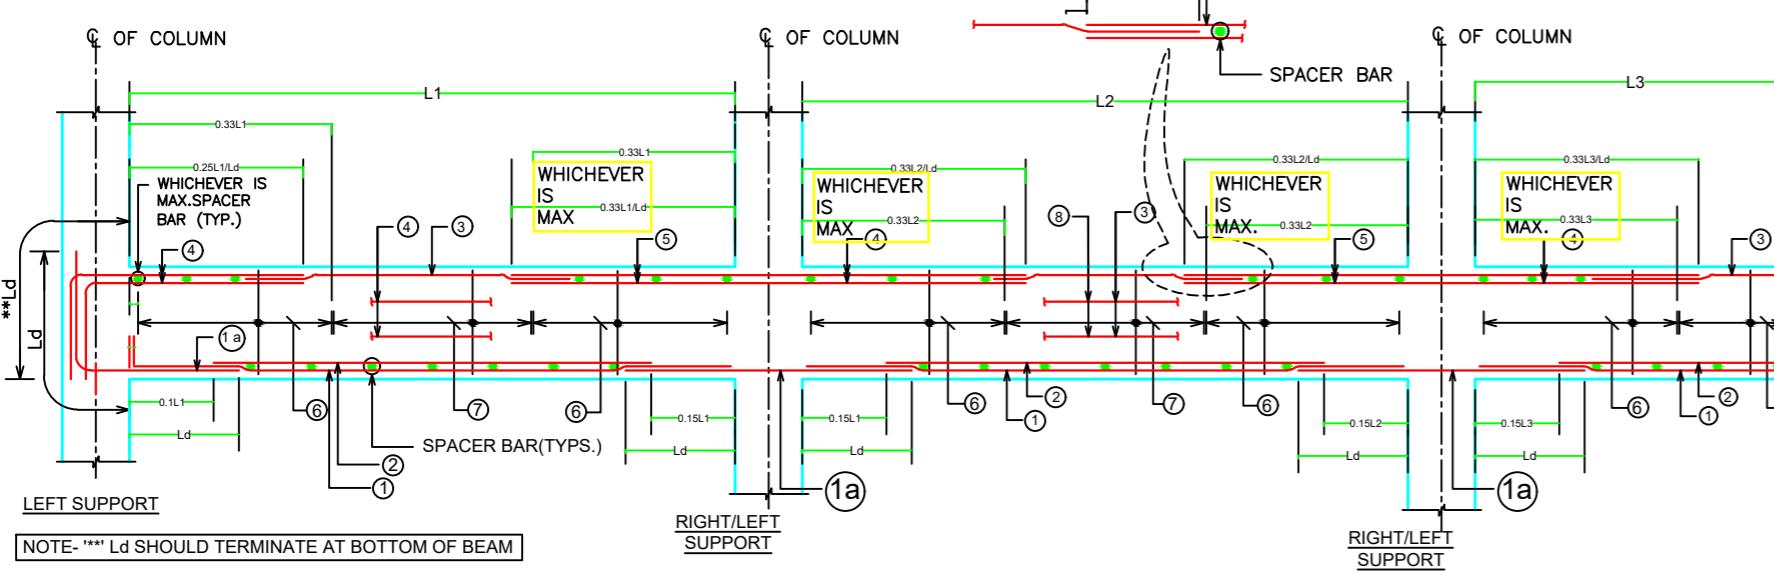


TYPICAL DETAILS OF CONTINUOUS BEAM

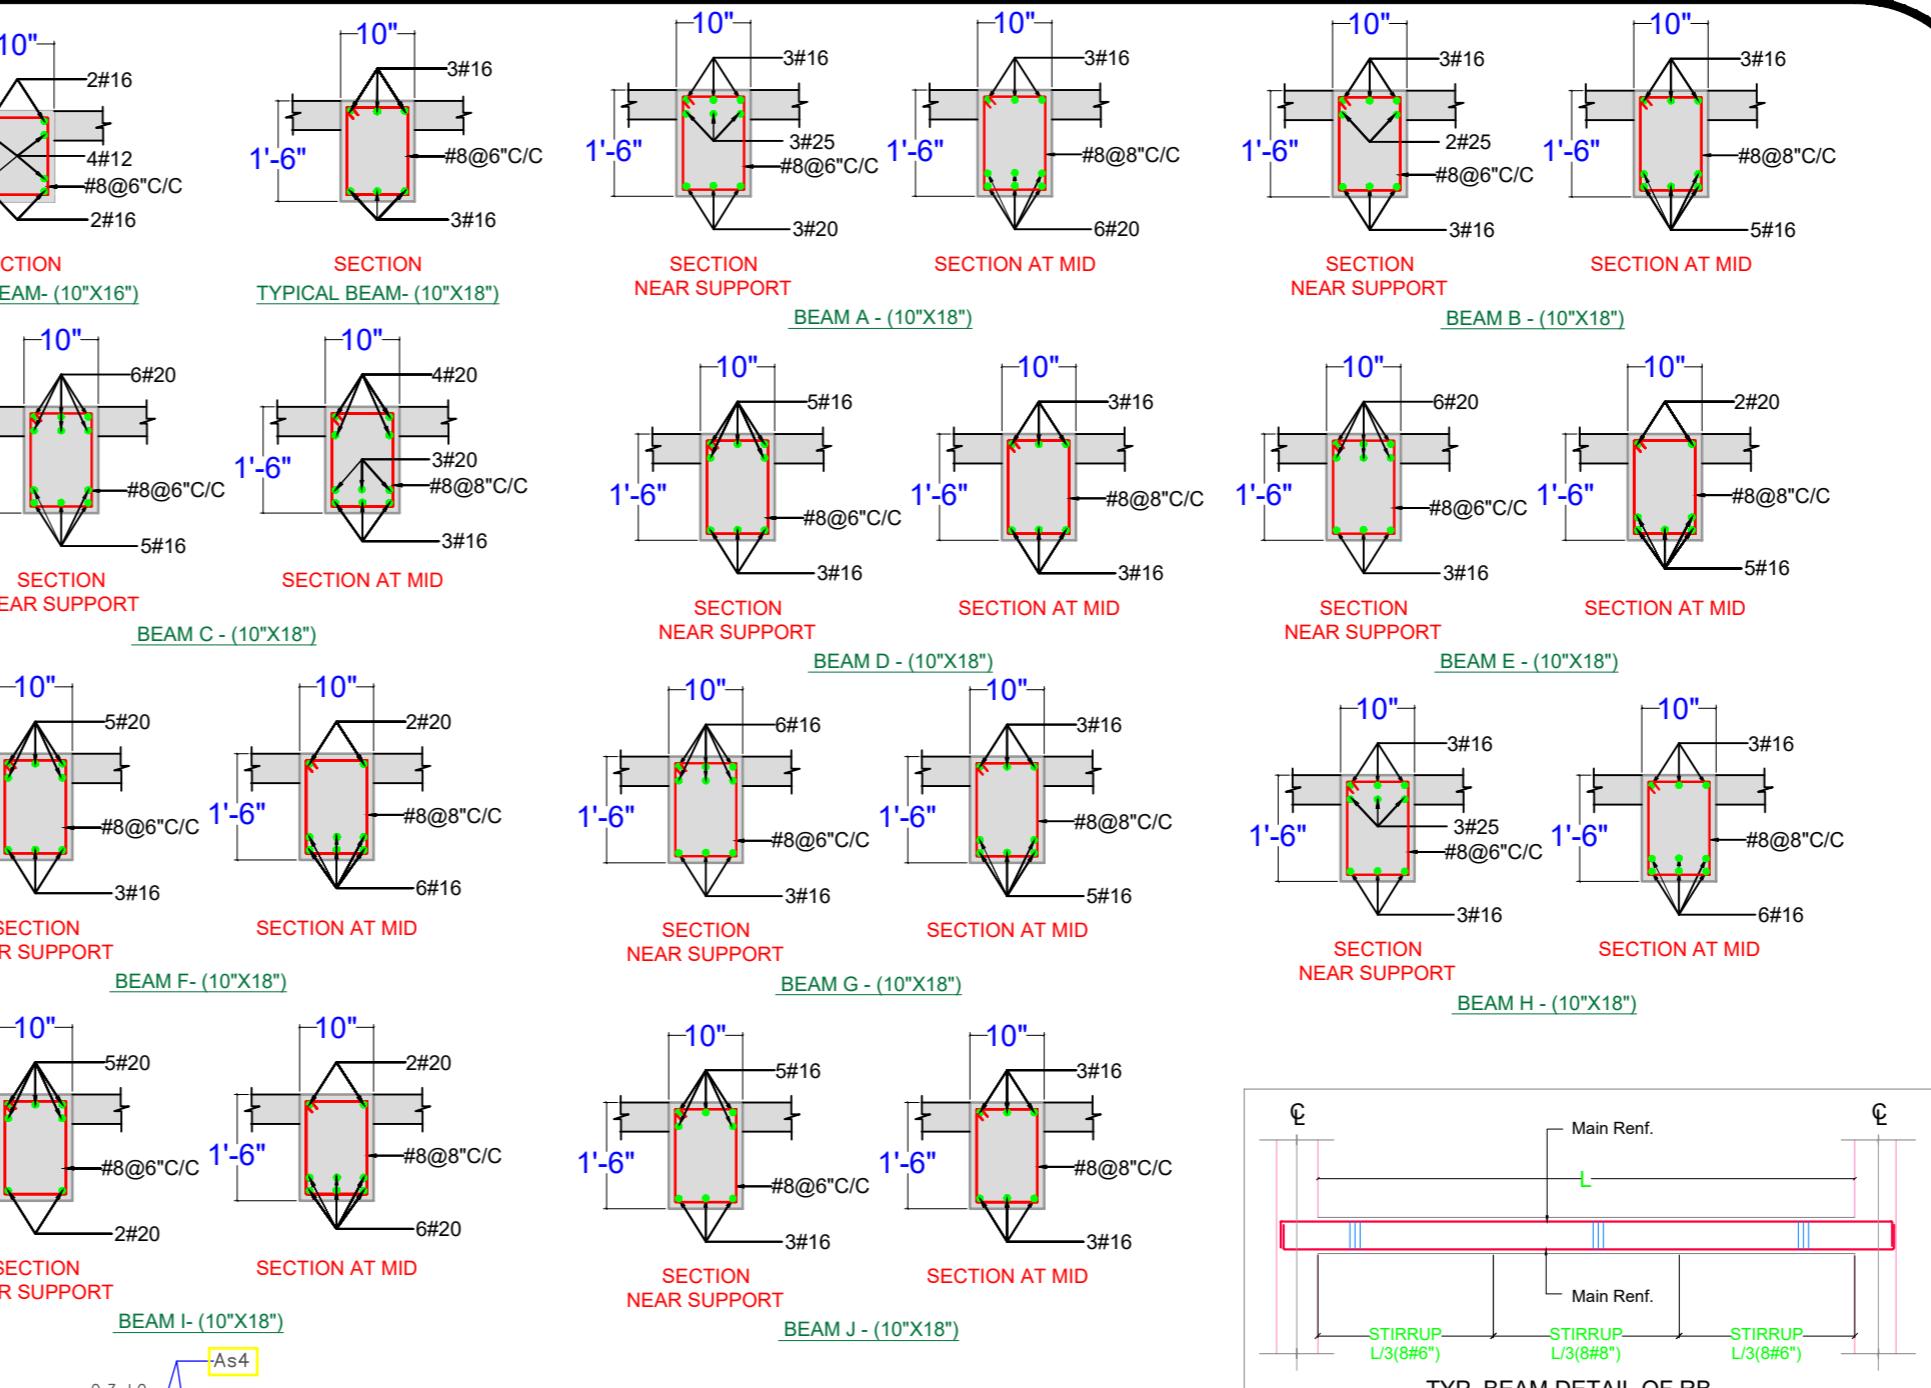


CONC. MIX. SHALL BE M-25 FOR SLAB

SLAB NO.	DEPTH	REINFORCEMENT			
		SPAN(As1/As2)		SUPPORT(As3/As4/As5)	
		SHORTER SPAN	LONGER SPAN	SHORTER SPAN	LONGER SPAN
S1	5"	T8@6"C/C	T8@6"C/C	T8@6"C/C	T8@6"C/C

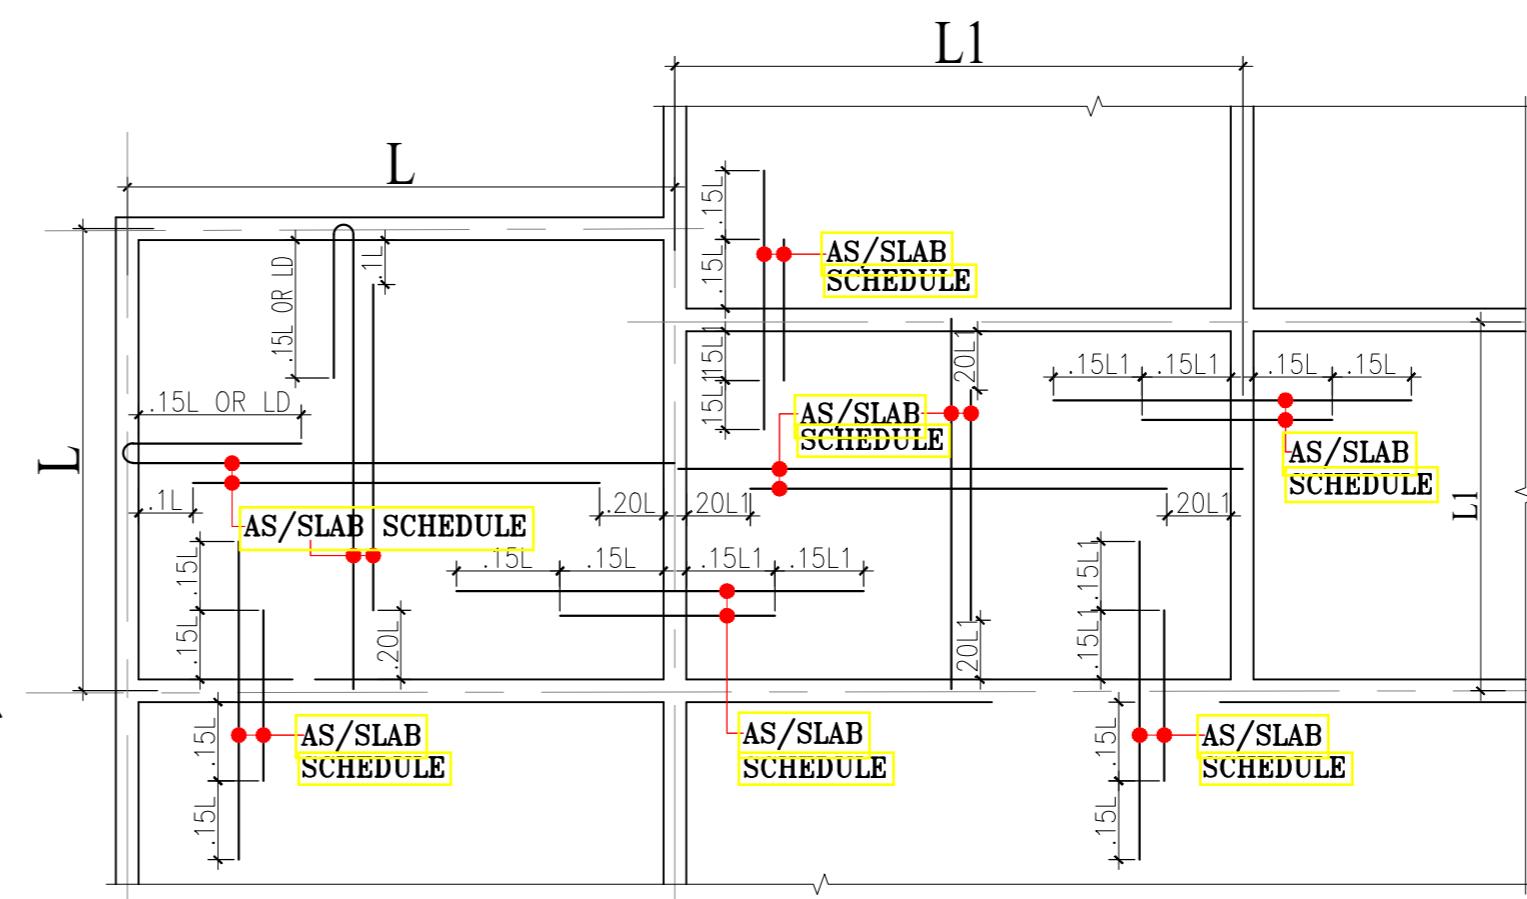

TYPICAL DETAILS OF SLAB SHOWING REINFORCEMENT

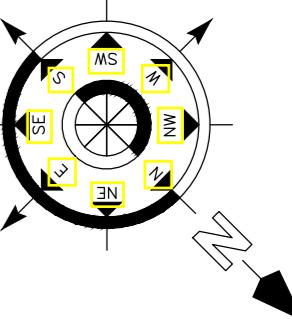

Note:

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- THIS DRAWING SHOULD BE READ IN CONVENTION WITH RELEVANT ARCHITECTURAL DRAWINGS AND SITE CONDITIONS.
- ANY DISCREPANCY IN THE DRAWING SHOULD BE BROUGHT TO THE KNOWLEDGE OF CONSULTANT BEFORE EXECUTION.
- ALL REINFORCING BARS ARE TAKEN FOR G+2 FLOORS ONLY.
- CLEAR COVER TO MAIN REINFORCEMENT SHALL BE FOR COLUMN - 40MM, PLINTH BEAM - 30MM
- FOOTING-50mm, BEAM-25mm, SLAB - 20mm .
- THE MIX FOR ALL R.C.C. WORK SHALL BE M-20 (1:1.5:3).
- ALL THE REINFORCEMENT SHALL BE F-500(HYD BARS).
- MINIMUM DEVELOPMENT LENGTH FOR TOR STEEL SHALL BE 50d, WHERE "d" IS DIA OF MAIN REINFORCEMENT.
- THE LAP SHALL BE STAGGERED AND AVOIDED AT THE POINT OF MAXIMUM BENDING MOMENT.
- ALL DIMENSION & LEVEL ARE IN FEET-INCH.

SIGNATURE :-

DRAWN:- AR. DHANESHWARI

DESIGN:- ER. PABITRA

PROJECT TITLE:-

K.I.P SOUMYA

STATUS:

ISSUED FOR CONSTRUCTION

DATE: 04-05-2022

SCALE: NTS

DWG NO: 24

DRAWING TITLE:-


THIRD FLOOR ROOF
BEAM SHUTTERING
PLAN & DETAILING



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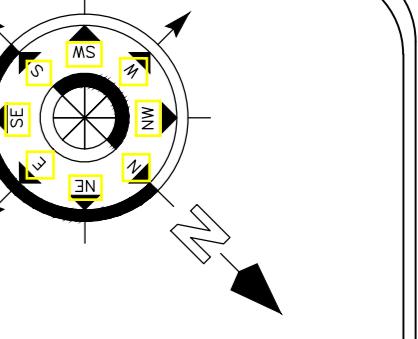
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FOURTH FLOOR ROOF BEAM SHUTTERING PLAN

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- CLEAR COVER TO MAIN REINFORCEMENT SHALL BE FOR COLUMN - 40MM, PLINTH BEAM - 30MM.
- FOOTING-50mm, BEAM-25mm, SLAB - 20mm .
- THE MIX FOR ALL R.C.C. WORK SHALL BE M-20 (1:1.5:3).
- ALL THE REINFORCEMENT SHALL BE Fe-500(HSD BARS).
- MINIMUM DEVELOPMENT LENGTH FOR TOR STEEL SHALL BE 50d, WHERE "d" IS DIA OF MAIN REINFORCEMENT.
- THE LAP SHALL BE STAGGERED AND AVOIDED AT THE POINT OF MAXIMUM BENDING MOMENT .
- ALL DIMENSION & LEVEL ARE IN FEET-INCH.

SIGNATURE :-

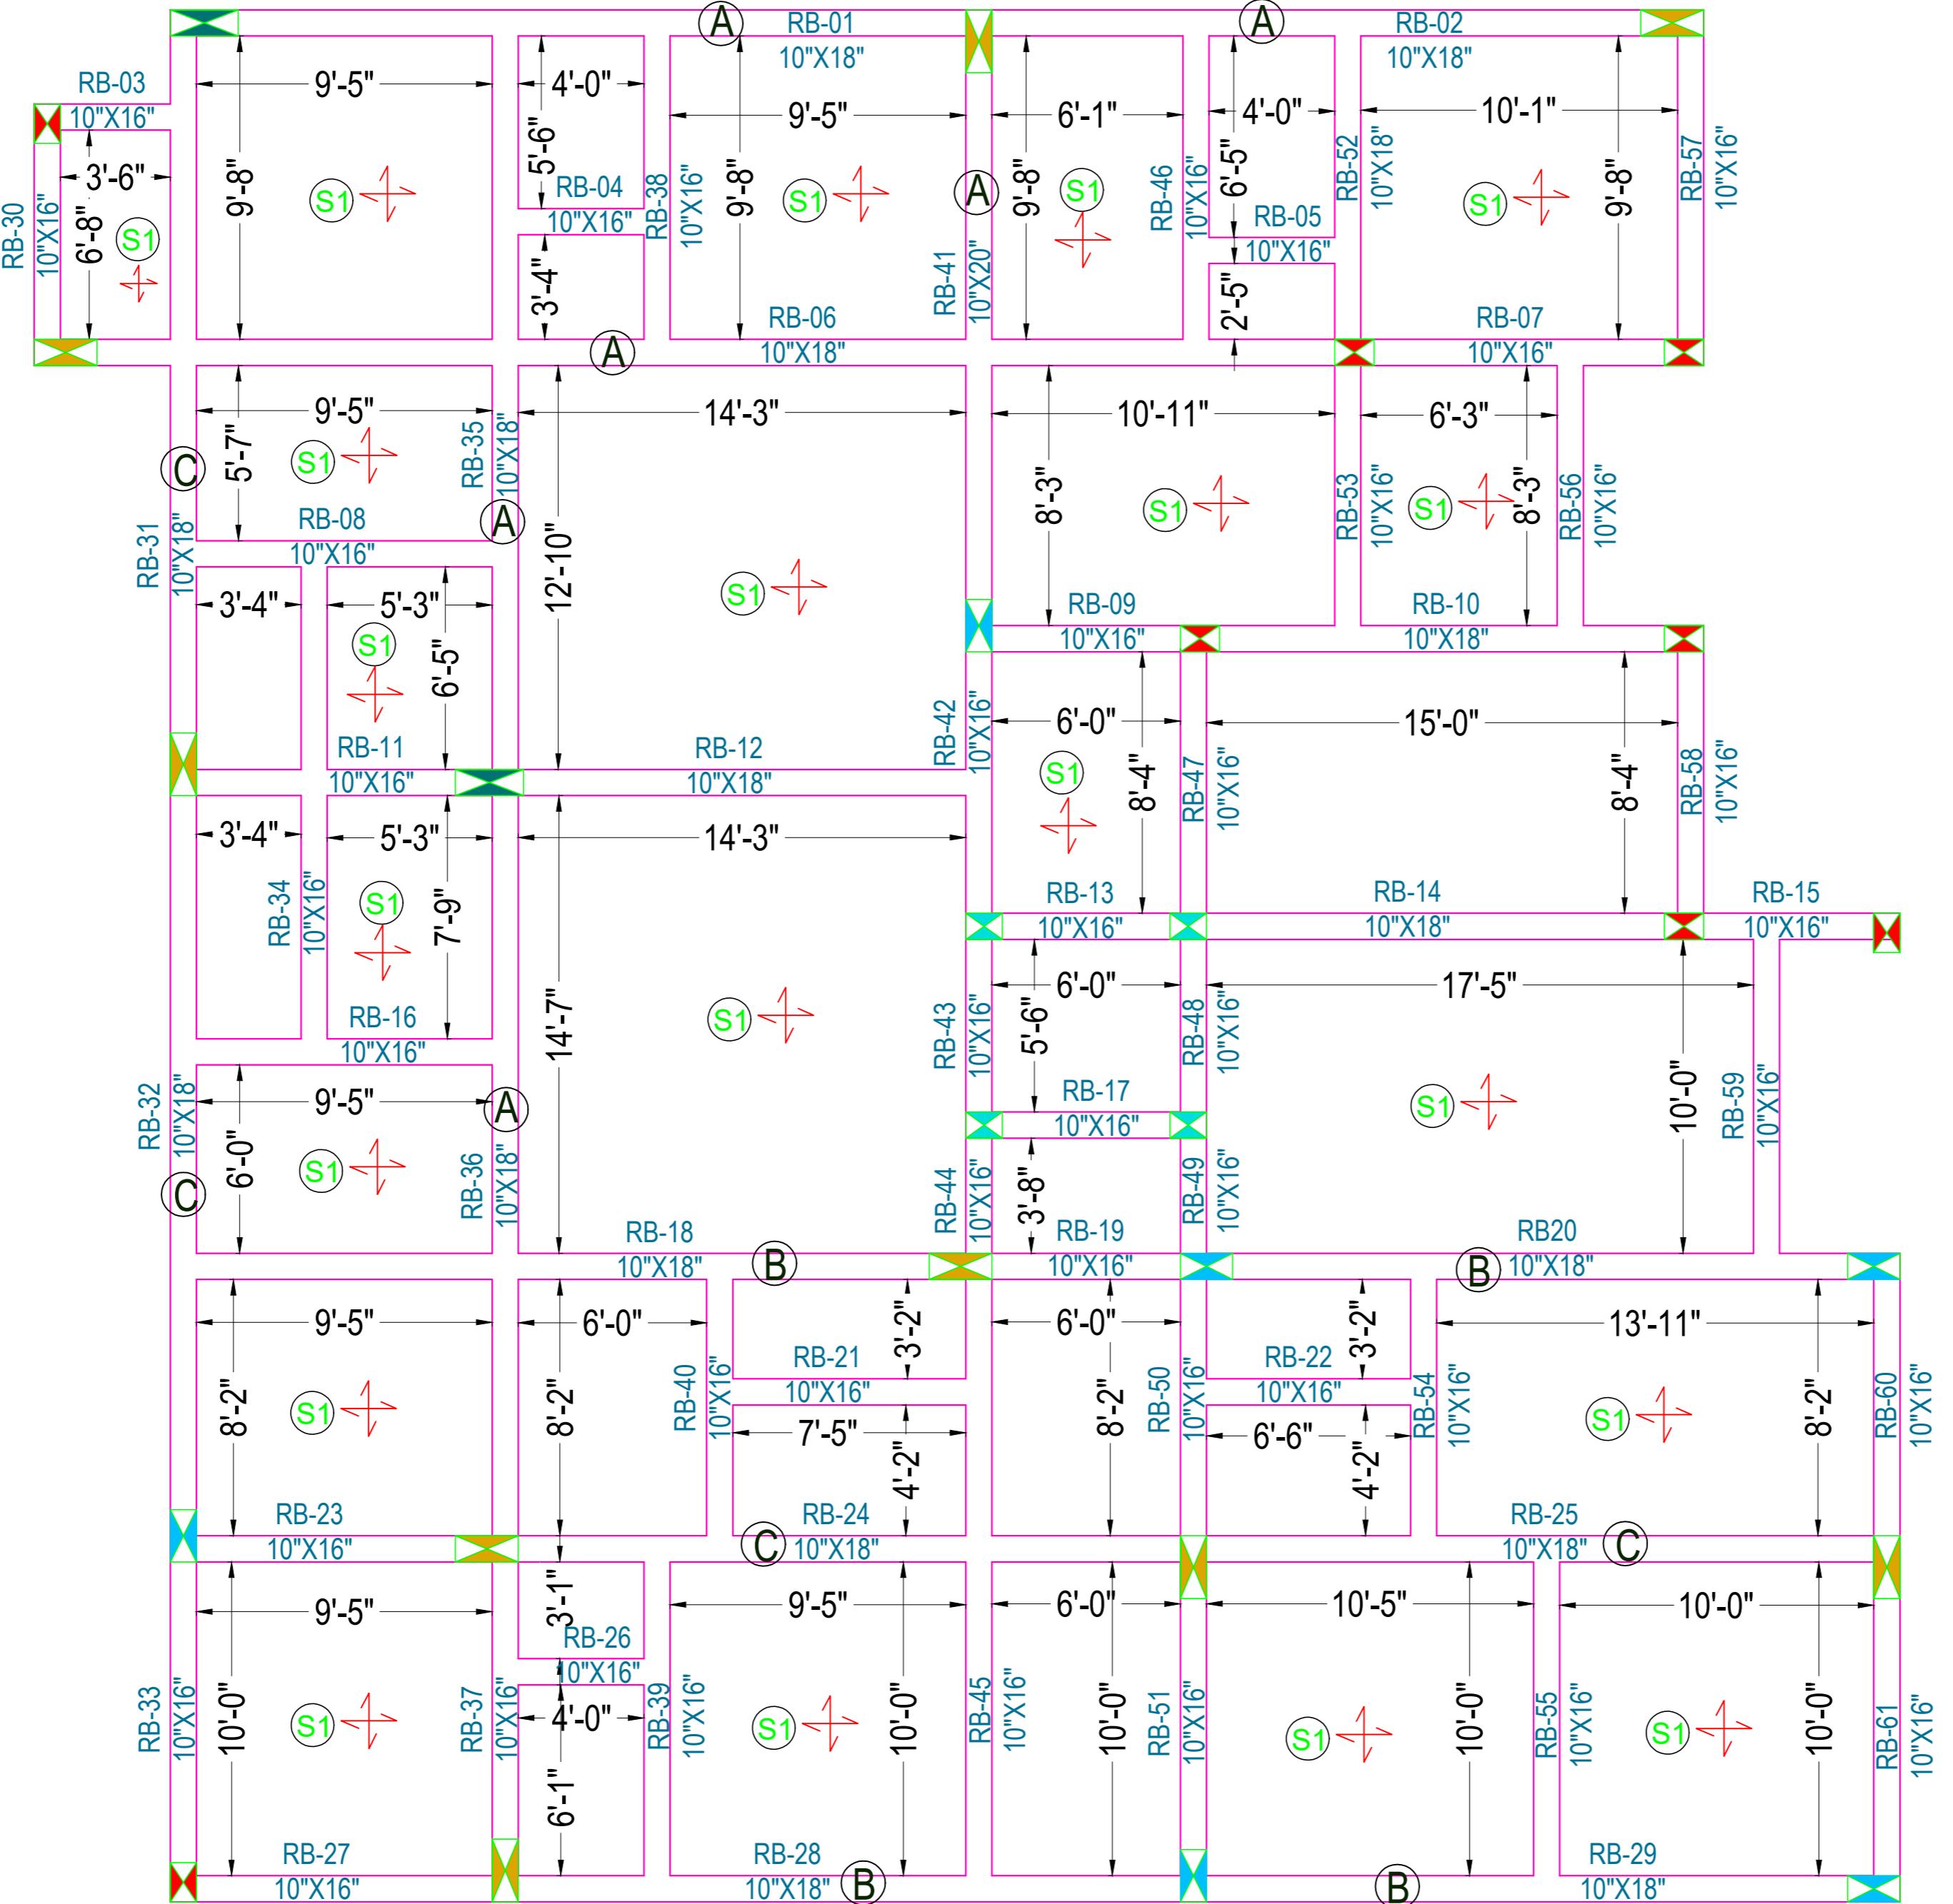DRAWN:- AR. DHANESHWARI
DESIGN:- ER. PABITRA

PROJECT TITLE:-
K.I.P SOUMYA


STATUS:
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DATE: 04-05-2022
SCALE: NTS
DWG NO: 25


DRAWING TITLE:-
**FOURTH FLOOR
ROOF BEAM
SHUTTERING PLAN**


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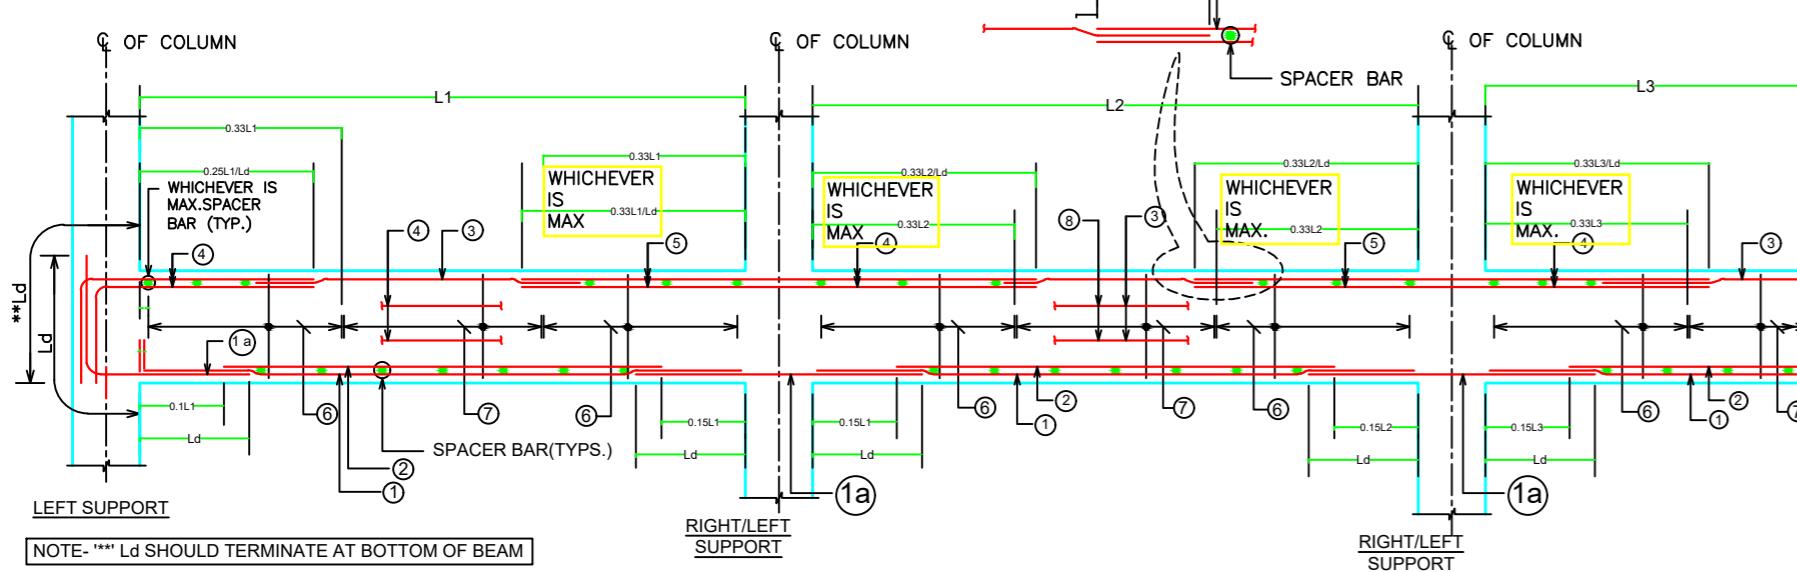


FOURTH FLOOR ROOF BEAM SHUTTERING PLAN

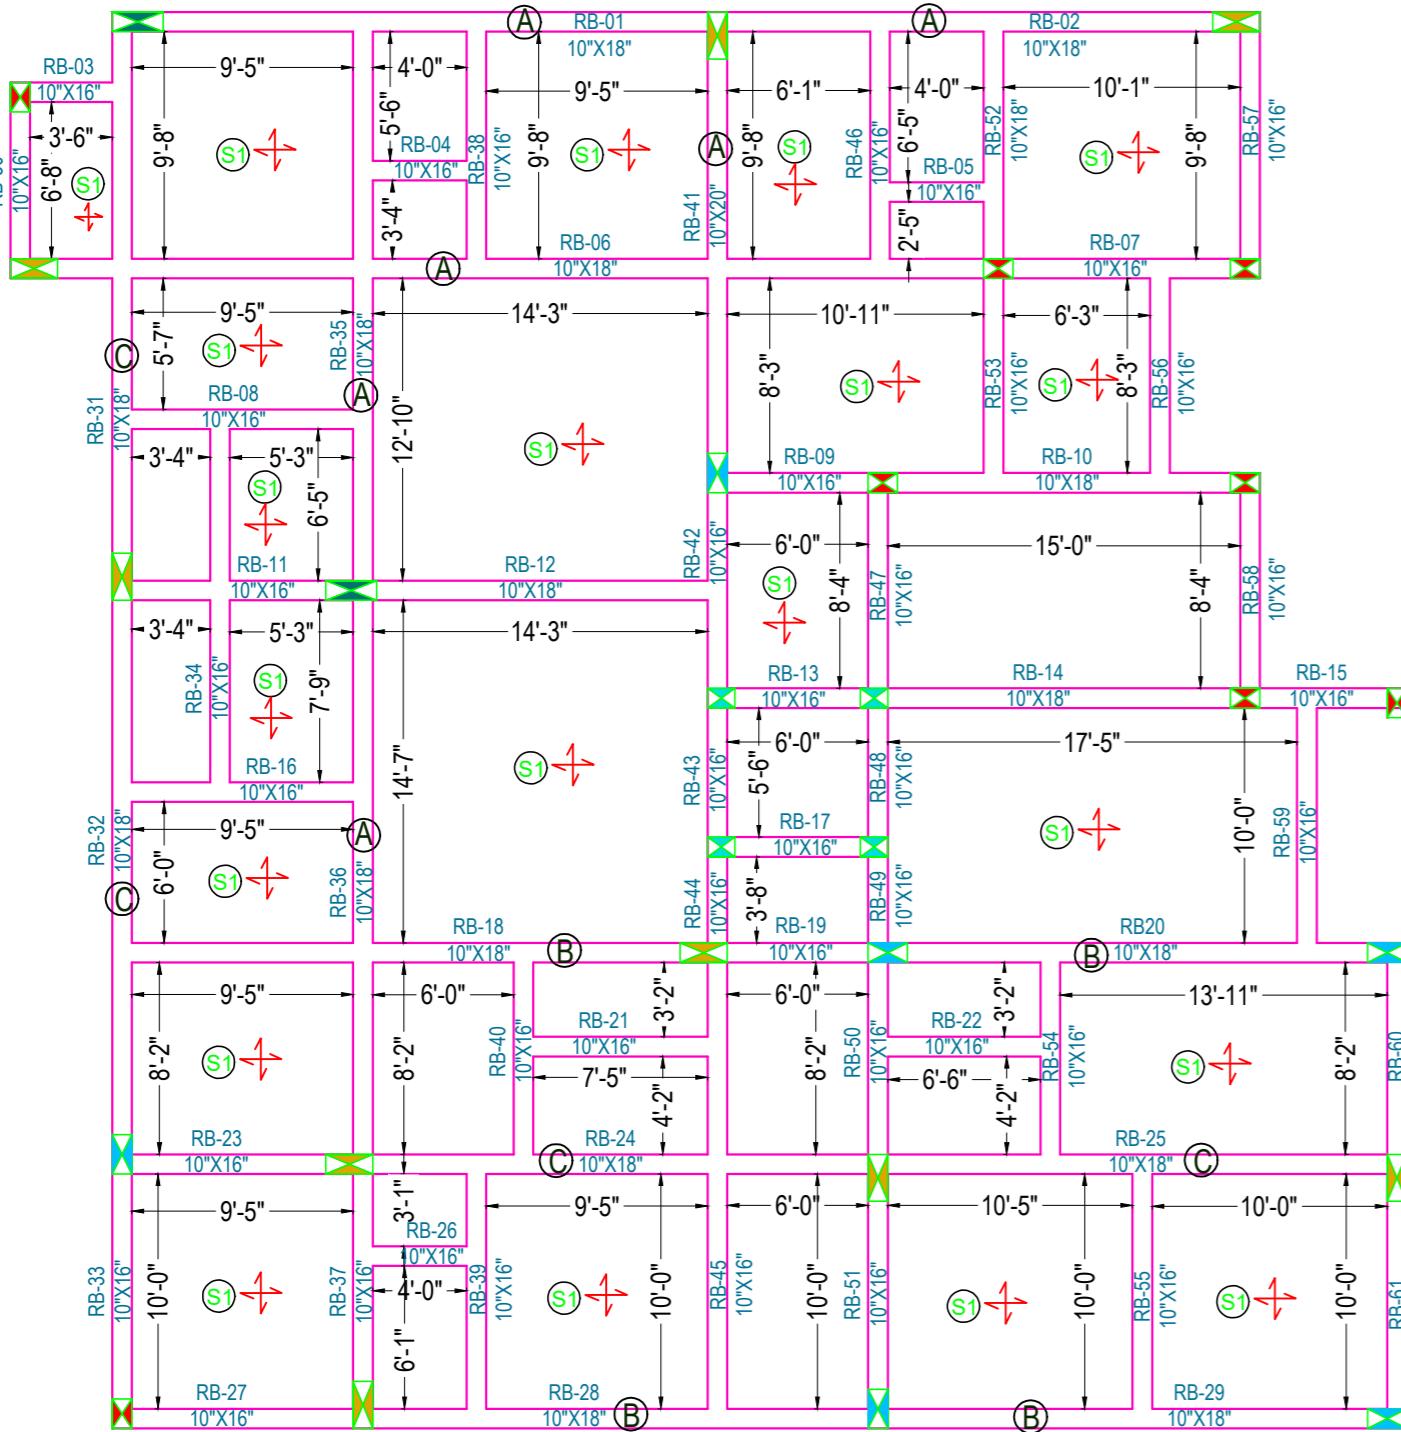


TYPICAL CURTAILMENT DETAIL OF REINFORCEMENT IN SLAB

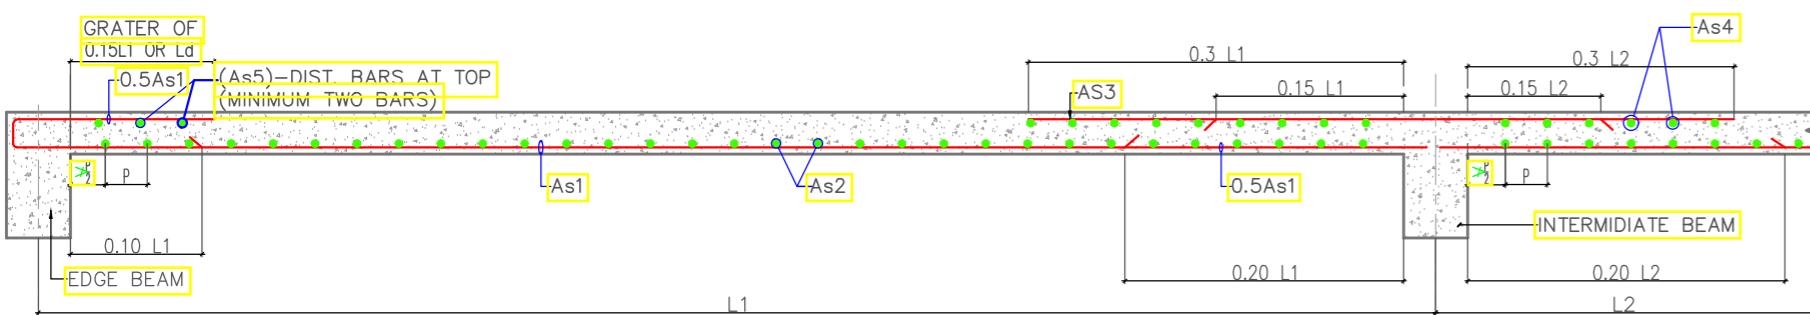As1 & As2 - BOTTOM REINF.
As3 & As4 - TOP REINF. AT CONTINUOUS EDGE
As5 - TOP REINF. AT DISCONTINUOUS EDGE




TYPICAL DETAILS OF CONTINUOUS BEAM

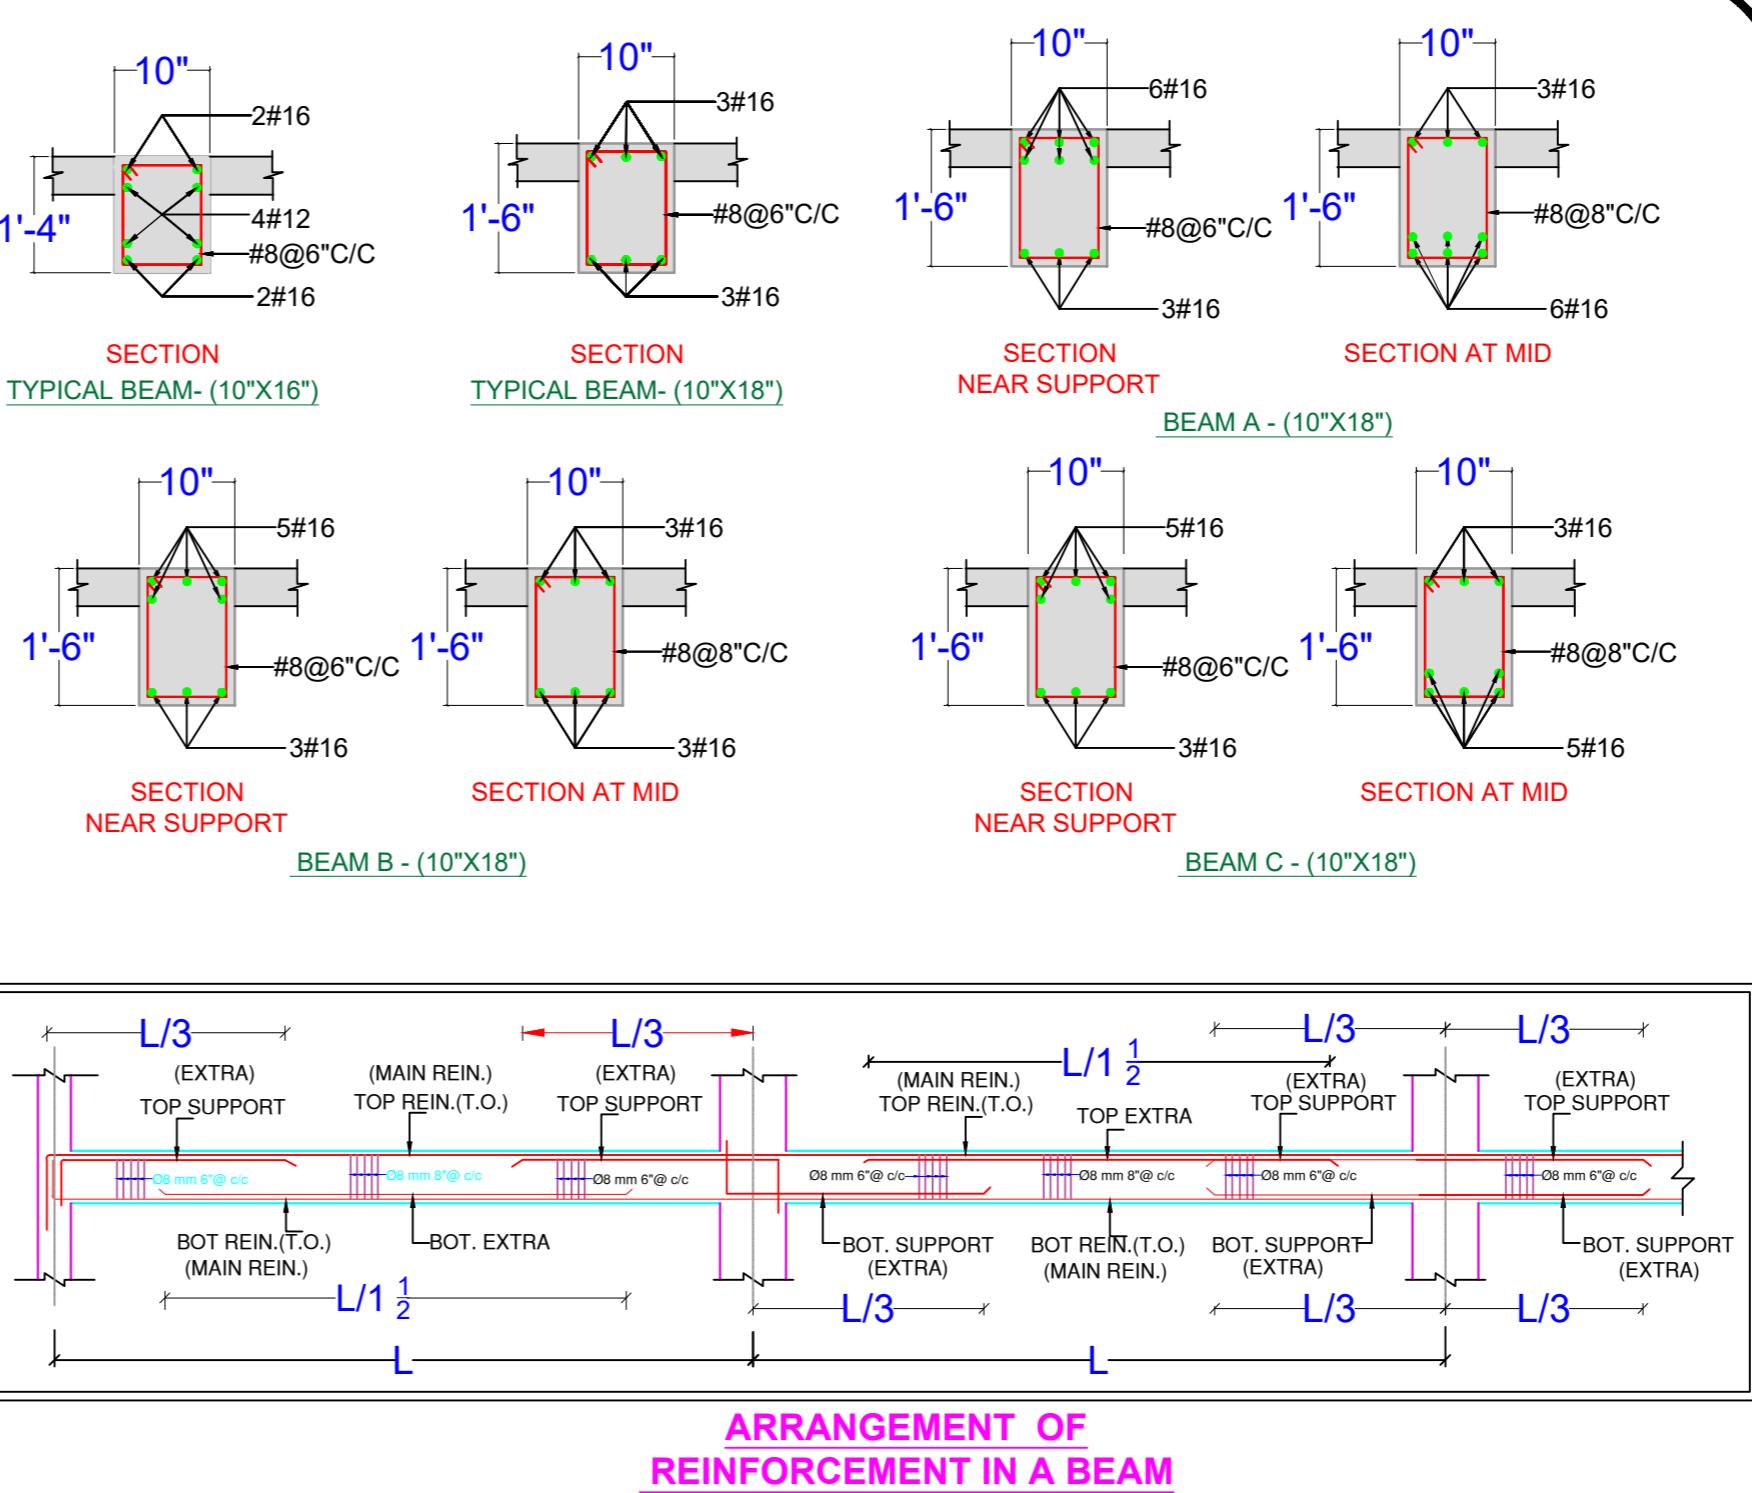

CONC. MIX. SHALL BE M-25 FOR SLAB

SLAB NO.	DEPTH	REINFORCEMENT			
		SPAN(As1/As2)		SUPPORT(As3/As4/As5)	
		SHORTER SPAN	LONGER SPAN	SHORTER SPAN	LONGER SPAN
S1	5"	T8@6"C/C	T8@6"C/C	T8@6"C/C	T8@6"C/C

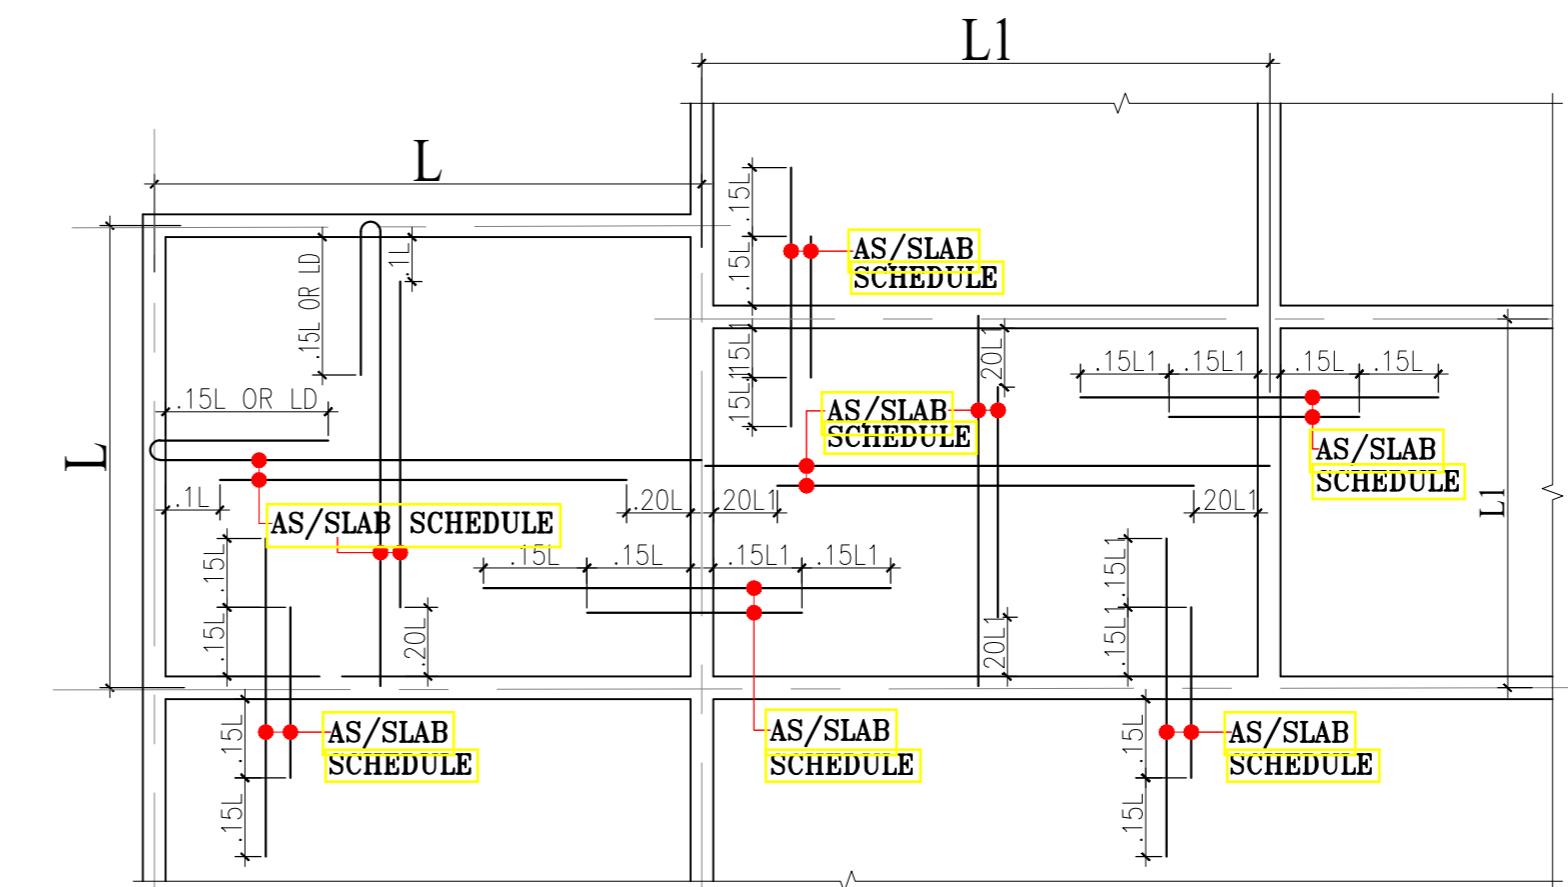

TYPICAL DETAILS OF SLAB SHOWING REINFORCEMENT

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- CLEAR COVER TO MAIN REINFORCEMENT SHALL BE FOR COLUMN - 40MM, BEAM-25MM, SLAB - 20MM.
- FOOTING-50MM, BEAM-25MM, SLAB - 20MM.
- THE MIX FOR ALL R.C.C. WORK SHALL BE M-20 (1:1.5:3).
- ALL THE REINFORCEMENT SHALL BE F-500(HYD BARS).
- MINIMUM DEVELOPMENT LENGTH FOR TOR STEEL SHALL BE 50d, WHERE "d" IS DIA OF MAIN REINFORCEMENT.
- THE LAP SHALL BE STAGGERED AND AVOIDED AT THE POINT OF MAXIMUM BENDING MOMENT.
- ALL DIMENSION & LEVEL ARE IN FEET-INCH.

SIGNATURE :-

DRAWN:- AR. DHANESHWARI

DESIGN:- ER. PABITRA

PROJECT TITLE:-

K.I.P SOUMYA

STATUS:

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DATE: 04-05-2022

SCALE NTS

DWG NO: 26


DRAWING TITLE:-

FOURTH FLOOR ROOF BEAM SHUTTERING PLAN & DETAILING




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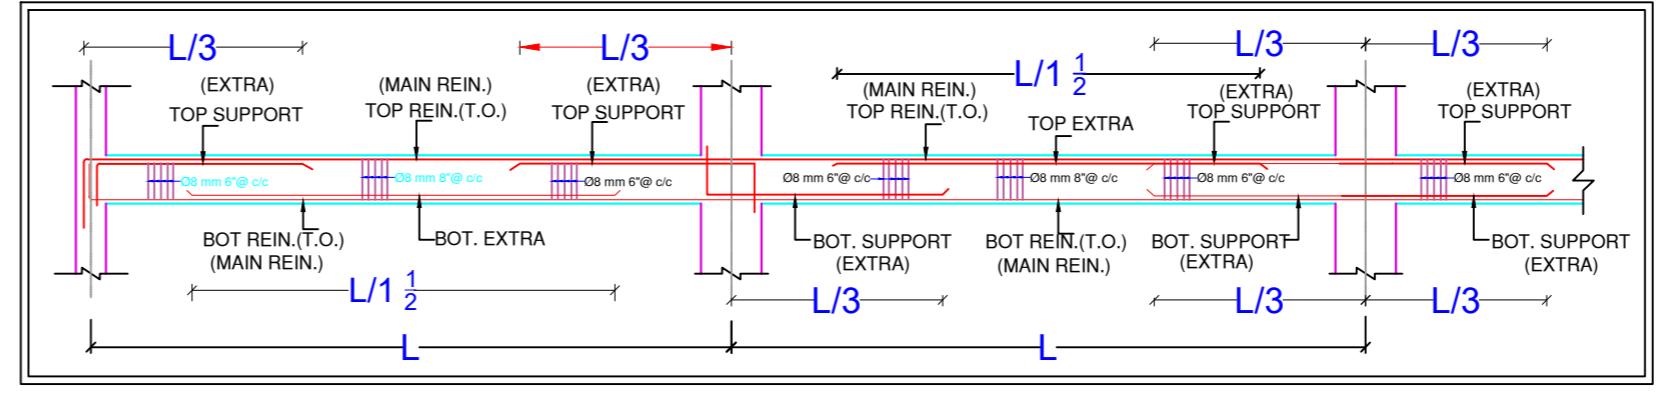
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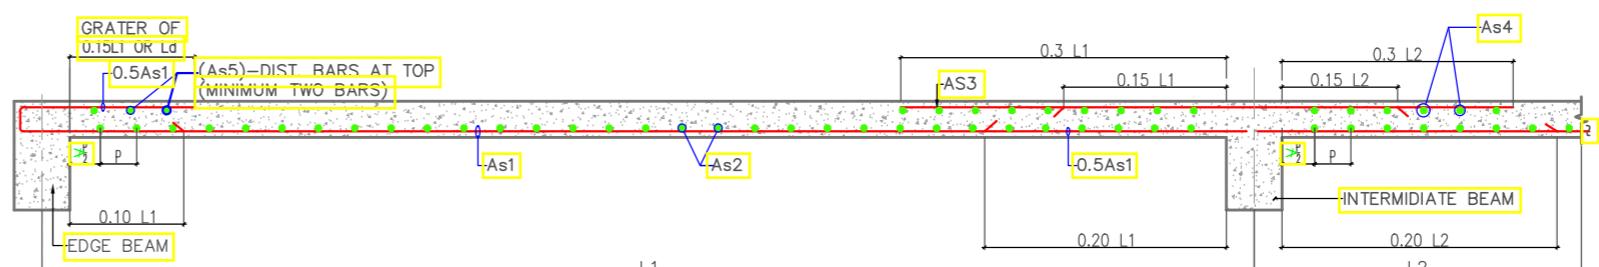
MUMMTY FLOOR ROOF BEAM SHUTTERING PLAN

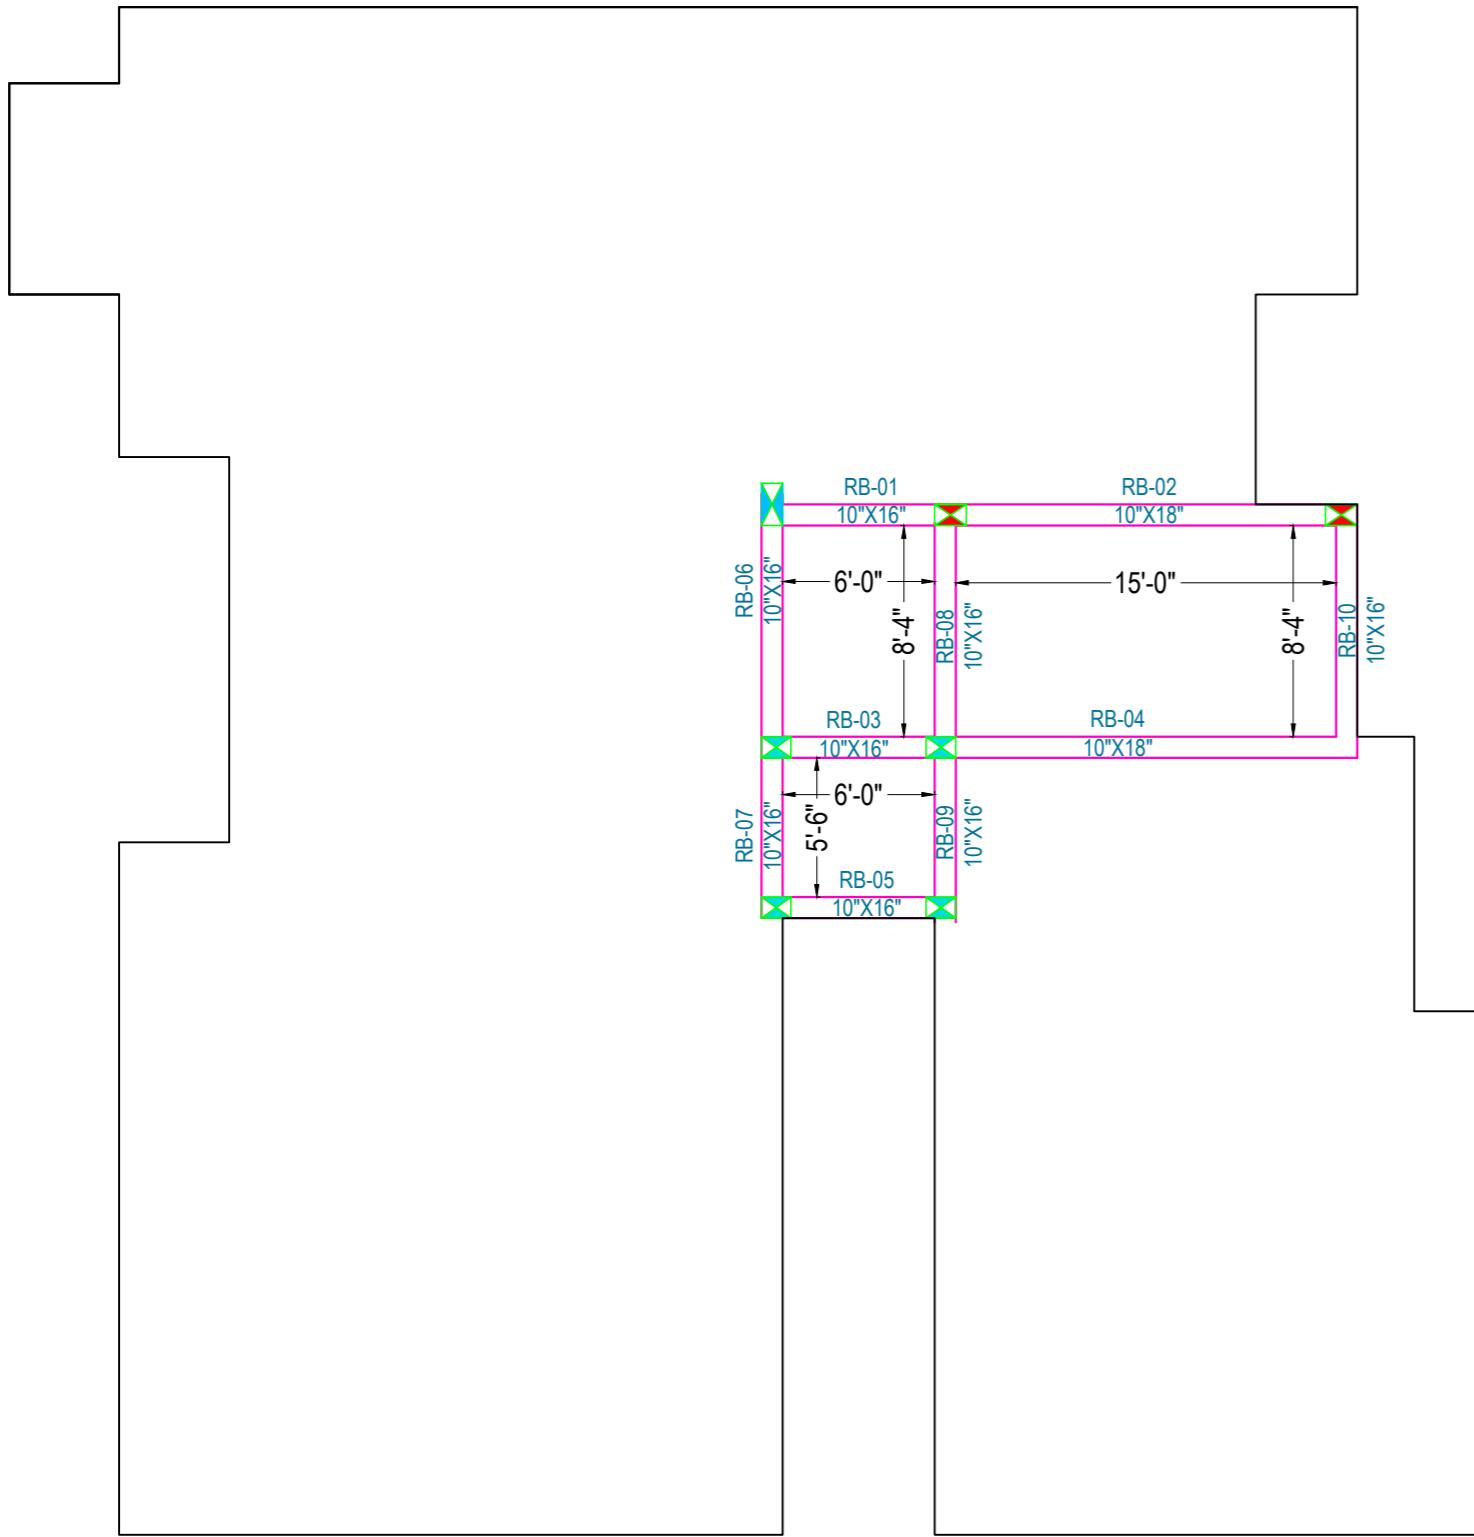

TYPICAL DETAILS OF CONTINUOUS BEAM

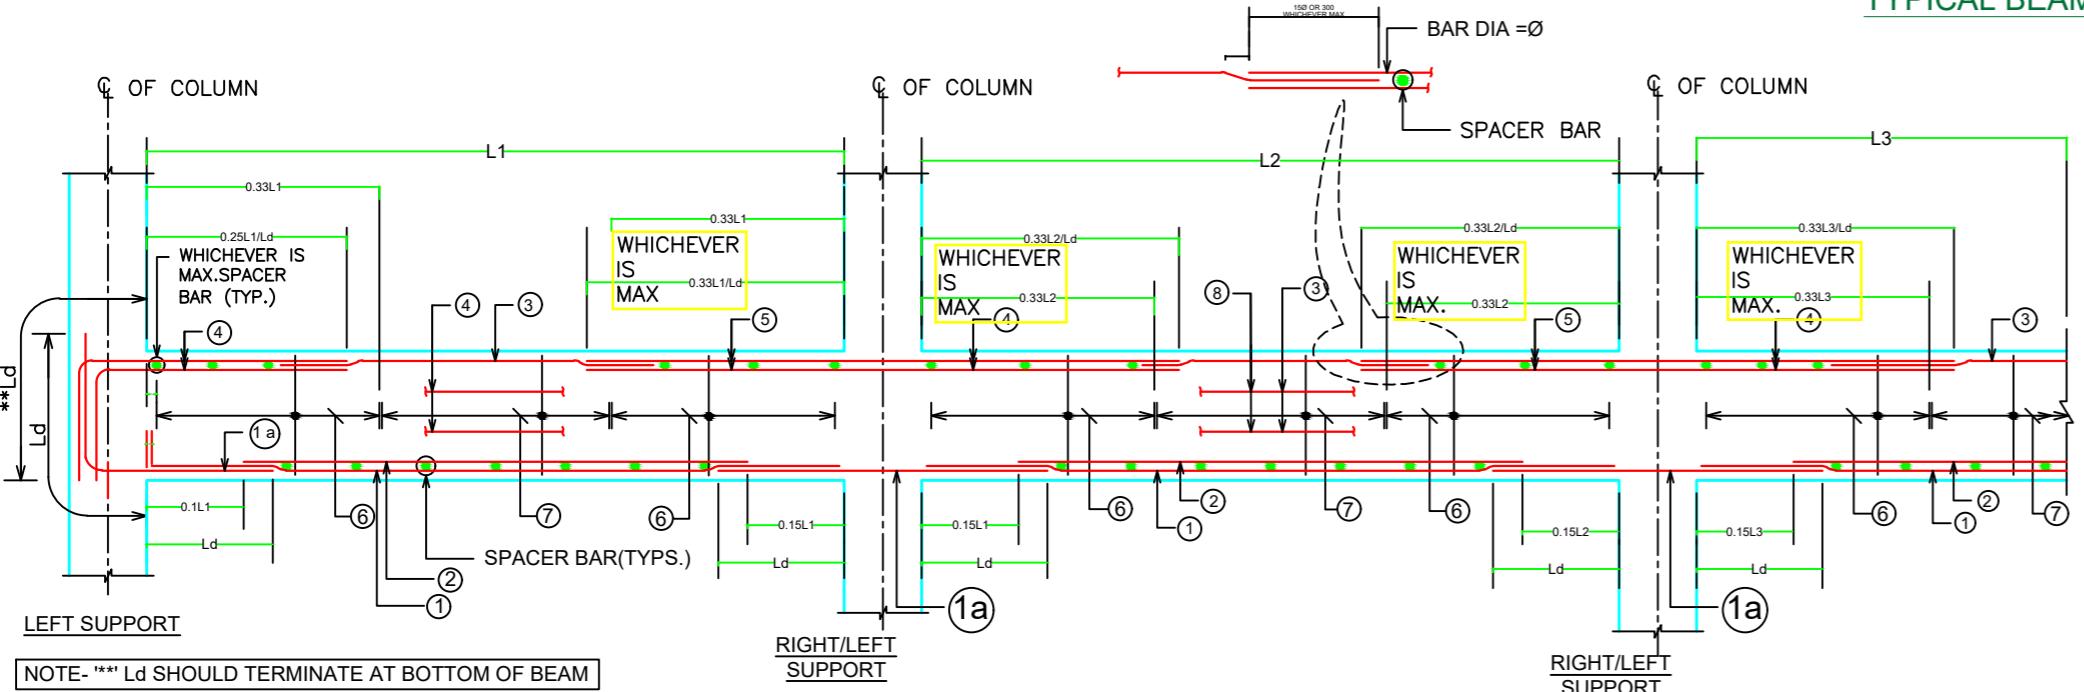

ARRANGEMENT OF REINFORCEMENT IN A BEAM




TYPICAL CURTAILMENT DETAIL OF REINFORCEMENT IN SLAB


AS1 & AS2 - BOTTOM REINF.
AS3 & AS4 - TOP REINF. AT CONTINUOUS EDGE
AS5 - TOP REINF. AT DISCONTINUOUS EDGE

CONC. MIX. SHALL BE M-25 FOR SLAB


SLAB NO.	DEPTH	REINFORCEMENT			
		SPAN(As1/As2)		SUPPORT(As3/As4/As5)	
		SHORTER SPAN	LONGER SPAN	SHORTER SPAN	LONGER SPAN
S1	5"	T8@6"C/C	T8@6"C/C	T8@6"C/C	T8@6"C/C

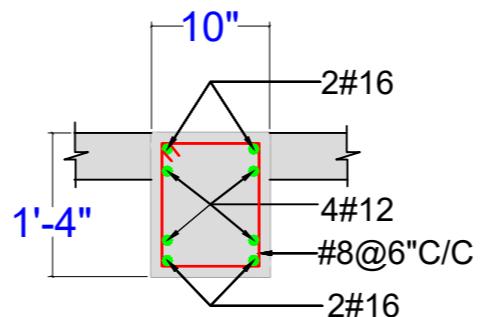


**SECTION
TYPICAL BEAM- (10"X16")**

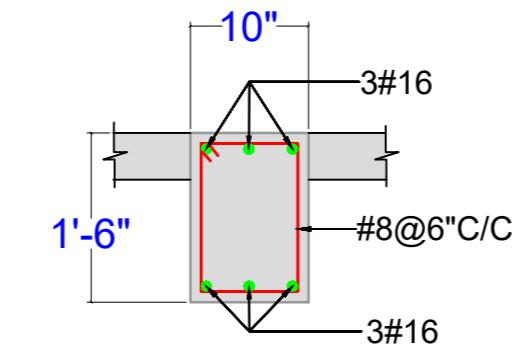

**SECTION
TYPICAL BEAM- (10"X18")**

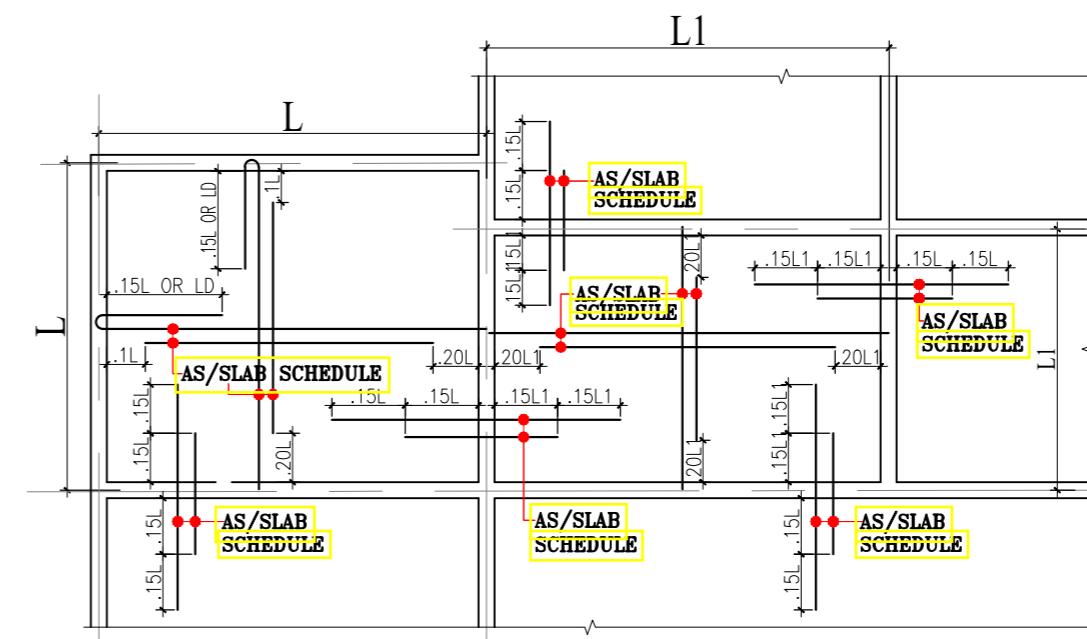

TYPICAL DETAILS OF SLAB SHOWING REINFORCEMENT

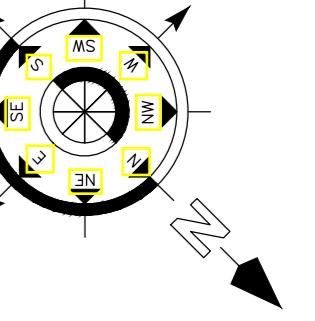

Note:

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- ANY DISCREPANCY IN THE DRAWING SHOULD BE BROUGHT TO THE KNOWLEDGE OF CONSULTANT BEFORE EXECUTION.
- ALL DIMENSIONS TAKEN FOR (G-2) FLOORS ONLY.
- CLEAR COVER TO MAIN REINFORCEMENT SHALL BE FOR COLUMN - 40MM, PLINTH BEAM - 30MM.
- FOOTING-50mm, BEAM-25mm, SLAB - 20mm.
- THE MIX FOR ALL R.C.C. WORK SHALL BE M-20 (1:1.5:3).
- ALL THE REINFORCEMENT SHALL BE F-600(HSD BARS).
- MINIMUM DEVELOPMENT LENGTH FOR T-STEEL SHALL BE 50d, WHERE "d" IS DIA OF MAIN REINFORCEMENT.
- THE LAP SHALL BE STAGGERED AND AVOIDED AT THE POINT OF MAXIMUM BENDING MOMENT.
- ALL DIMENSION & LEVEL ARE IN FEET-INCH.

SIGNATURE :-

DRAWN:- AR. DHANESHWARI

DESIGN:- ER. PABITRA

PROJECT TITLE:-

K.I.P SOUMYA

STATUS:

ISSUED FOR CONSTRUCTION

DATE: 04-05-2022

SCALE NTS

DWG NO: 27

DRAWING TITLE:-


**MUMMTY FLOOR
ROOF BEAM**



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- ALL THE DIA IS TAKEN FOR (G+2) FLOORS ONLY.
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- FOOTING-50mm, BEAM-25mm, SLAB - 20mm .
- THE MIX FOR ALL R.C.C. WORK SHALL BE M-20 (1:1.5:3).
- ALL THE REINFORCEMENT SHALL BE Fe-500(HYSD BARS).
- MINIMUM DEVELOPMENT LENGTH FOR TOR STEEL SHALL BE 5d, WHERE "d" IS DIA OF MAIN REINFORCEMENT.
- THE LAP SHALL BE STAGGERED AND AVOIDED AT THE POINT OF MAXIMUM BENDING MOMENT .
- ALL DIMENSION & LEVEL ARE IN FEET-INCH.

SIGNATURE :-

DRAWN:- AR. DHANESHWARI

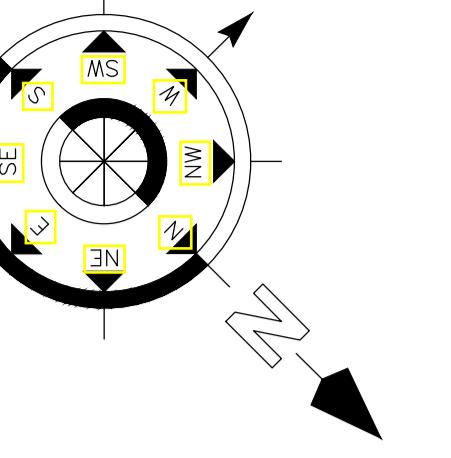DESIGN:- ER. PABITRA

PROJECT TITLE:-

K.I.P SOUMYA

STATUS:

ISSUED FOR CONSTRUCTION

DATE:	04-05-2022
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SCALE	NTS
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DWG NO:	28
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DRAWING TITLE:-

**BRICK WORK
DRAWING**




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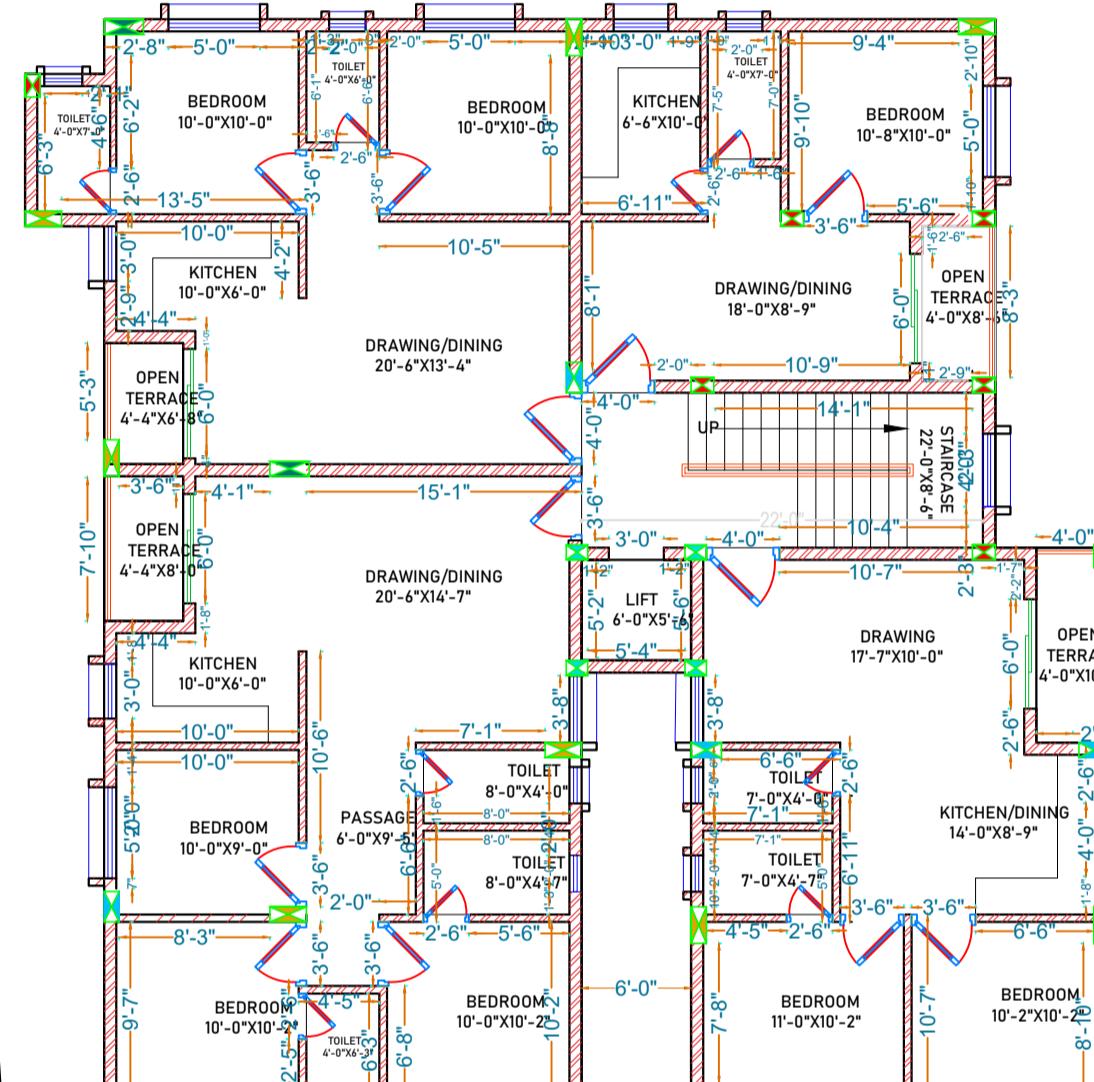
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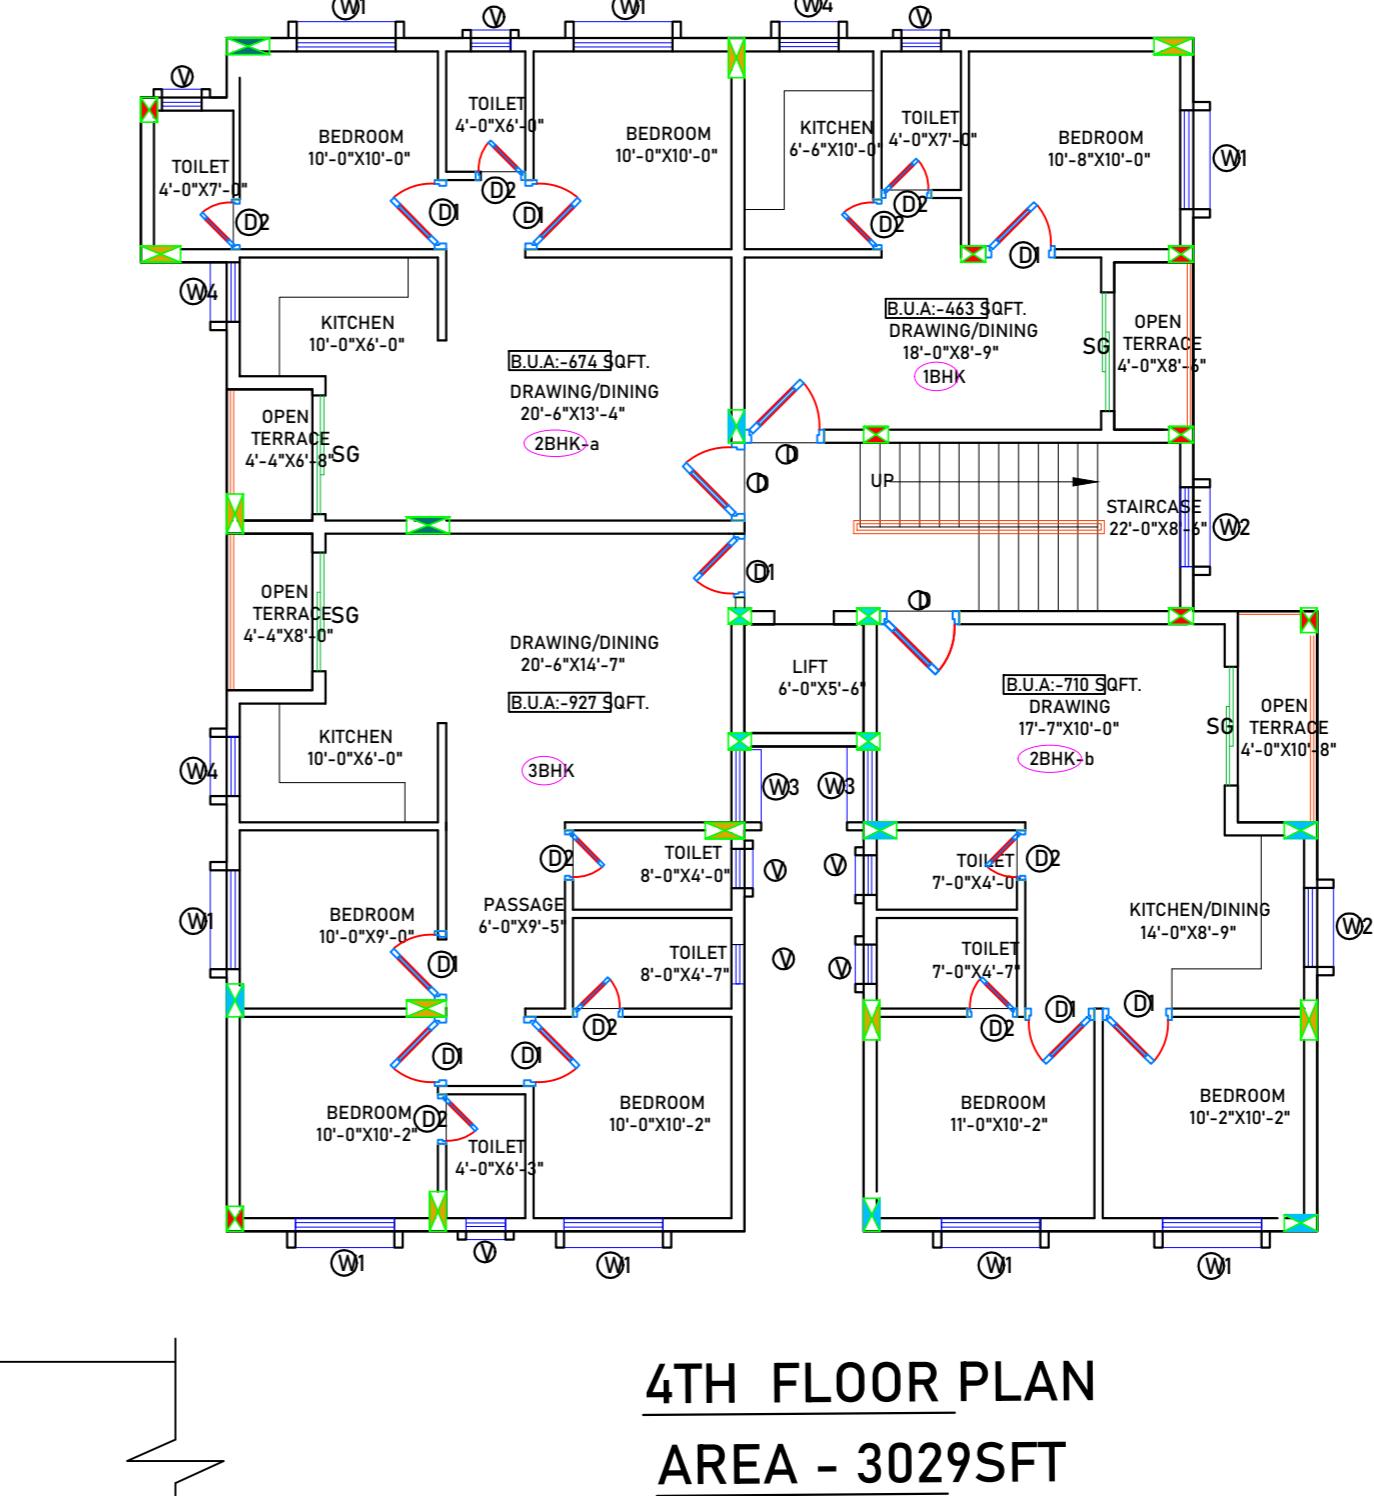
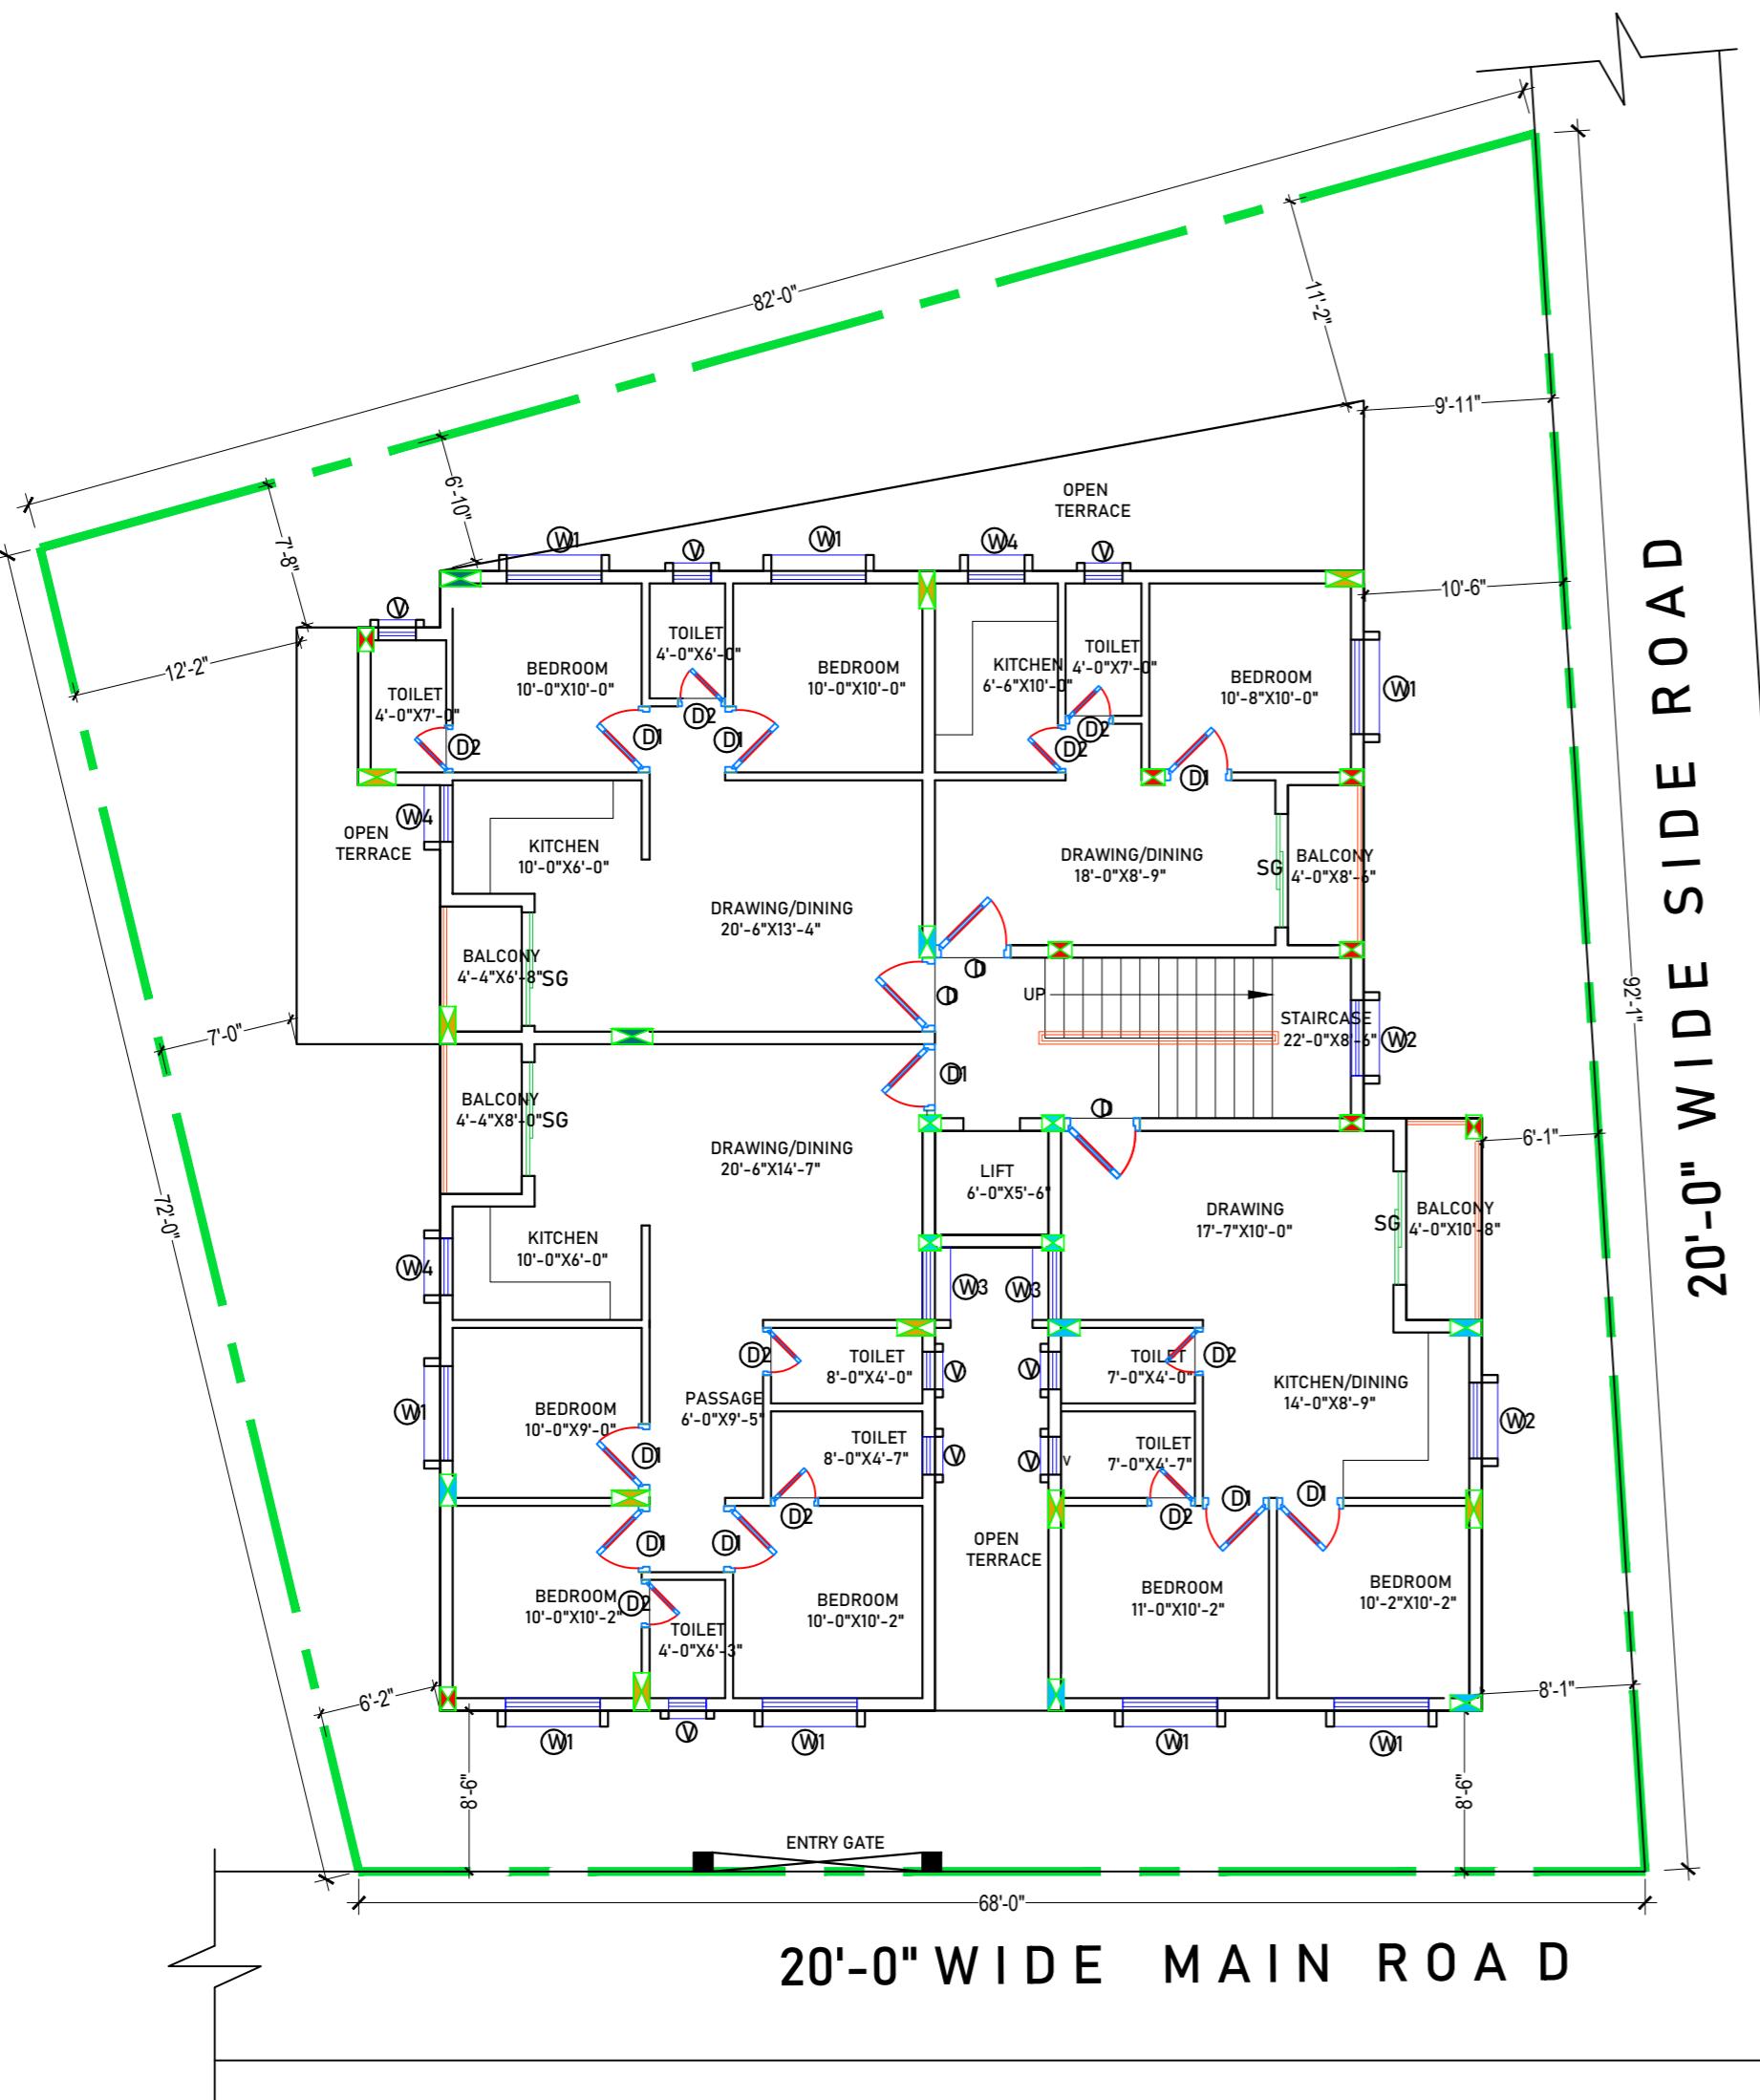
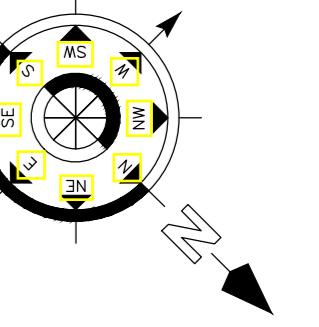
STILT ROOF AREA - 3527 SFT



STILT ROOF AREA - 3527 SFT
BUILDING AREA - 3029SFT

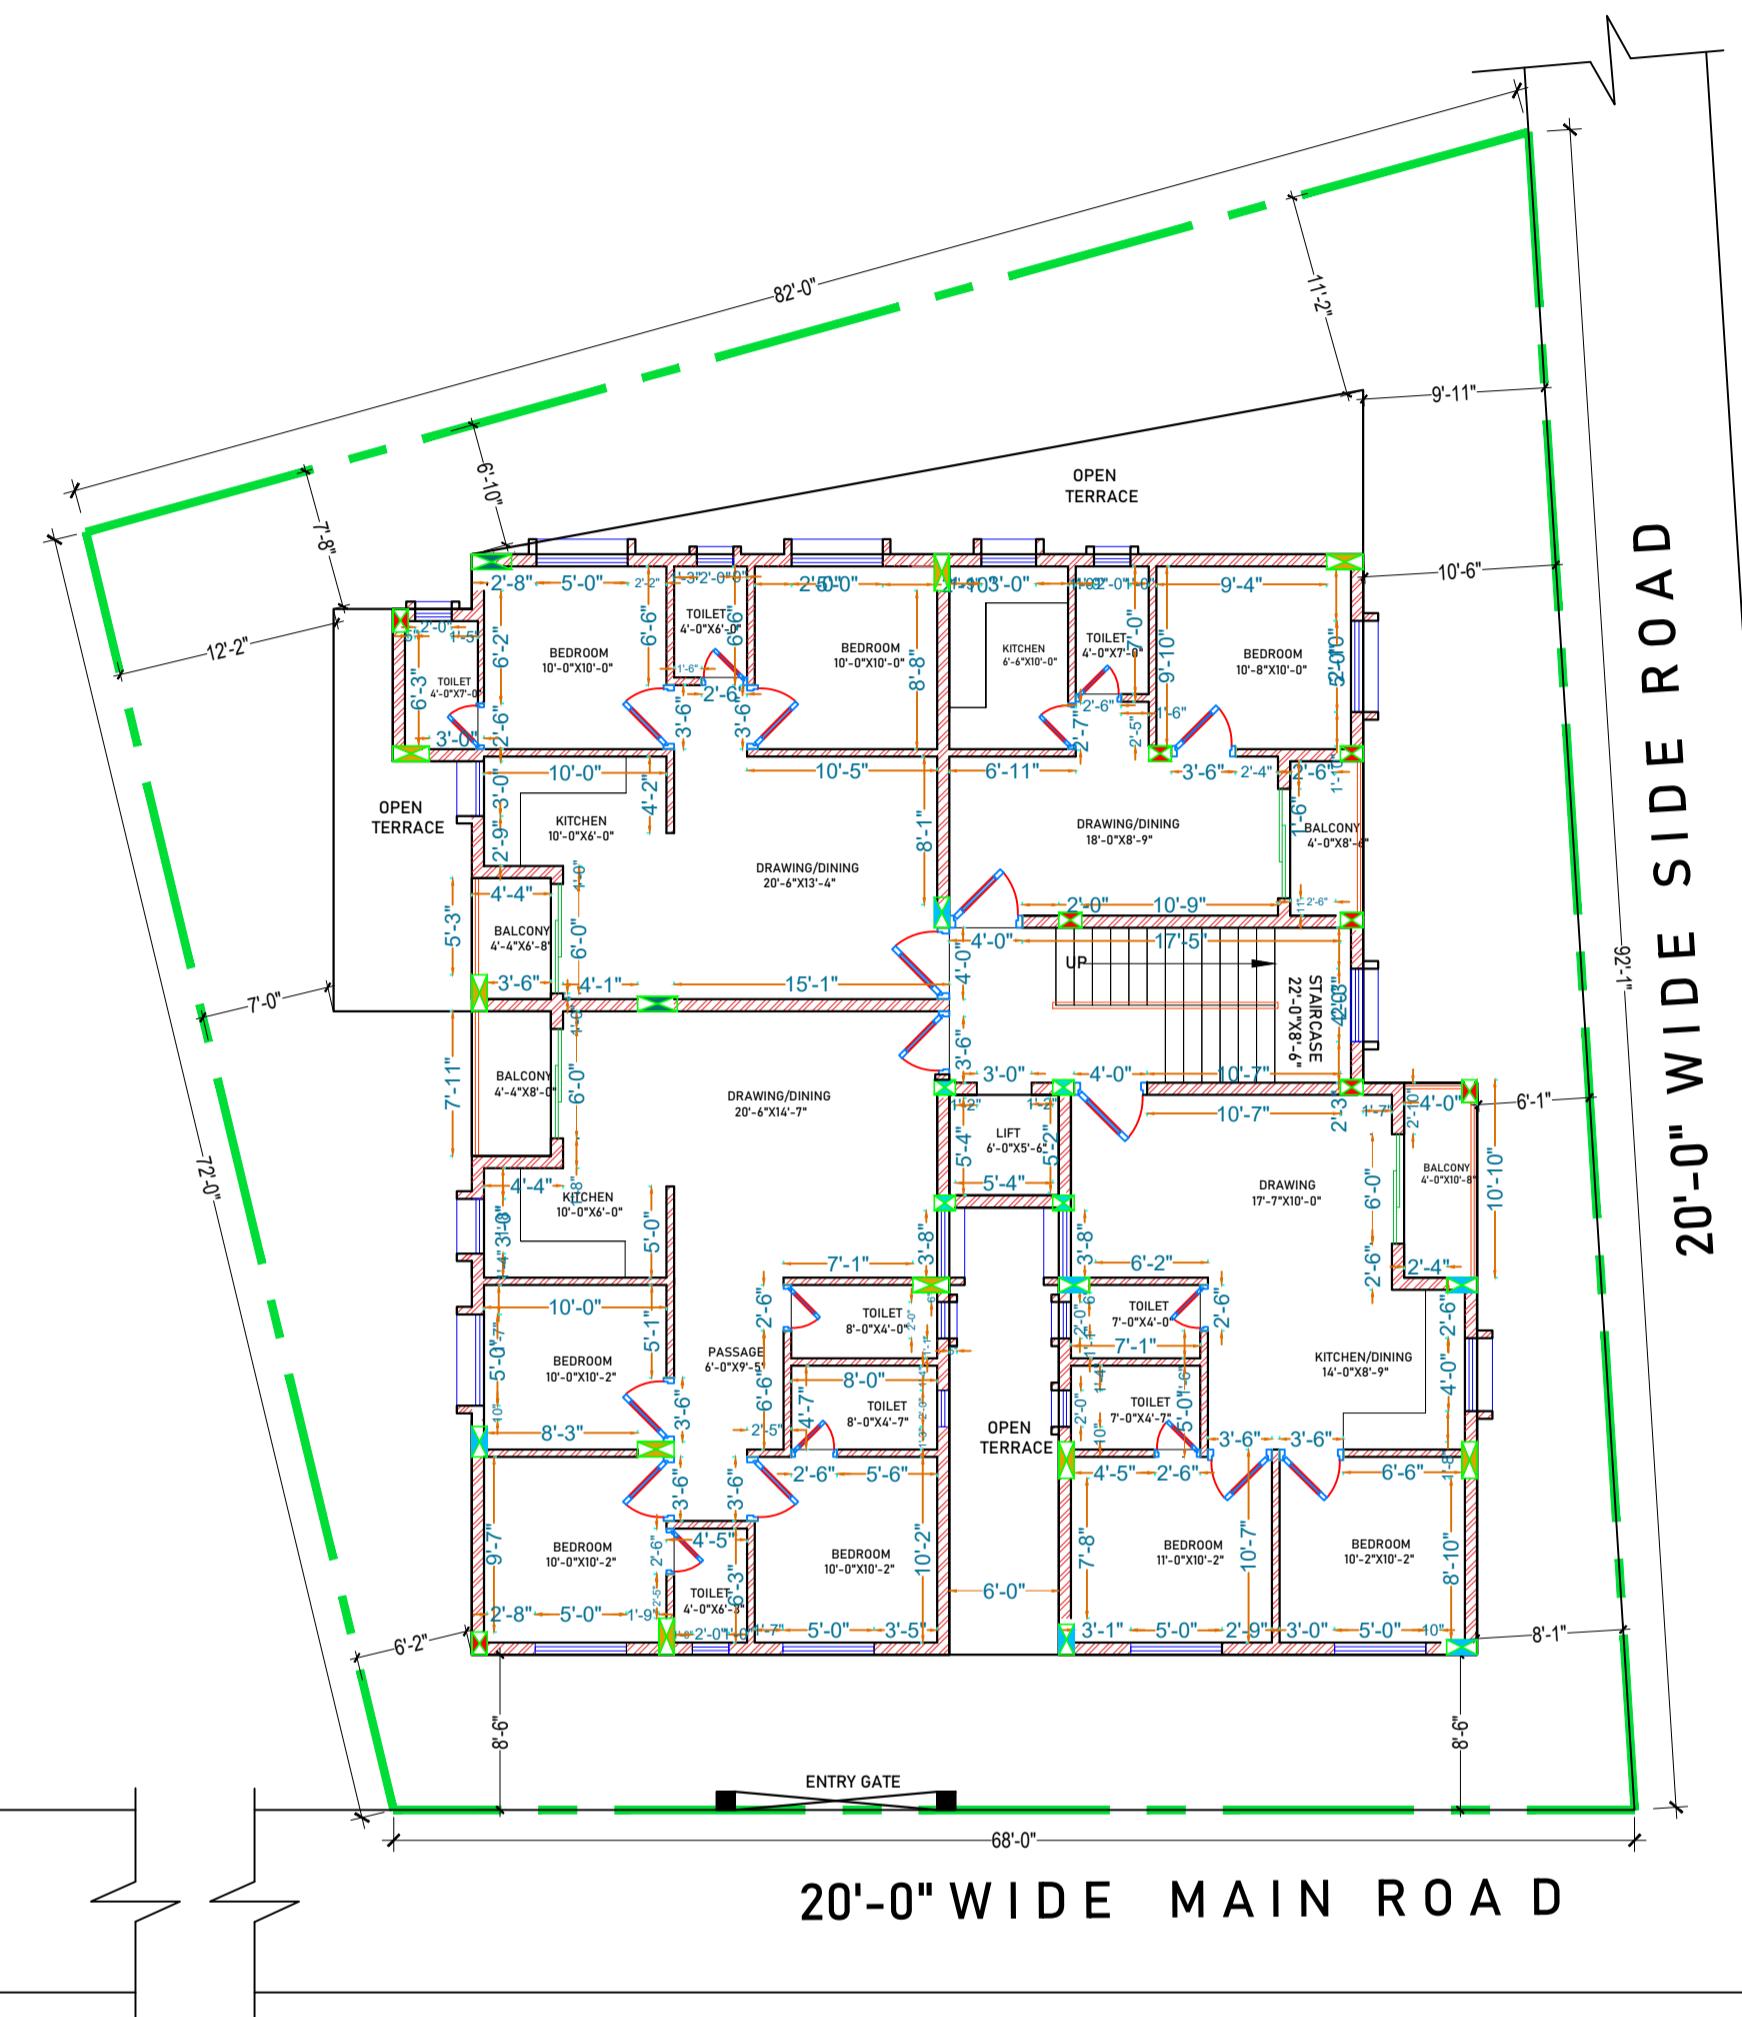

BRICK WORK DRAWING



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- ALL THE DATA TAKEN FOR (G+2) FLOORS ONLY.
- CLEAR COVER TO MAIN REINFORCEMENT SHALL BE FOR COLUMN - 40MM, PLINTH BEAM - 30MM.
- FOOTING-50mm, BEAM-25mm, SLAB - 20mm .
- THE MIX FOR ALL R.C.C. WORK SHALL BE M-20 (1:1.5:3).
- ALL THE REINFORCEMENT SHALL BE F-500(HYD BARS).
- MINIMUM DEVELOPMENT LENGTH FOR TOR STEEL SHALL BE 50d, WHERE "d" IS DIA OF MAIN REINFORCEMENT.
- THE LAP SHALL BE STAGGERED AND AVOIDED AT THE POINT OF MAXIMUM BENDING MOMENT .
- ALL DIMENSION & LEVEL ARE IN FEET-INCH.

SIGNATURE :-

DRAWN:- AR. DHANESHWARI

DESIGN:- ER. PABITRA

PROJECT TITLE:-

K.I.P SOUMYA

STATUS:

ISSUED FOR CONSTRUCTION

DATE: 04-05-2022

SCALE NTS

DWG NO: 29

DRAWING TITLE:-

















DOOR & WINDOW SCHEDULE



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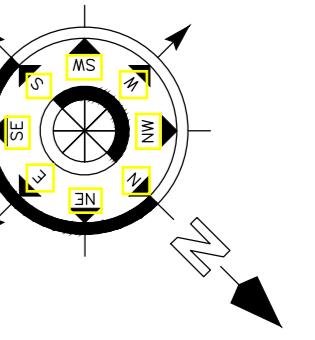
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DOOR & WINDOW SCHEDULE

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SIGNATURE :-

DRAWN:- AR. DHANESHWARI

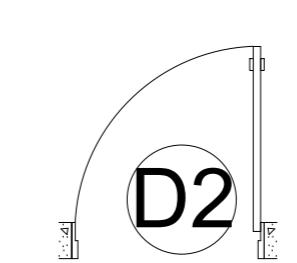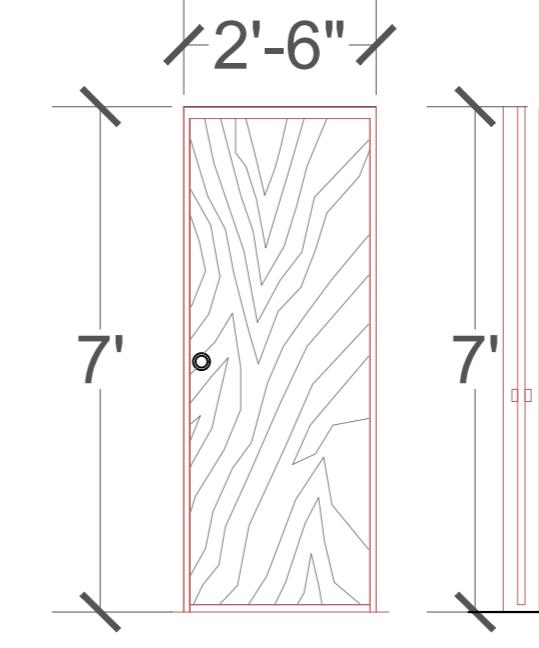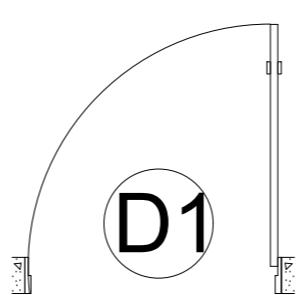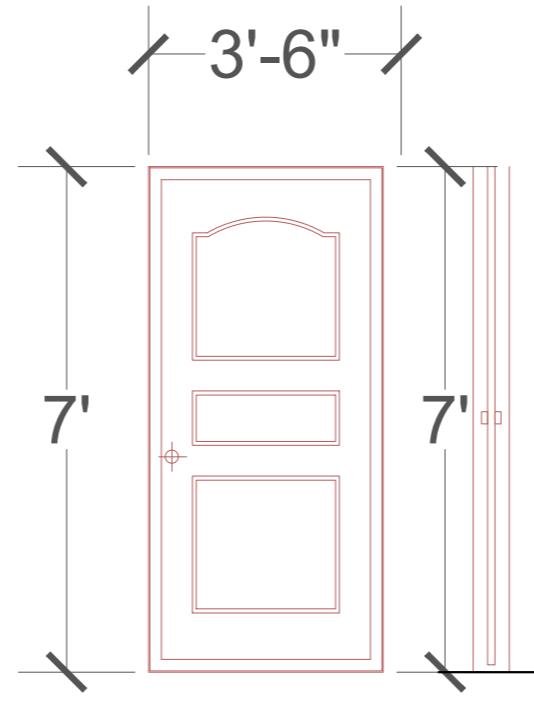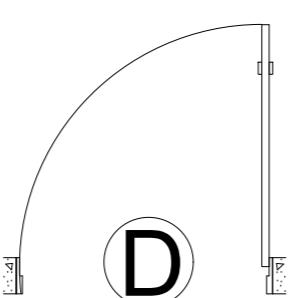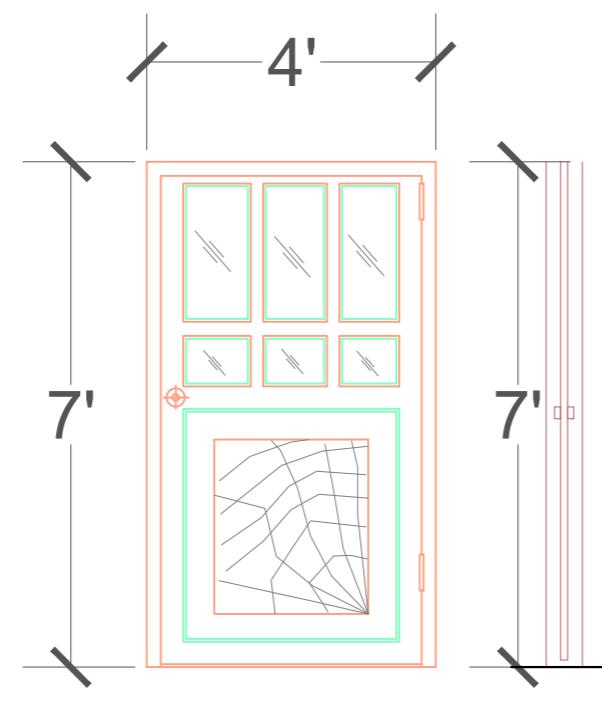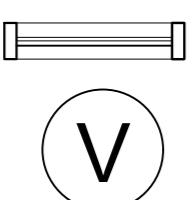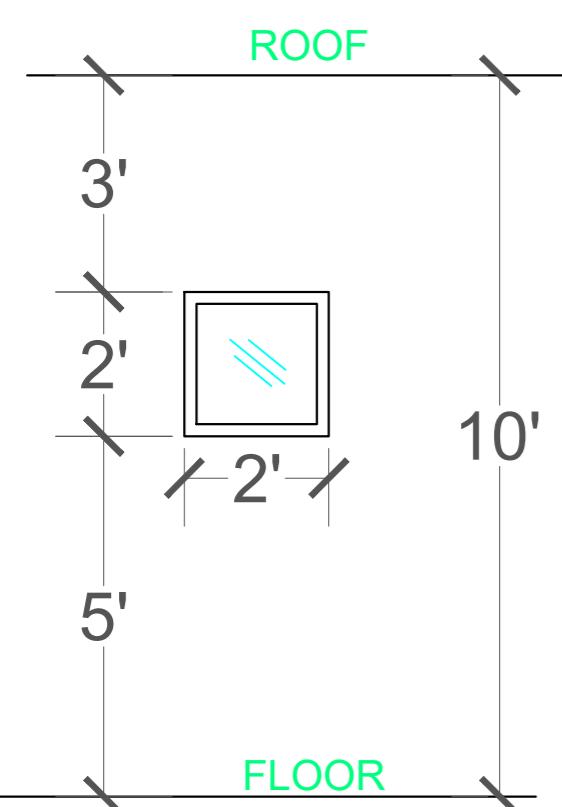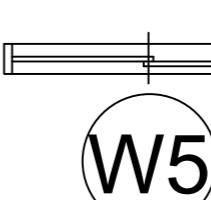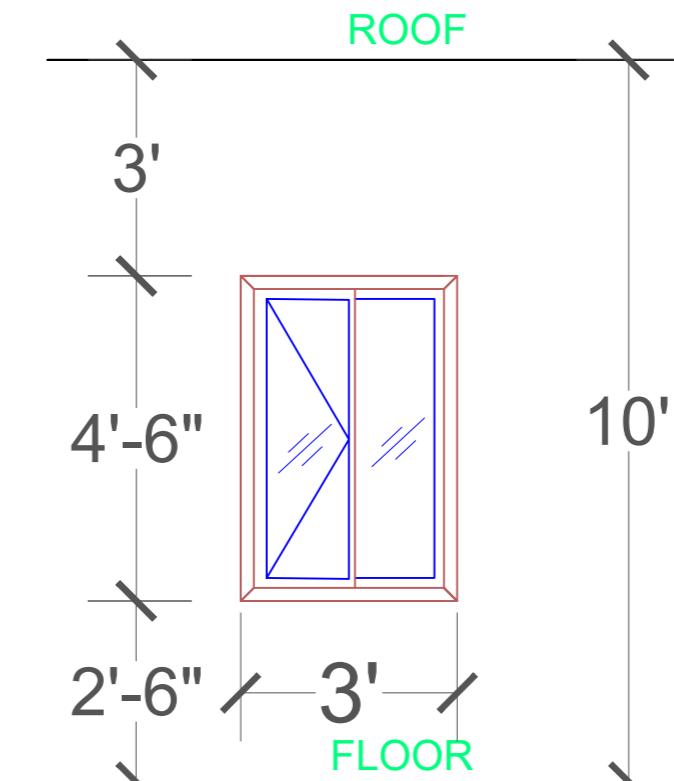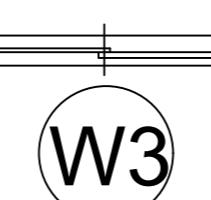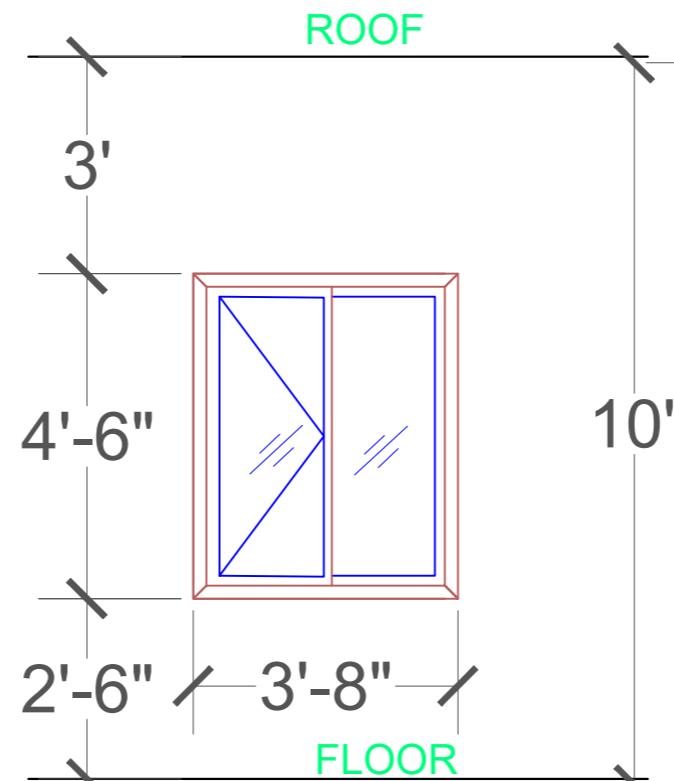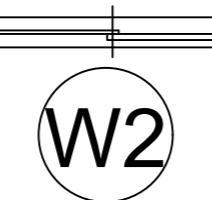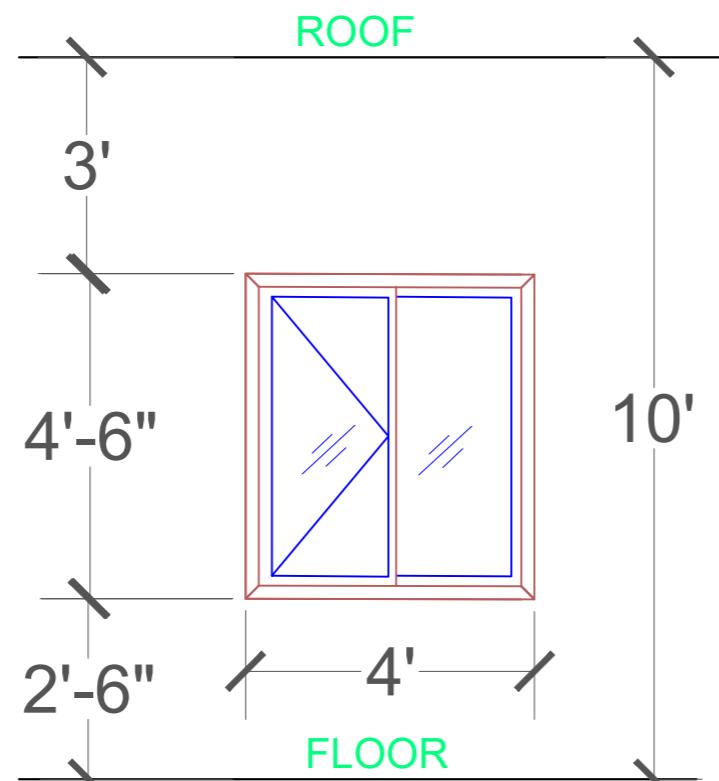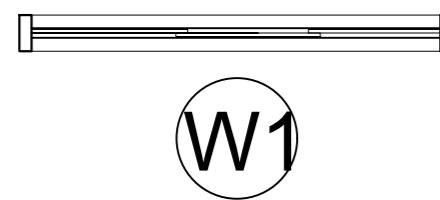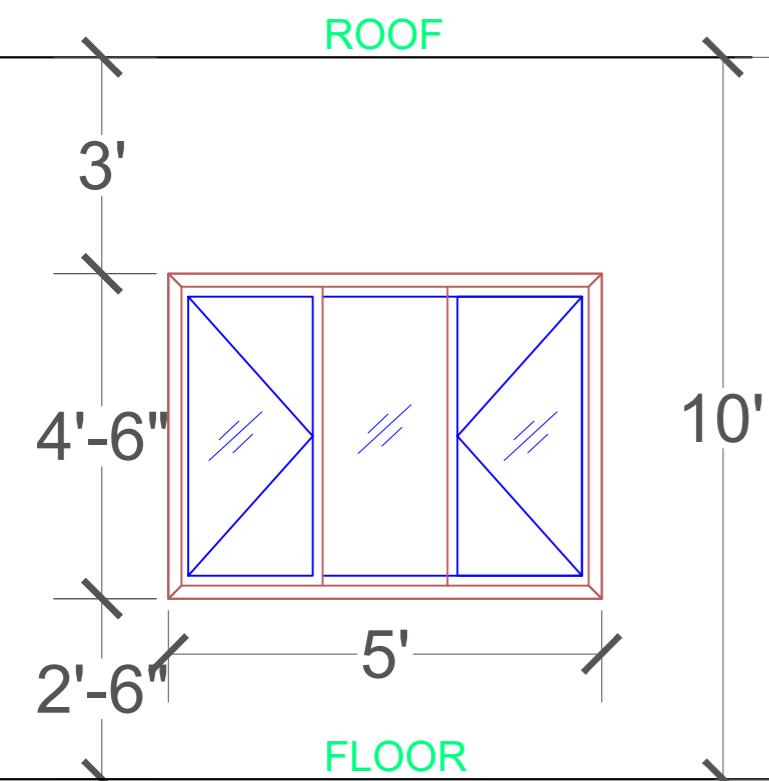DESIGN:- ER. PABITRA

PROJECT TITLE:-

RESIDENTIAL
APPARTMENT AT
JOYPORE

STATUS:

ISSUED FOR CONSTRUCTION

DATE:	18-12-2021
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SCALE	NTS
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DWG NO:	30
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DRAWING TITLE:-











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- ALL THE DESIGN IS FOR (G-3) FLOORS ONLY.
- CLEAR COVER TO MAIN REINFORCEMENT SHALL BE FOR COLUMN - 40MM, PLINTH BEAM - 30MM.
- FOOTING-50mm, BEAM-25mm, SLAB - 20mm .
- THE MIX FOR ALL R.C.C. WORK SHALL BE M-20 (1:1.5:3).
- ALL THE REINFORCEMENT SHALL BE Fe-500(HSD BARS).
- MINIMUM DEVELOPMENT LENGTH FOR TOR STEEL SHALL BE 50d, WHERE "d" IS DIAMETER OF MAIN REINFORCEMENT.
- THE LAP SHALL BE STAGGERED AND AVOIDED AT THE POINT OF MAXIMUM BENDING MOMENT .
- ALL DIMENSION & LEVEL ARE IN FEET-INCH.

SIGNATURE :-

DRAWN:- AR. DHANESHWARI

DESIGN:- ER. PABITRA

PROJECT TITLE:-

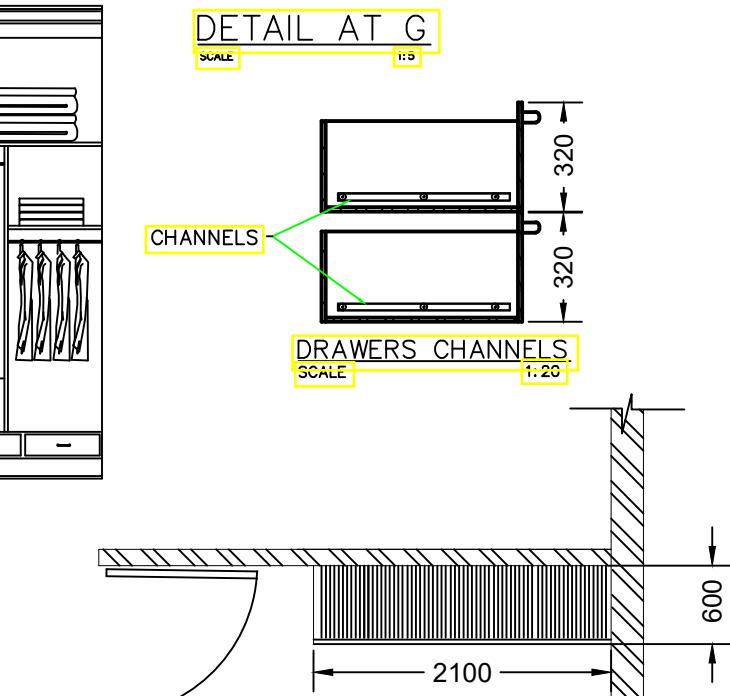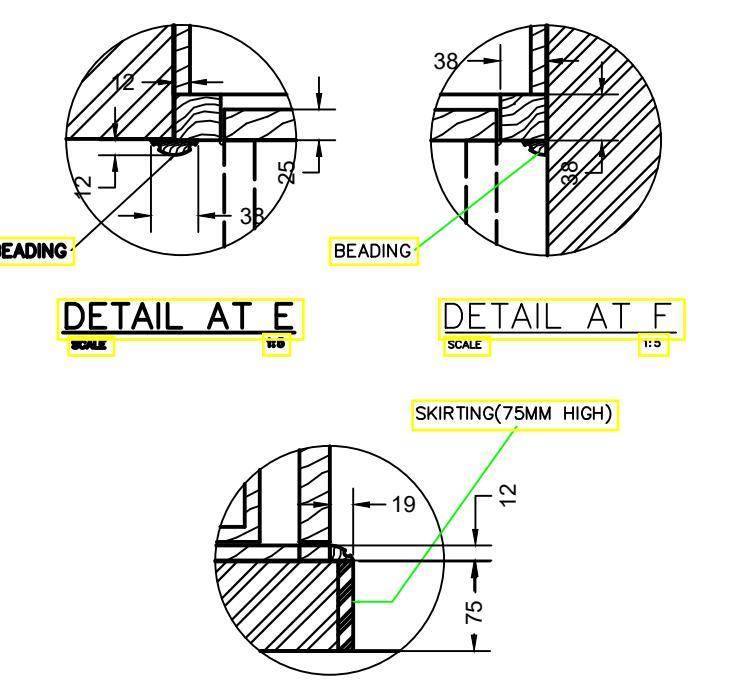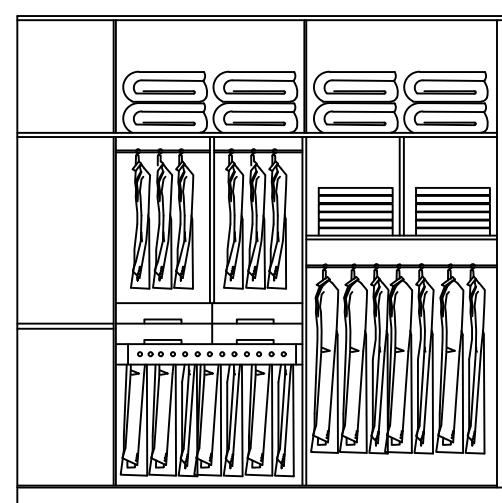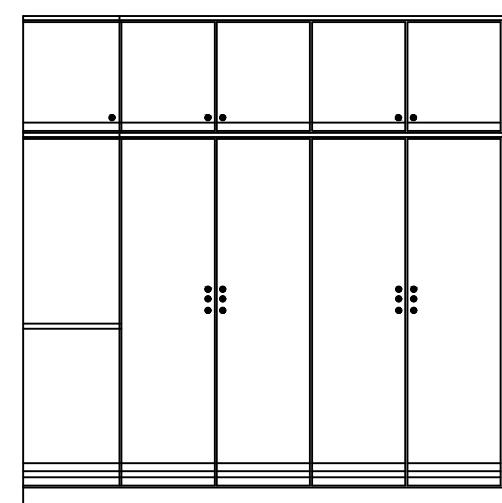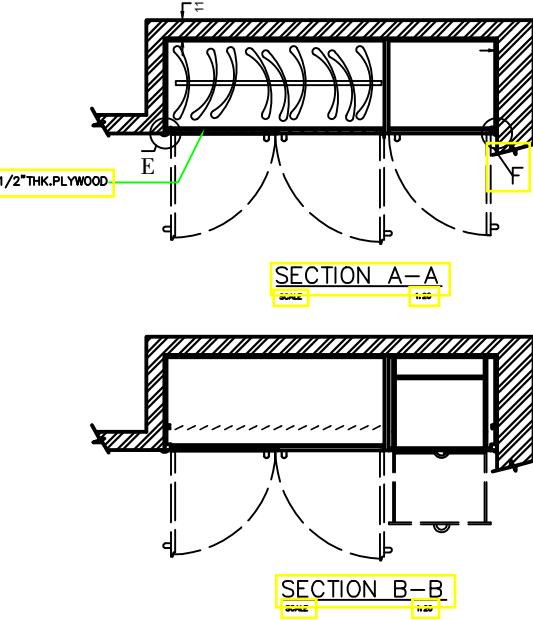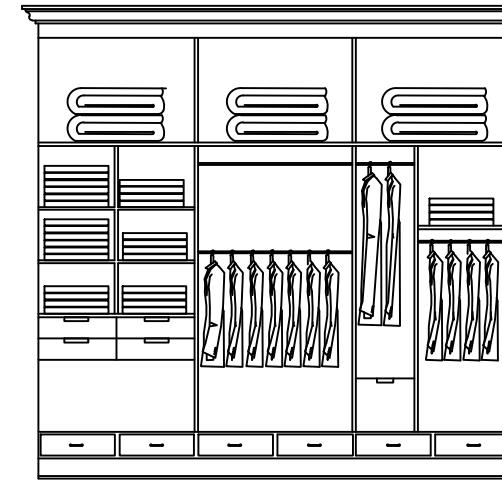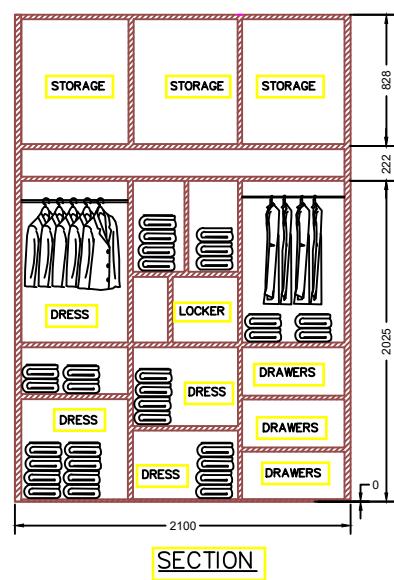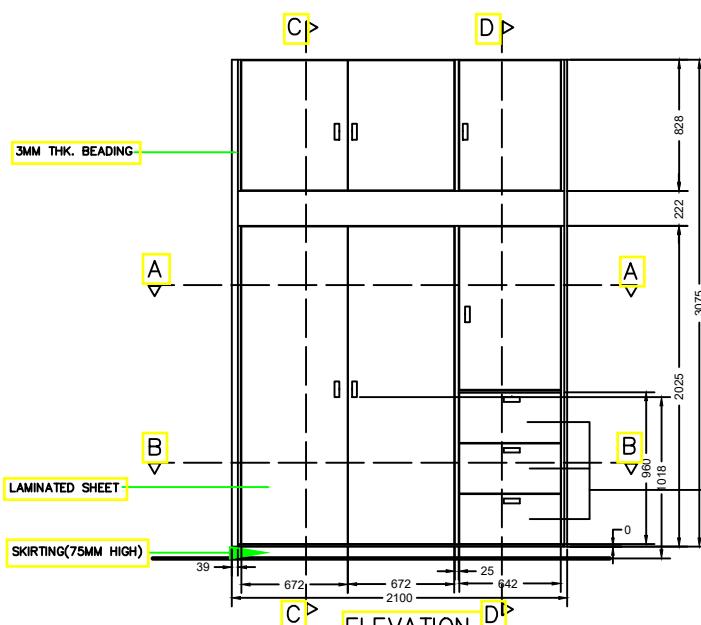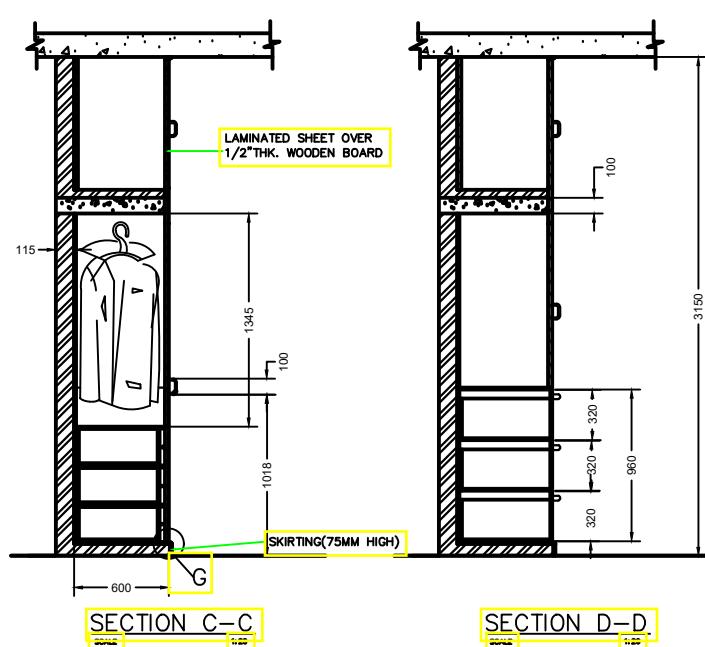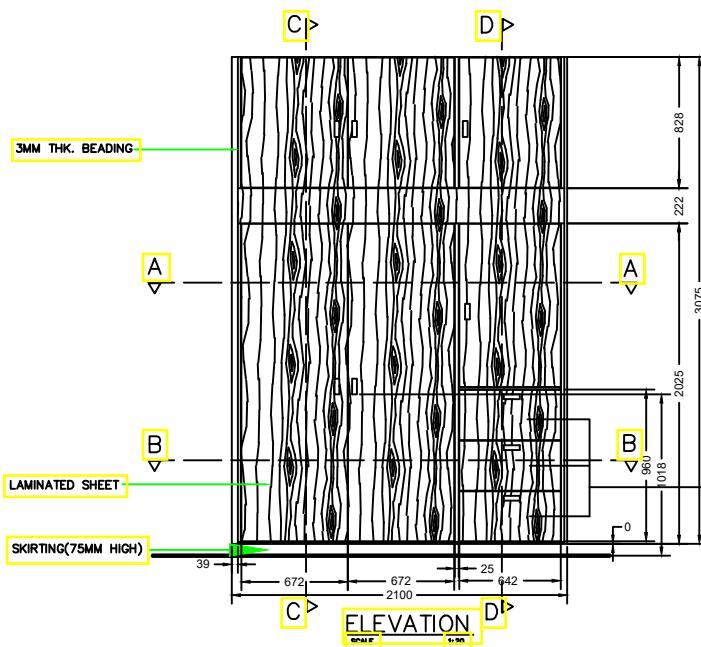K.I.P SOUMYA

STATUS:

ISSUED FOR CONSTRUCTION

DATE: 04-05-2022

SCALE NTS

DWG NO:



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DETAILLING DRAWING




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ELEVATION - A-A'



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SIGNATURE :-

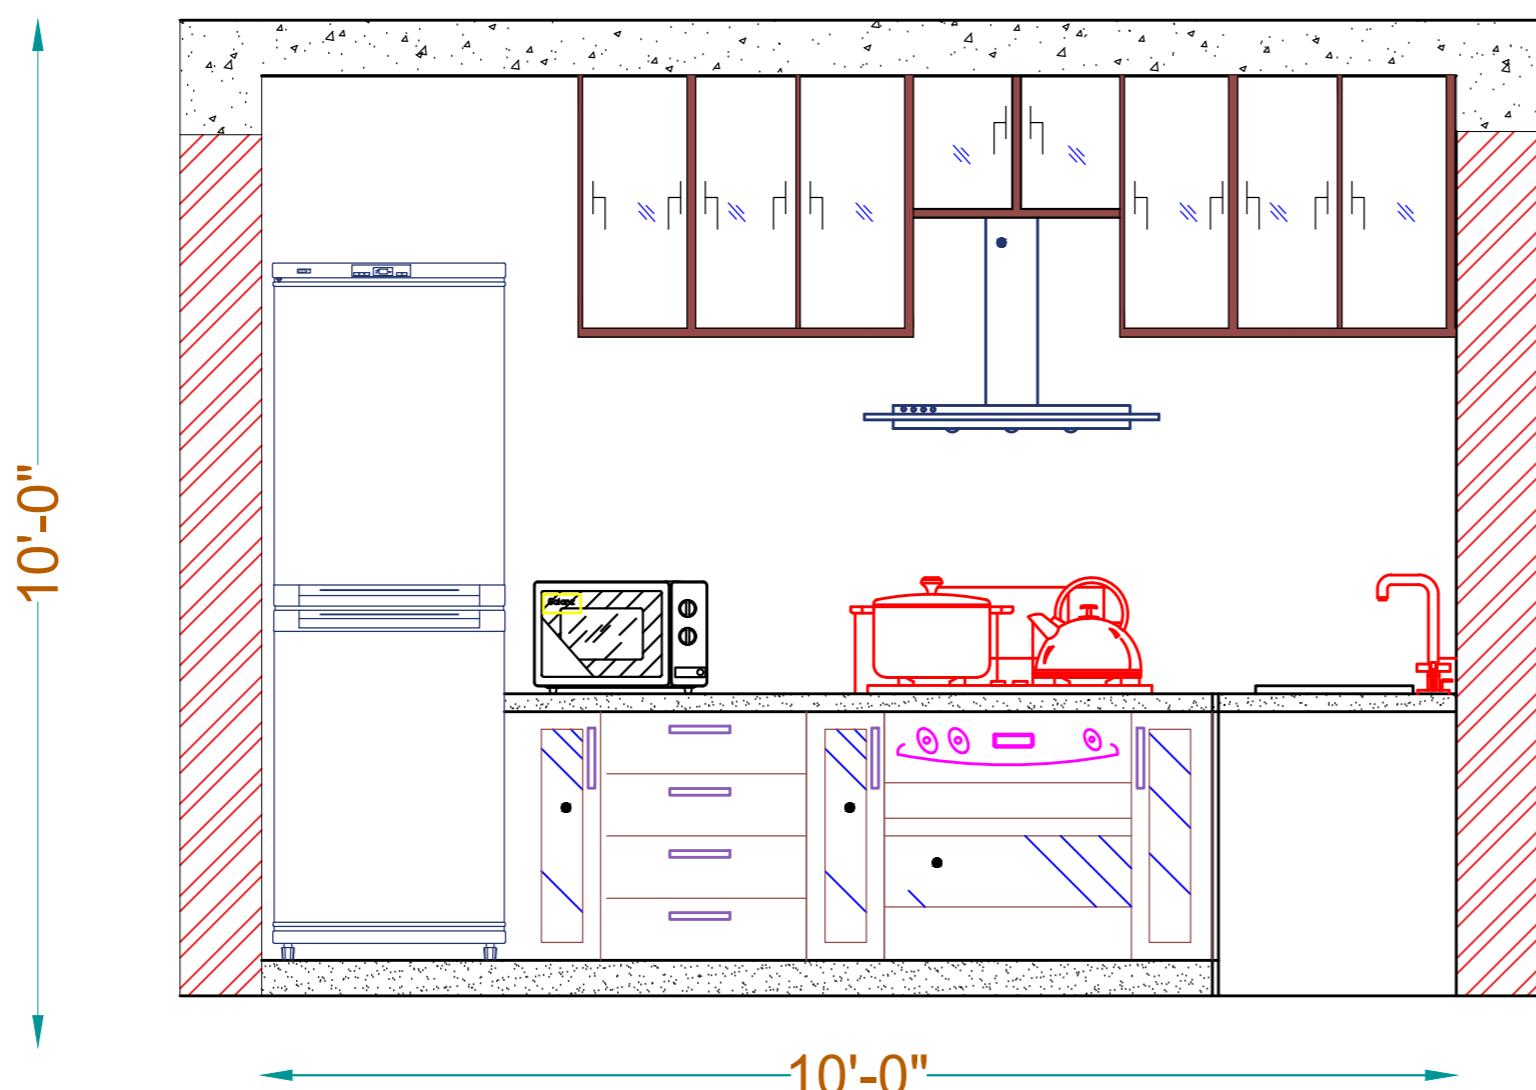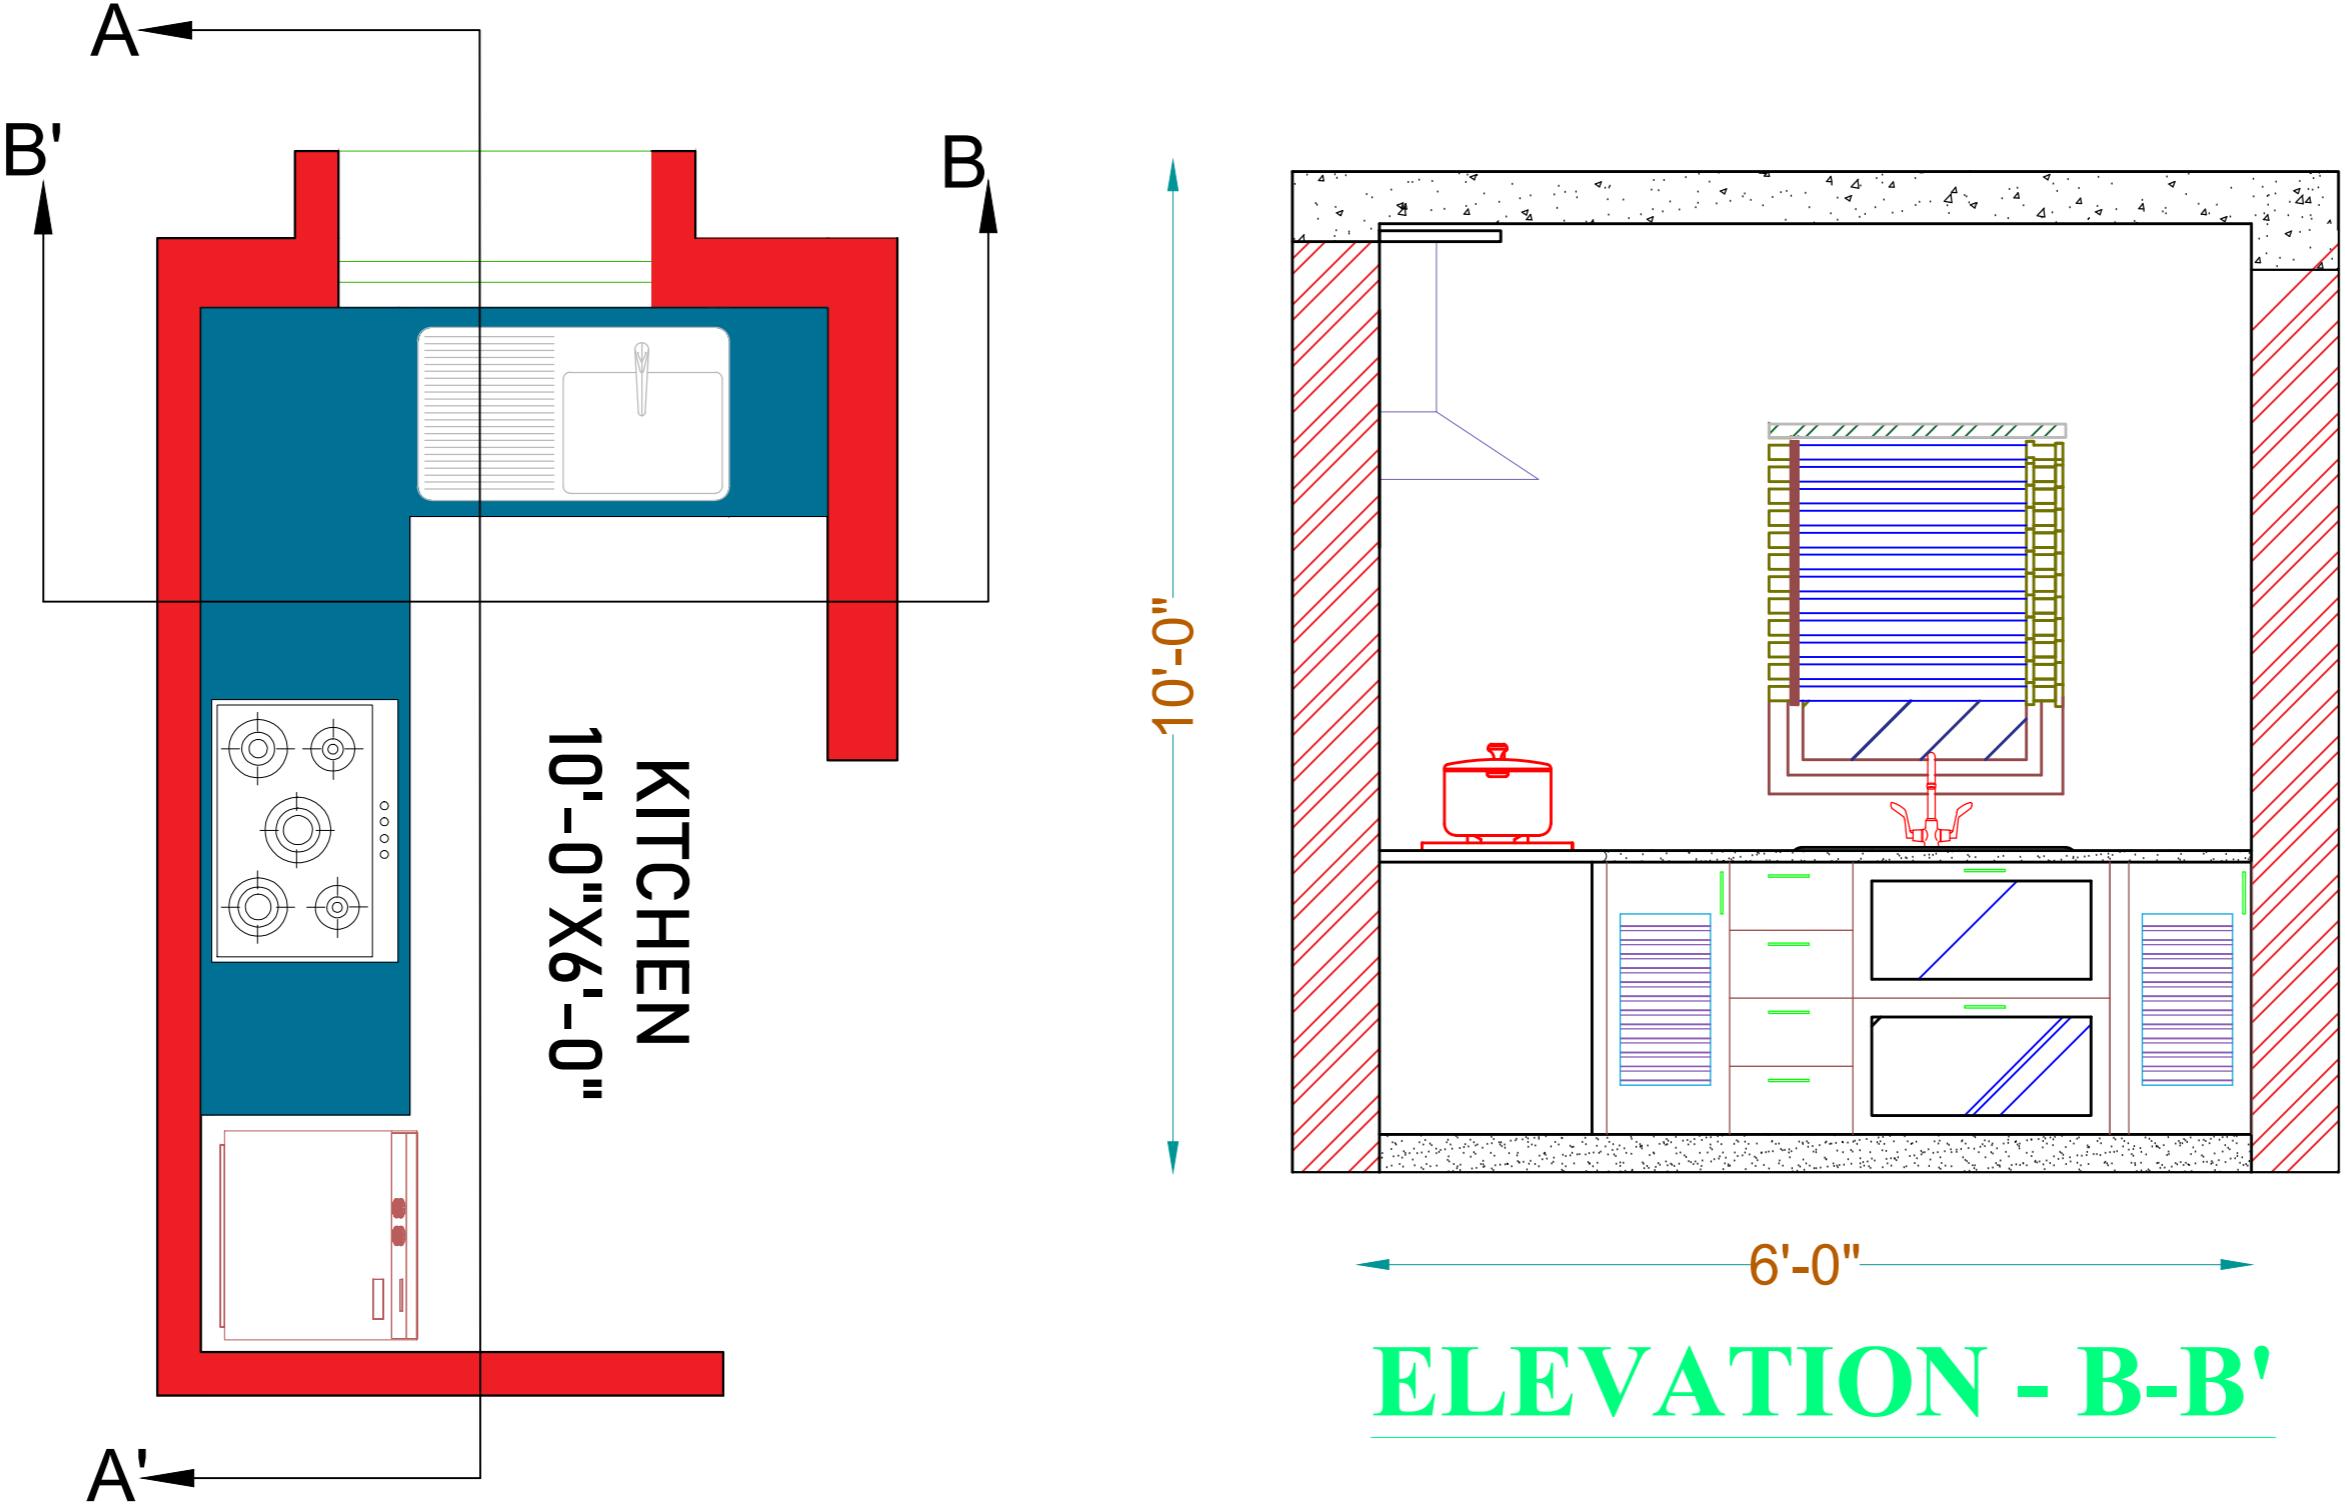DRAWN:- AR. DHANESHWARI

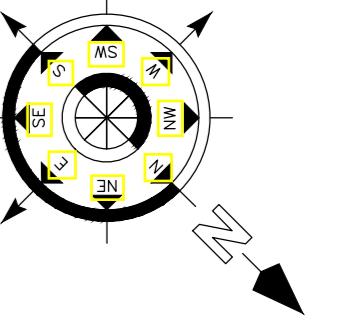DESIGN:- ER. PABITRA

PROJECT TITLE:-

K.I.P SOUMYA

STATUS:

ISSUED FOR CONSTRUCTION

DATE:	04-05-2022
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SCALE	NTS
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DWG NO:	31
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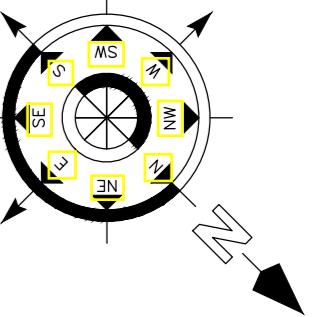
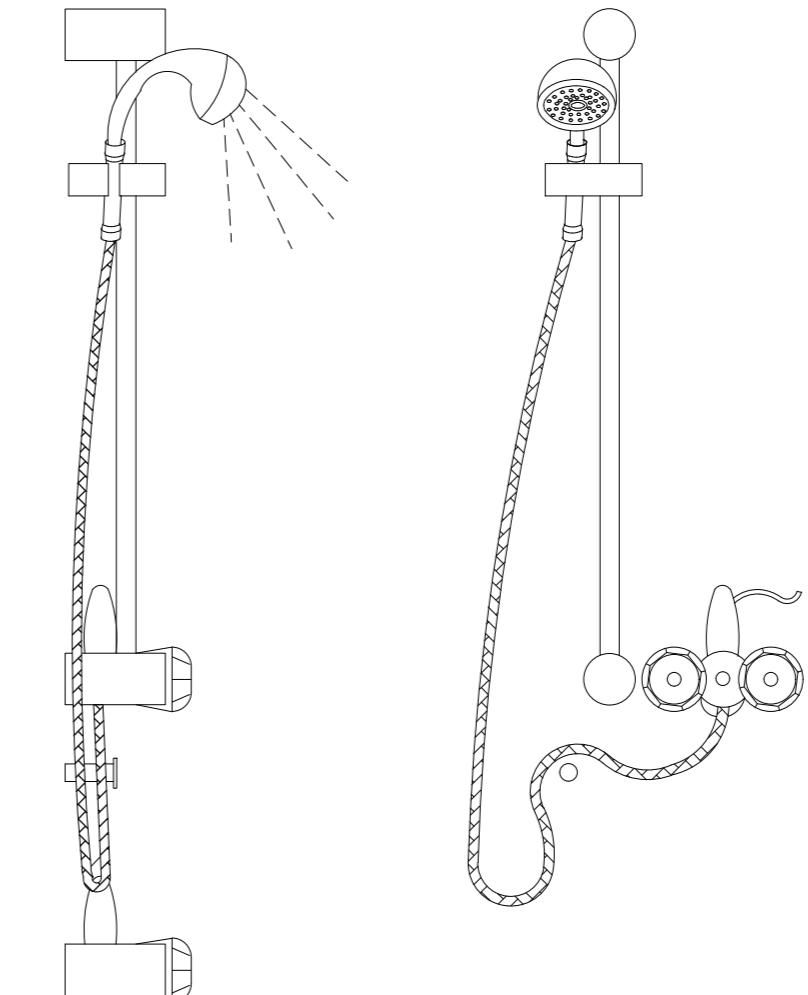
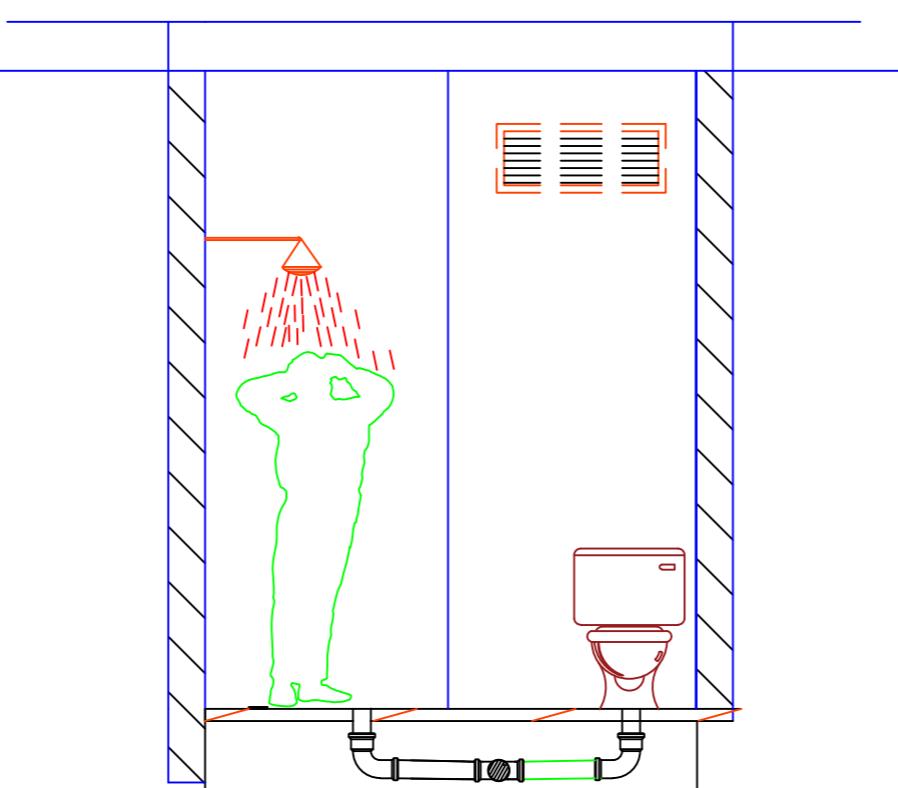
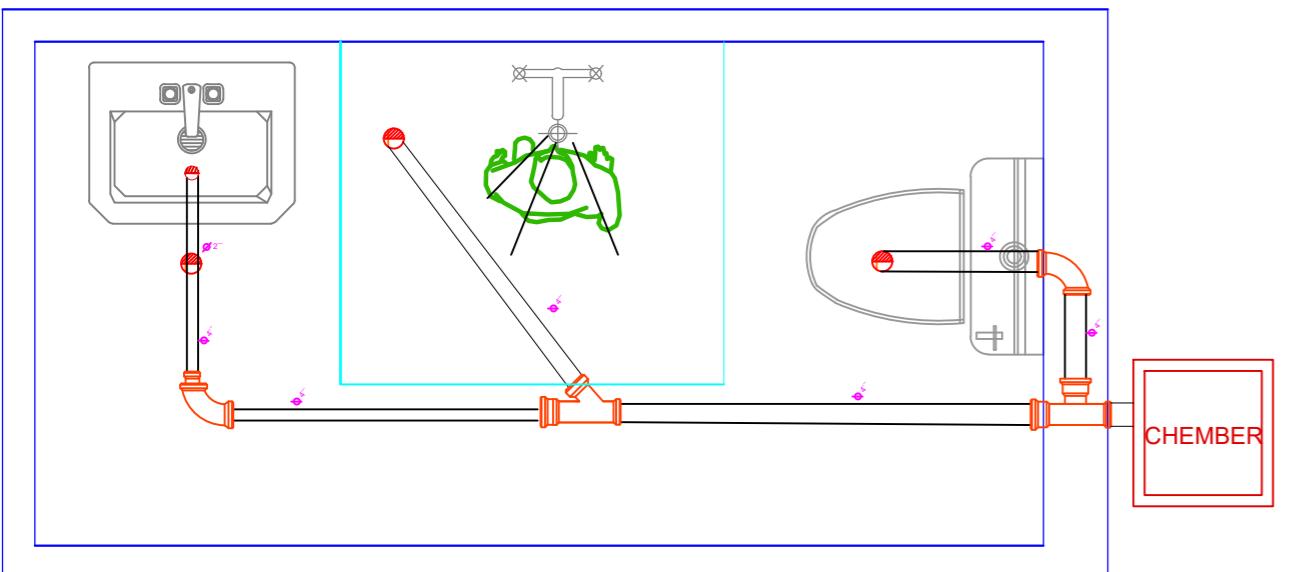
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KITCHEN LAYOUT
DRAWING



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- ALL DIMENSION & LEVEL ARE IN FEET-INCH.

SIGNATURE :-

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DESIGN:- ER. PABITRA

PROJECT TITLE:-

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DATE: 04-05-2022

SCALE NTS

DWG NO: 32







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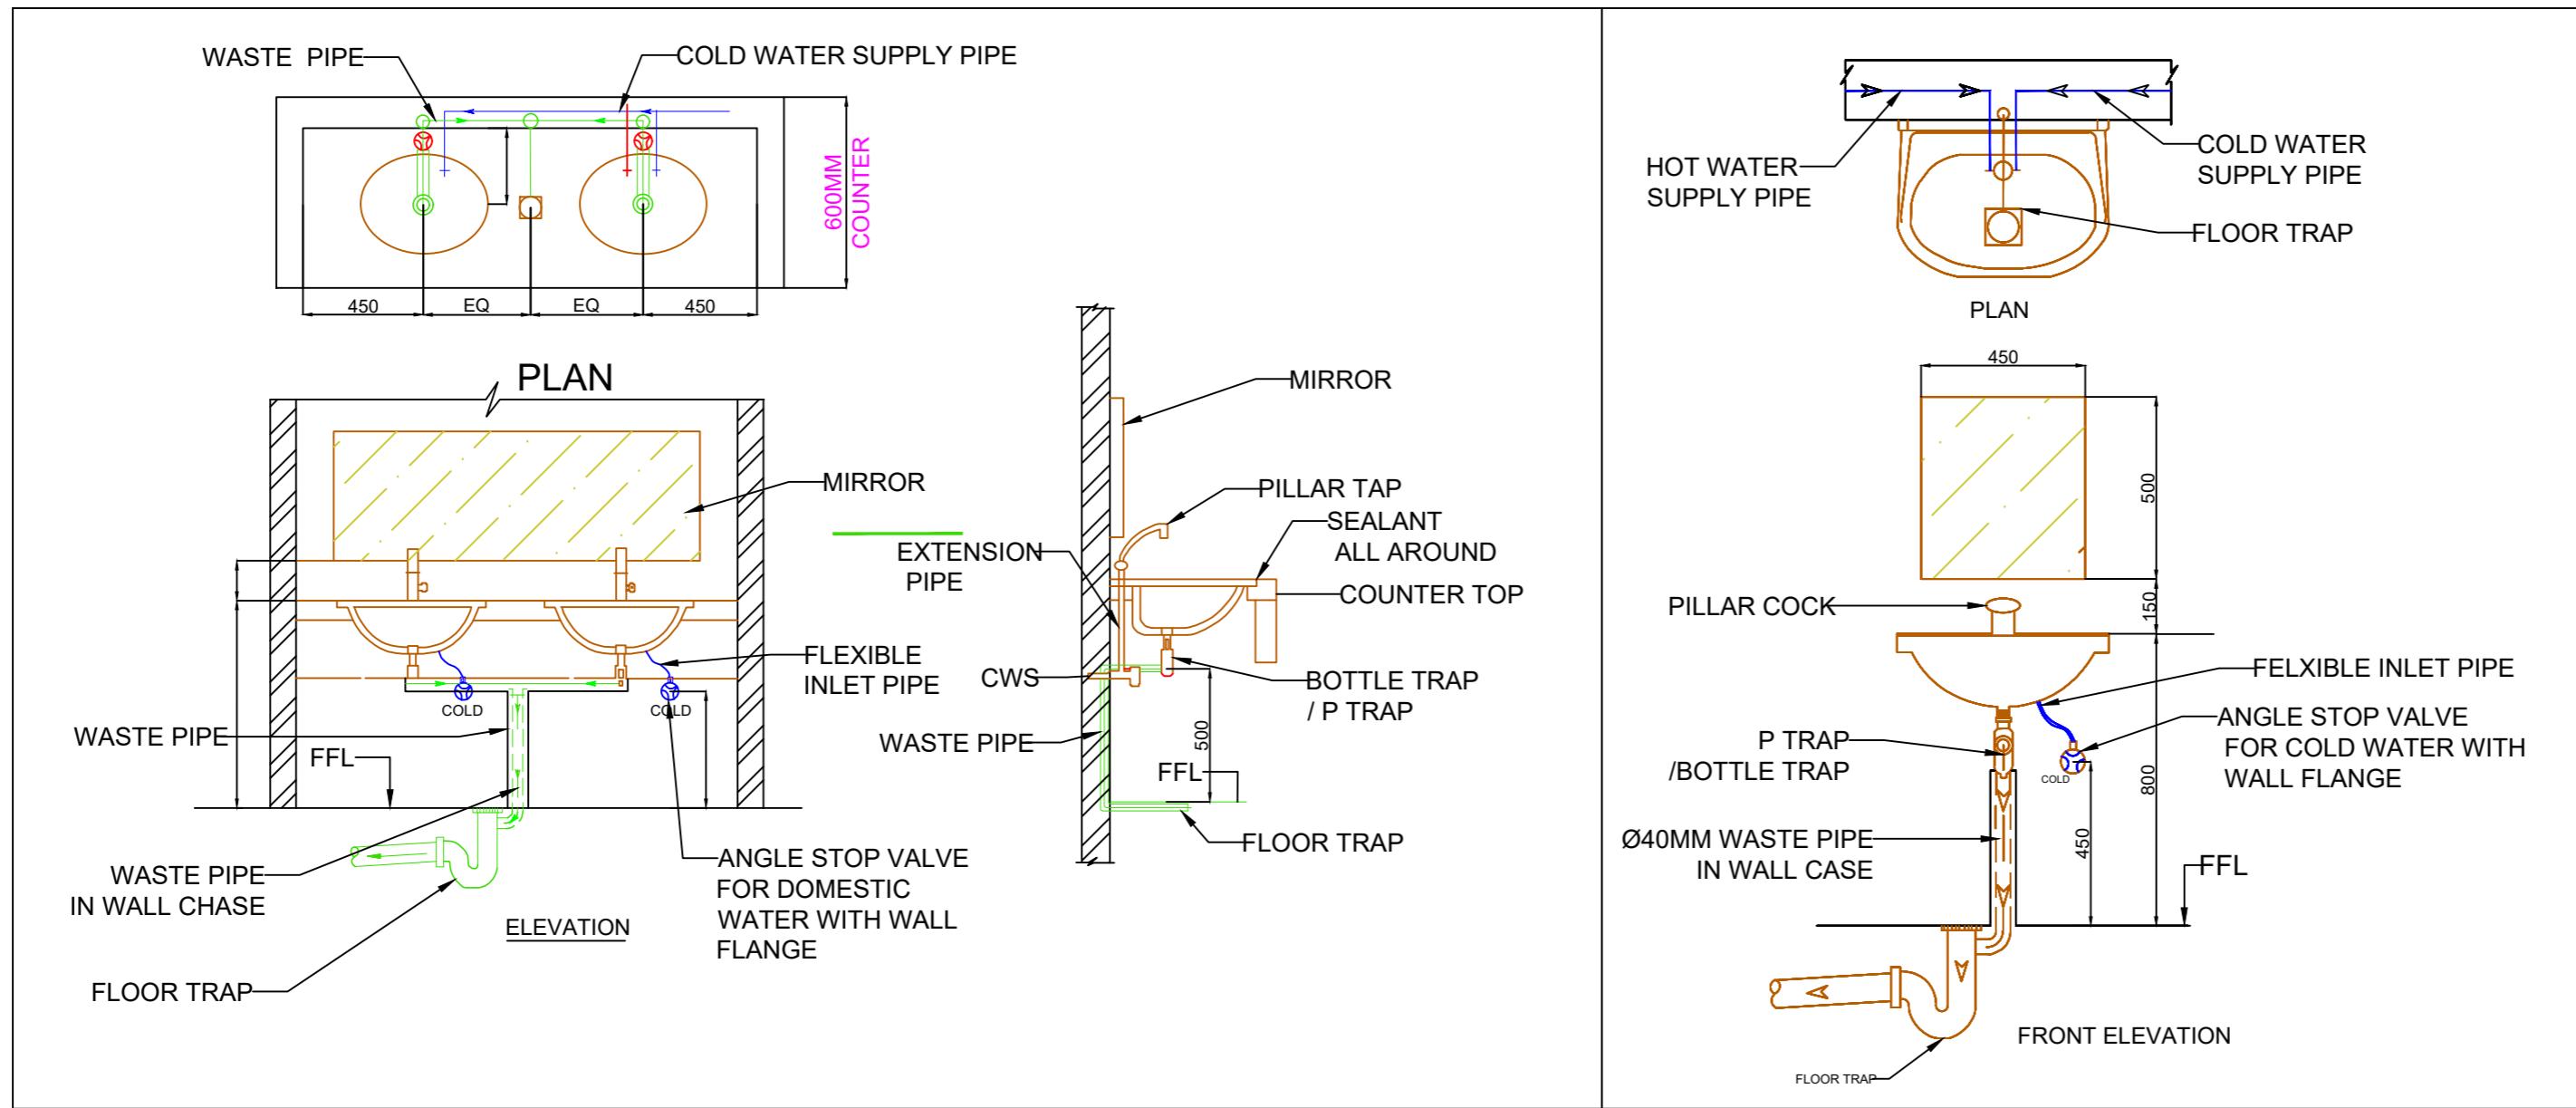
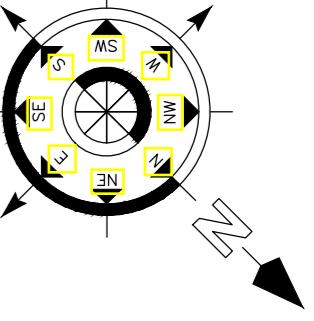

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TOILET LAY OUT & DETAIL



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- FOOTING-50mm, BEAM-25mm, SLAB - 20mm.
- THE MIX FOR ALL R.C.C. WORK SHALL BE M-20 (1:1.5:3).
- ALL THE REINFORCEMENT SHALL BE F-500(HYD BARS).
- MINIMUM DEVELOPMENT LENGTH FOR TOR STEEL SHALL BE 50d, WHERE "d" IS DIA OF MAIN REINFORCEMENT.
- THE LAP SHALL BE STAGGERED AND AVOIDED AT THE POINT OF MAXIMUM BENDING MOMENT.
- ALL DIMENSION & LEVEL ARE IN FEET-INCH.

SIGNATURE :-

DRAWN:- AR. DHANESHWARI

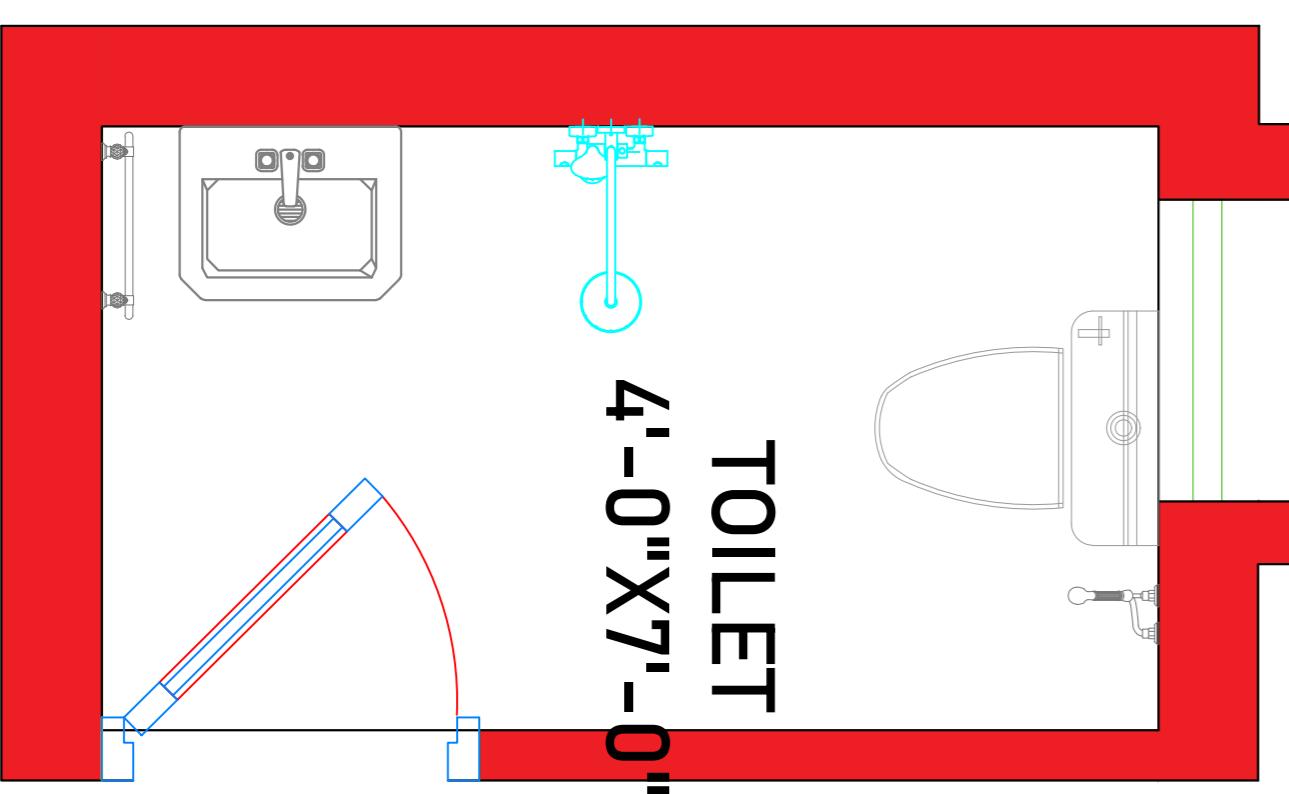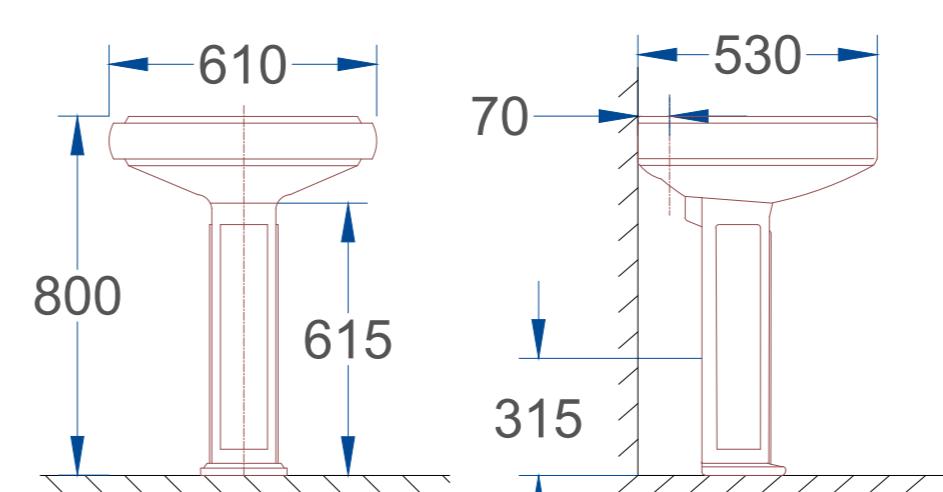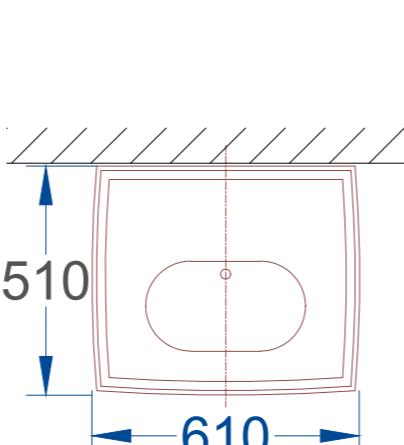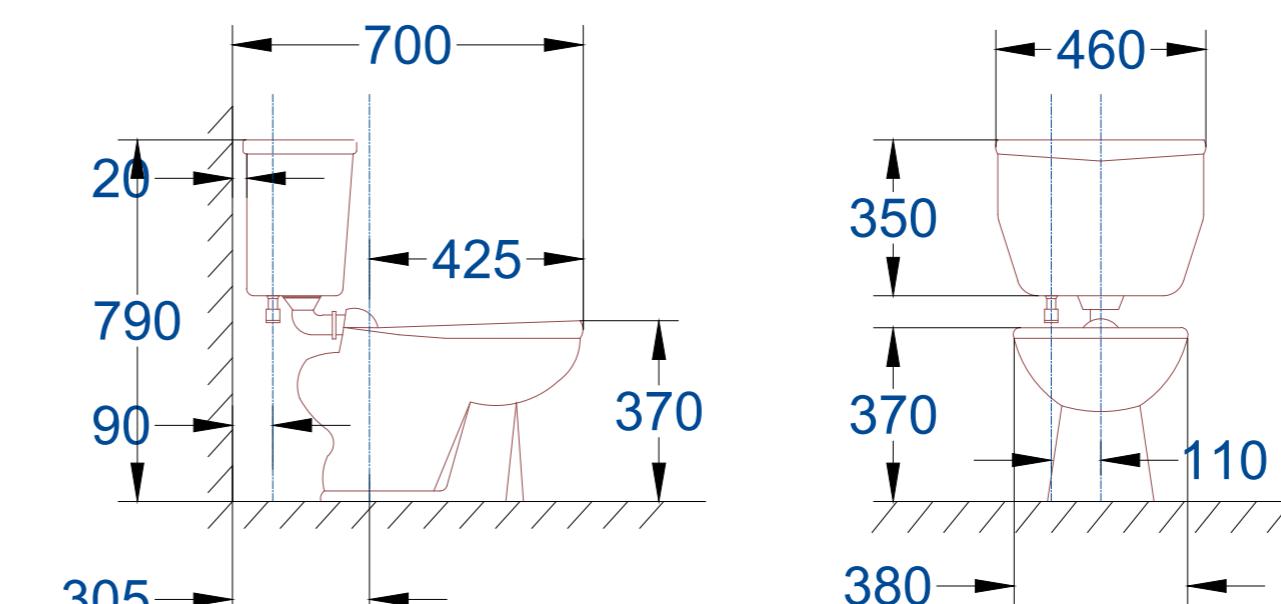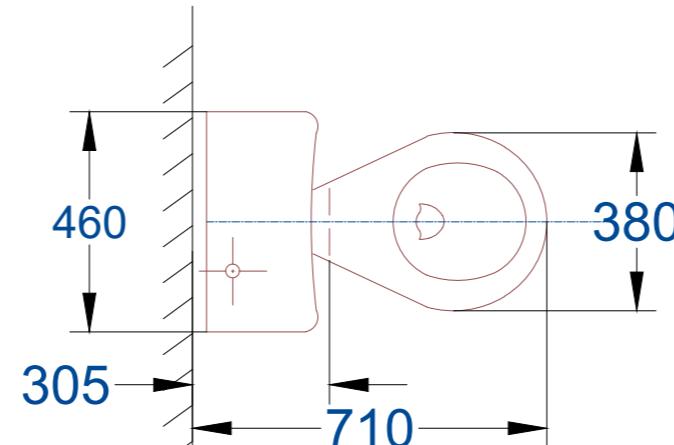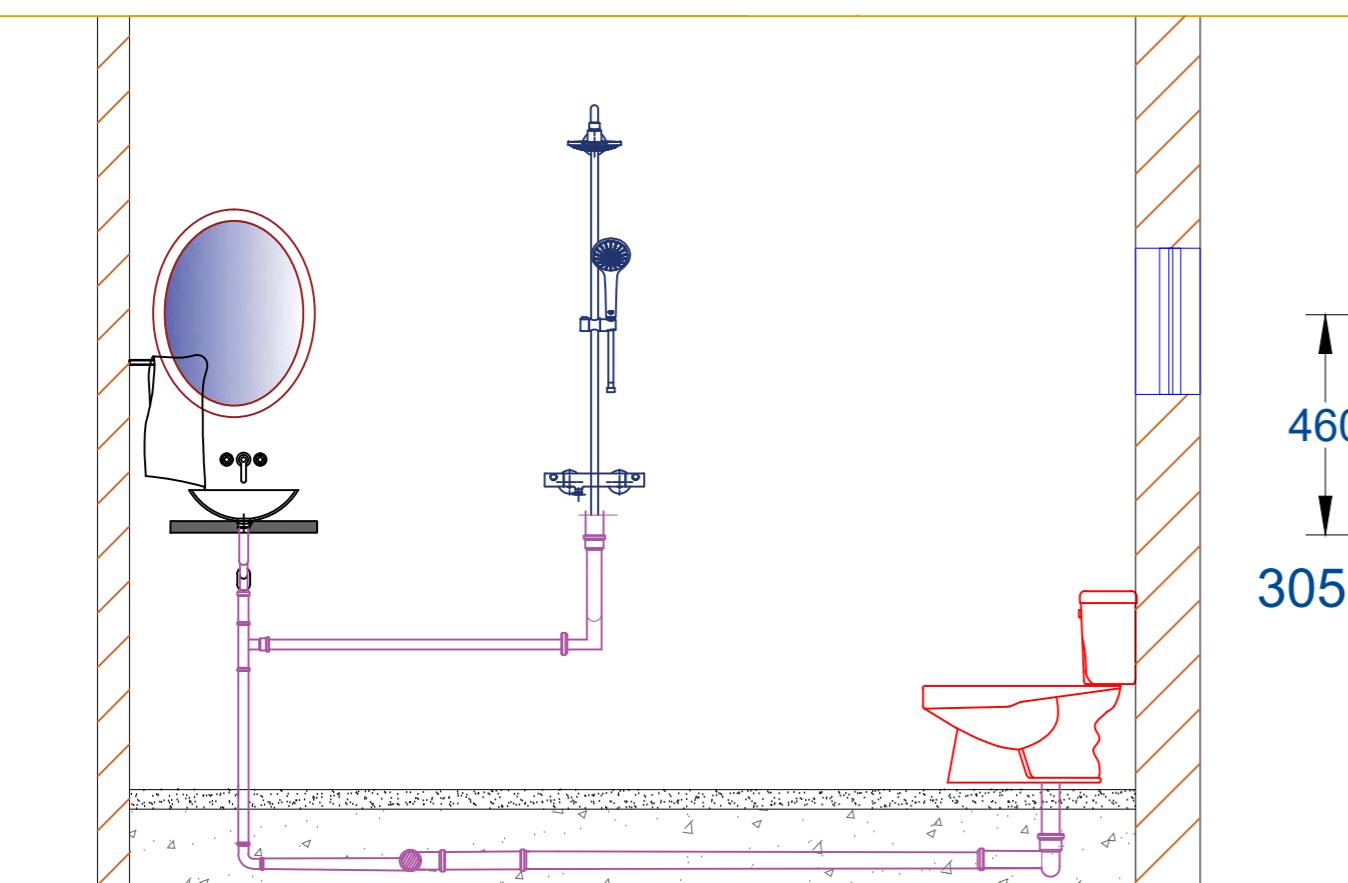DESIGN:- ER. PABITRA

PROJECT TITLE:-

K.I.P SOUMYA

STATUS:

ISSUED FOR CONSTRUCTION

DATE: 04-05-2022

SCALE NTS

DWG NO: 33

DRAWING TITLE:-


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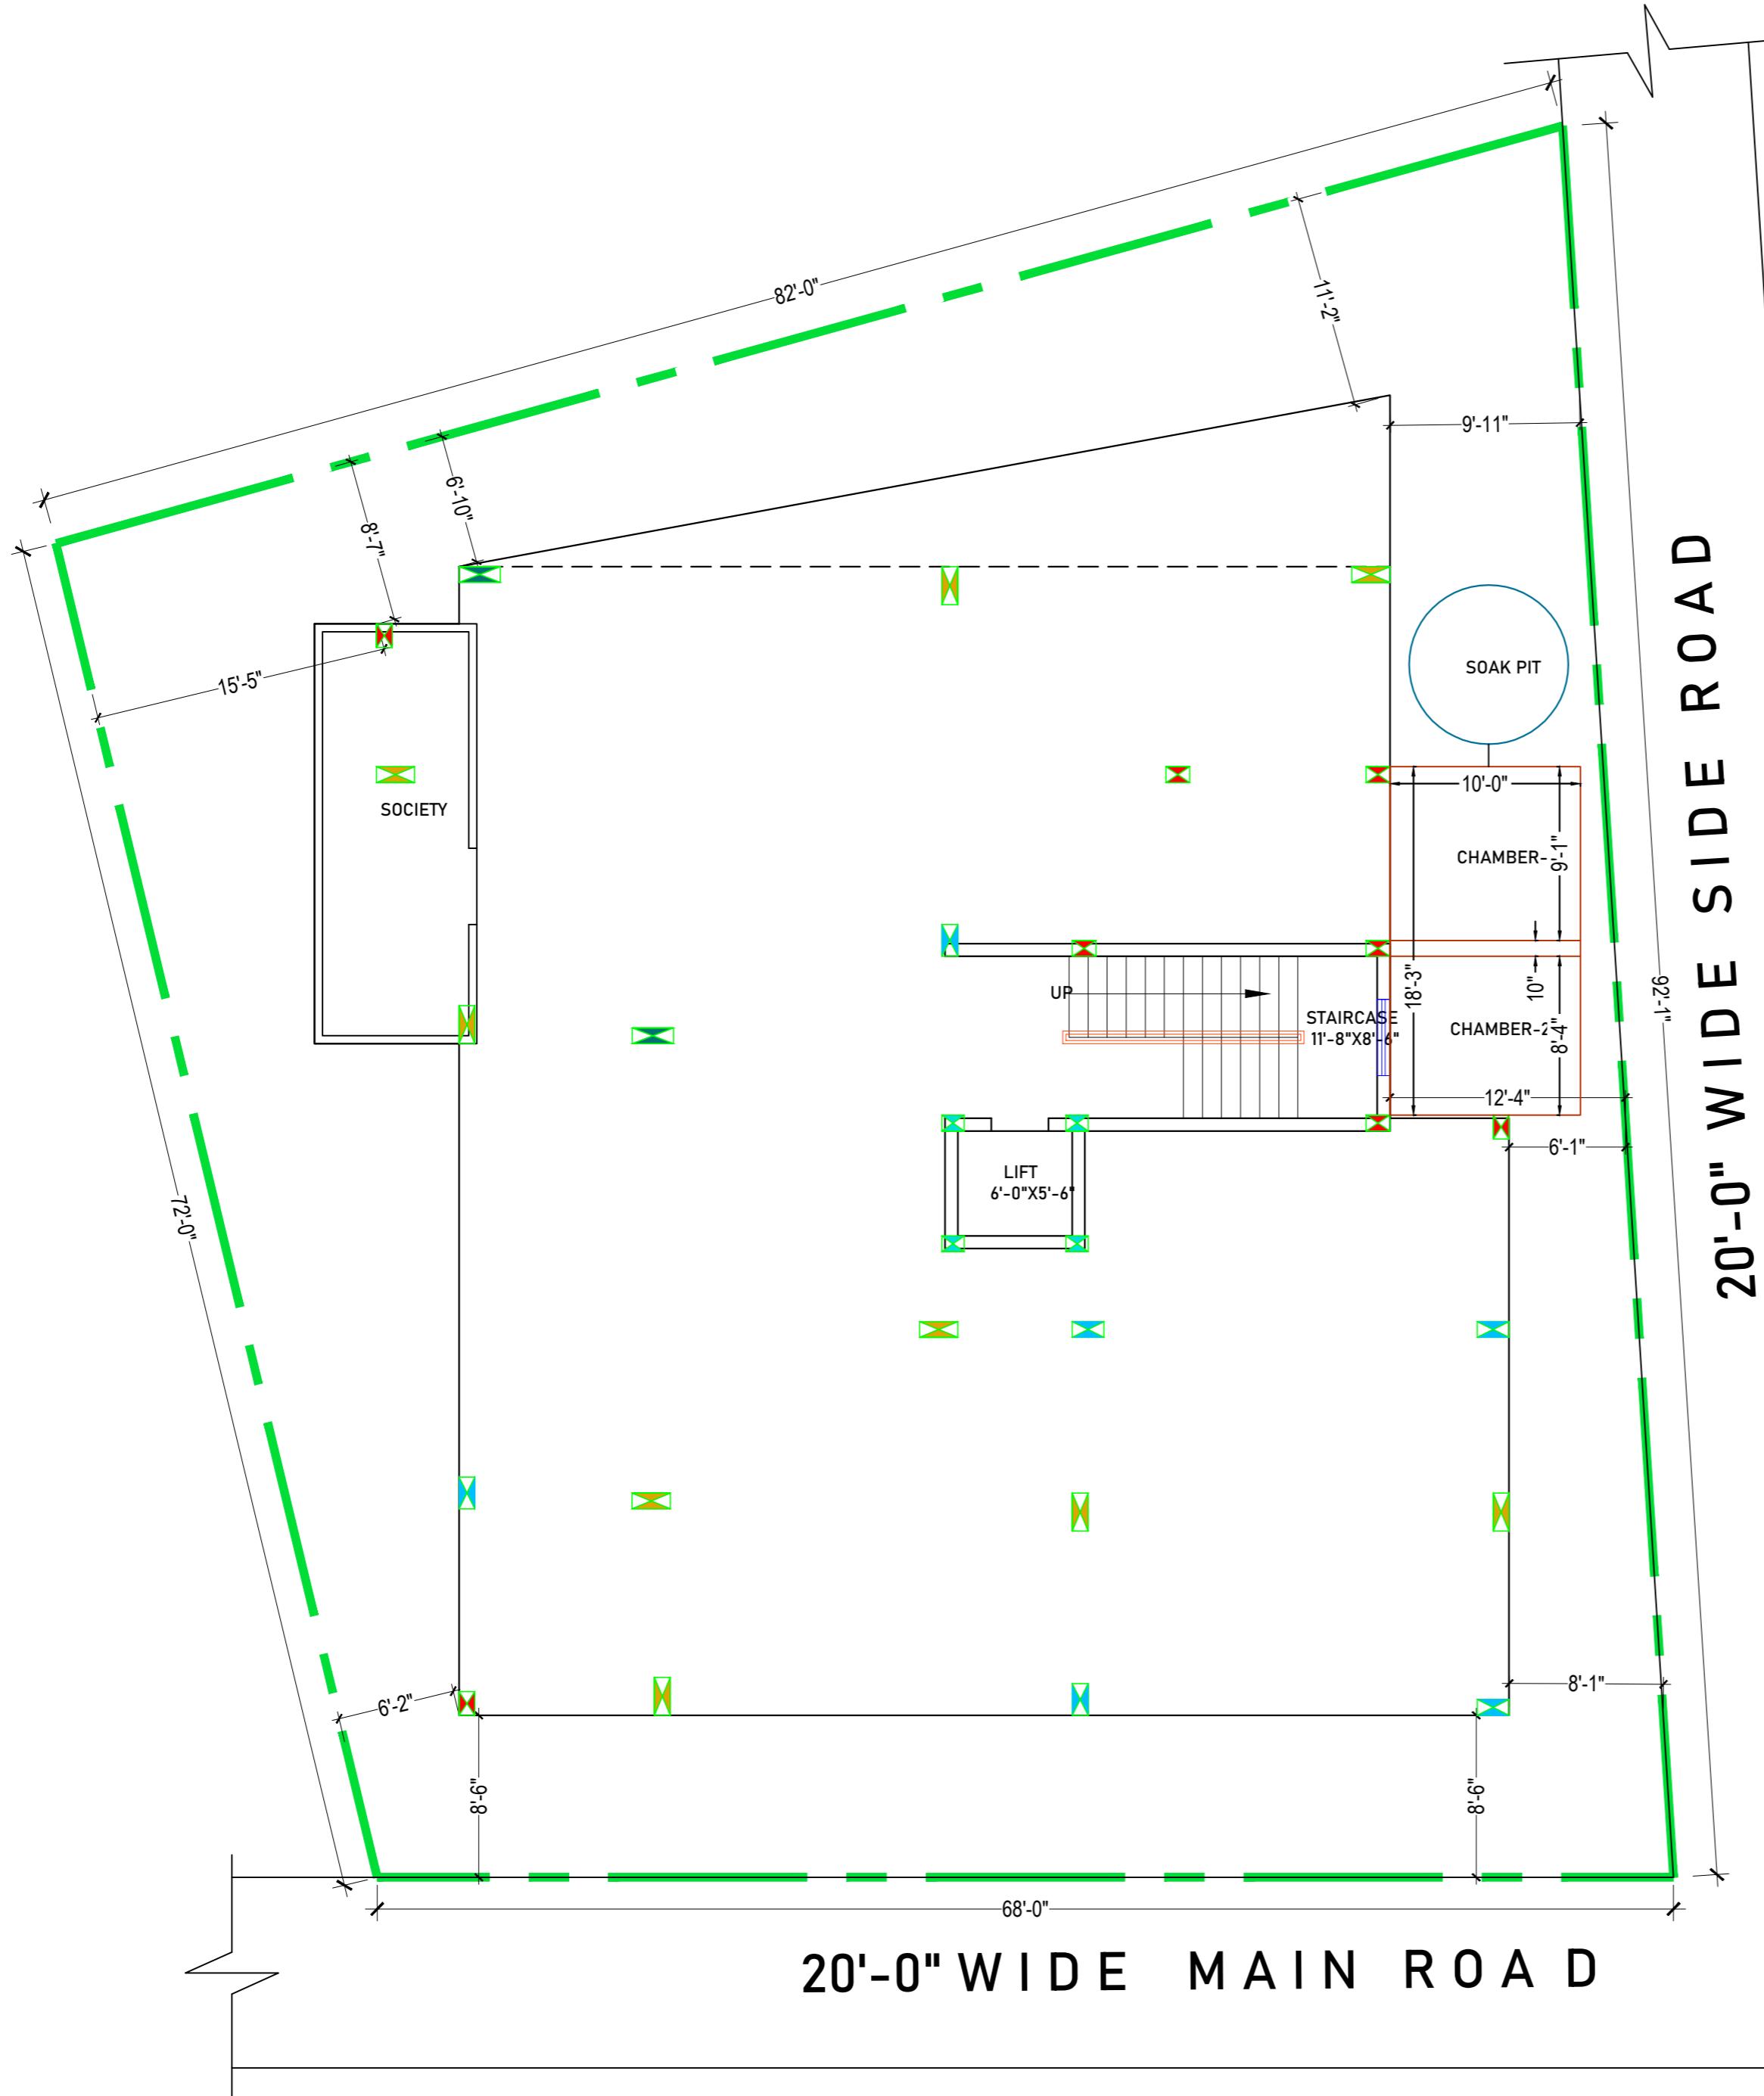


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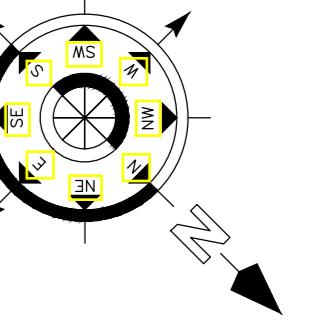
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STILT FLOOR PLAN



Note:

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 - ANY DISCREPANCY IN THE DRAWING SHOULD BE BROUGHT TO THE KNOWLEDGE OF CONSULTANT BEFORE EXECUTION.
 - LOAD HAS BEEN TAKEN FOR (G+2) FLOORS ONLY.
 - CLEAR COVER TO MAIN REINFORCEMENT SHALL BE FOR COLUMN - 40MM, PLINTH BEAM - 50MM
 - FOOTING-50mm, BEAM-25mm, SLAB - 20mm .
 - THE MIX FOR ALL R.C.C. WORK SHALL BE M-20 (1:1.5:3).
 - ALL THE REINFORCEMENT SHALL BE Fe-500(HYSID BARS)
 - MINIMUM DEVELOPMENT LENGTH FOR TOR STEEL SHALL BE 50d, WHERE "d" IS DIA OF MAIN REINFORCEMENT.
 - THE LAP SHALL BE STAGGERED AND AVOIDED AT THE POINT OF MAXIMUM BENDING MOMENT .
 - ALL DIMENSION & LEVEL ARE IN FEET-INCH.

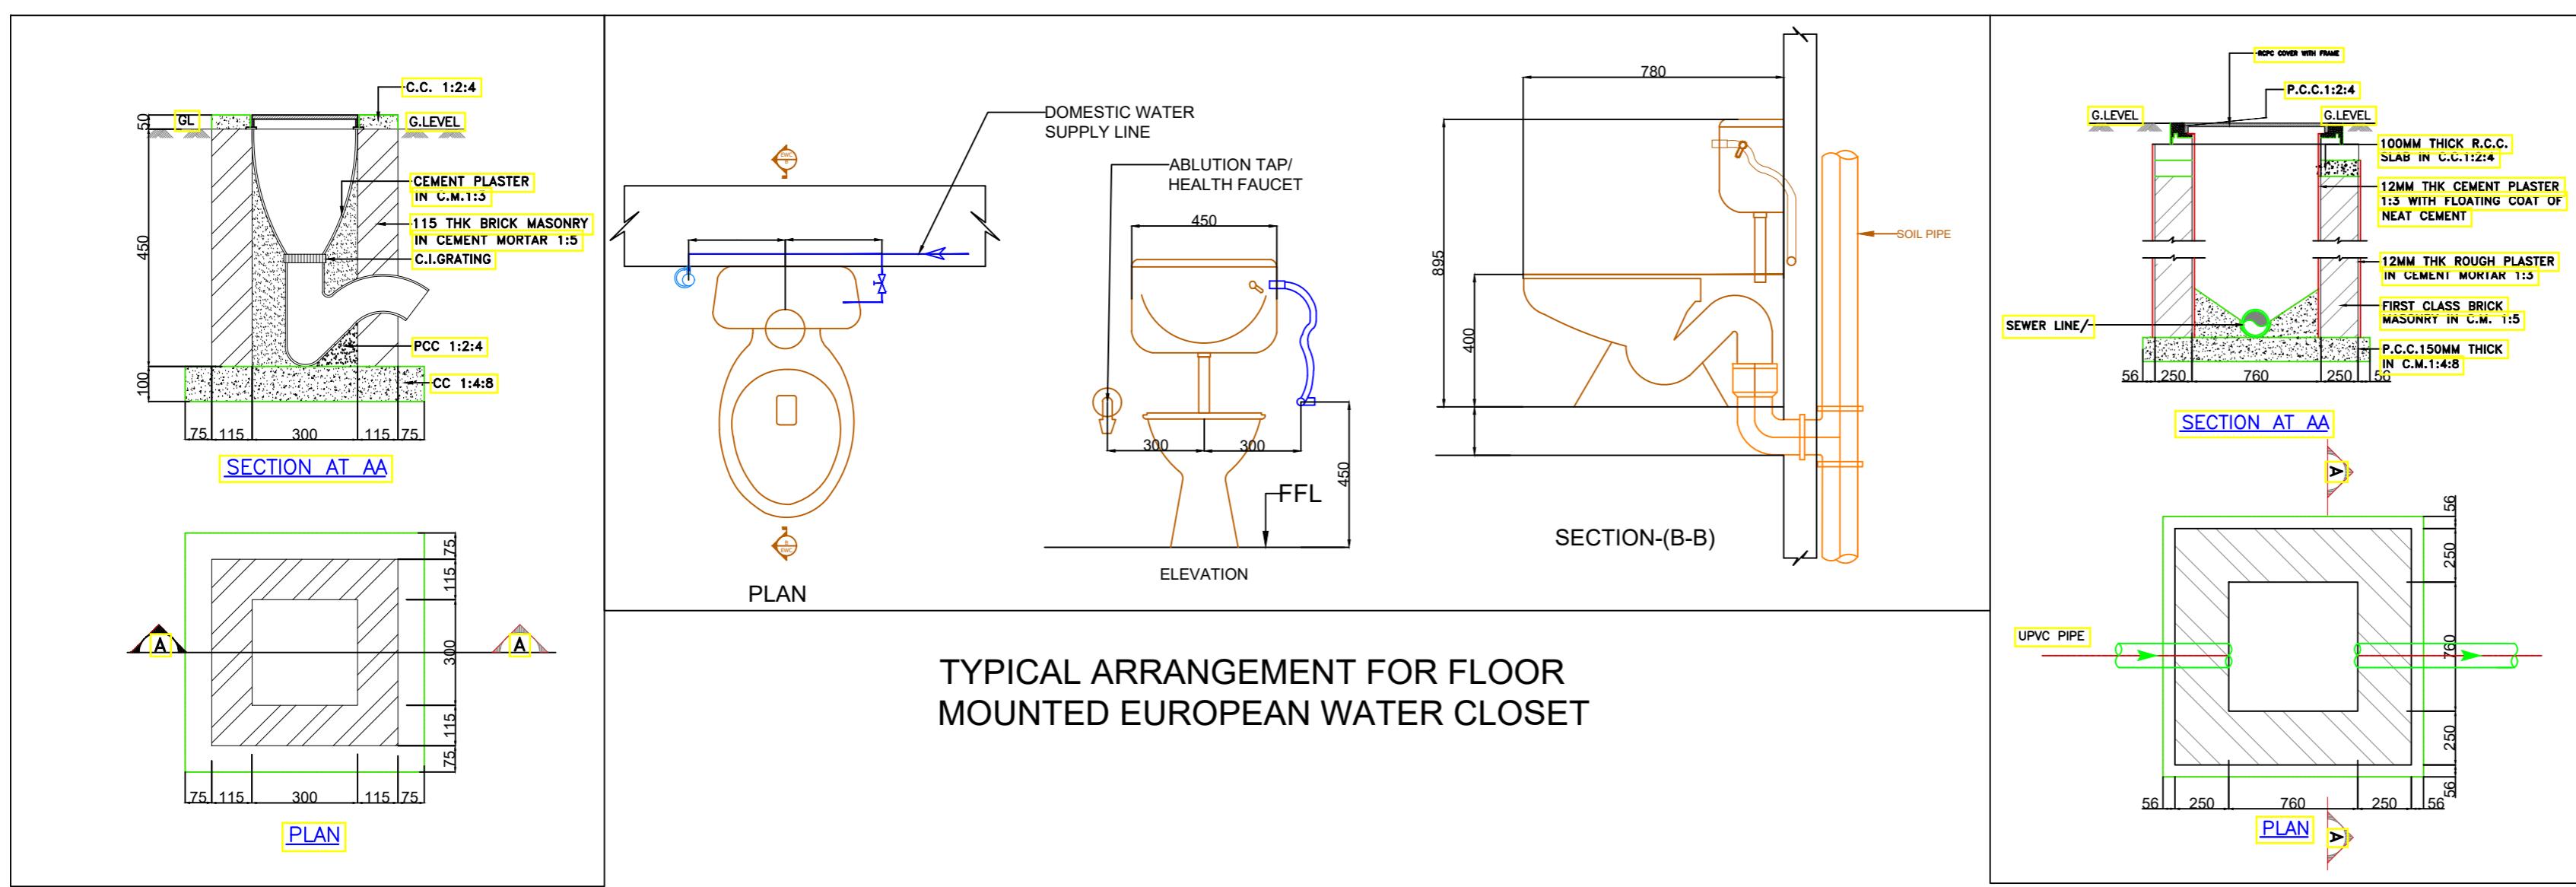SIGNATURE :-

DRAWN:-	AR. DHANESHWARI
DESIGN:-	ER. PABITRA

PROJECT TITLE:-

K.I.P SOUMYA

STATUS:

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DATE:	04-05-2022
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DWG NO:	34

DRAWING TITLE:-

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NOTES FOR UNDER GROUND CLARIFIED WATER TANK:

- (i) Yield strength of re-bars f_y shall be 500 MPa min.
- (ii) Concrete strength f'_c (28 day 12"x24" cylinder strength) shall be 30MPa min. with a minimum mix ratio 1:1.5:3 .
- (iii) Coarse aggregate shall be $\frac{3}{4}$ " down well graded hard stone chips.
- (iv) Fine aggregate shall be a mixture of 85% coarse sand of F.M. 2.3 min. and 15% medium sand of F.M. 1.3 min.
- (v) Binders shall be $\varnothing 10 @ 12"$ c/c where required.
- (vi) All dimensions are in IMPERIAL

NOTE :-

CONCRETE MIX = M30 GRADE
CONCRETE, f'_c = MINIMUM 3000 psi
YIELD STRENGTH OF STEEL f_y = 550 GRADE



CLEAR COVER

- i) WATER FACE = 2.0"
- ii) EARTH FACE = 2.0"

USE WATER PROOFING ADMIXTURE IN BOTTOM SLAB & WALL OF UNDER GROUND WATER RESERVOIR.

SEPTIC TANK	LENGTH	WIDTH	HEIGHT
	18'-3	10'-0"	8'-0"

Sr No:	TANK DESCRIPTION	TANK SIZE(MM)		
		L	W	H
1)	SOAK PIT	3300	3300	2400

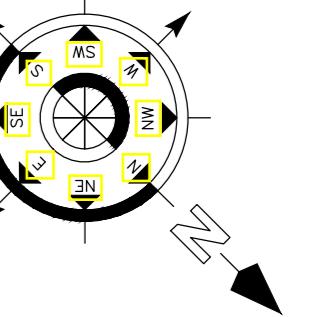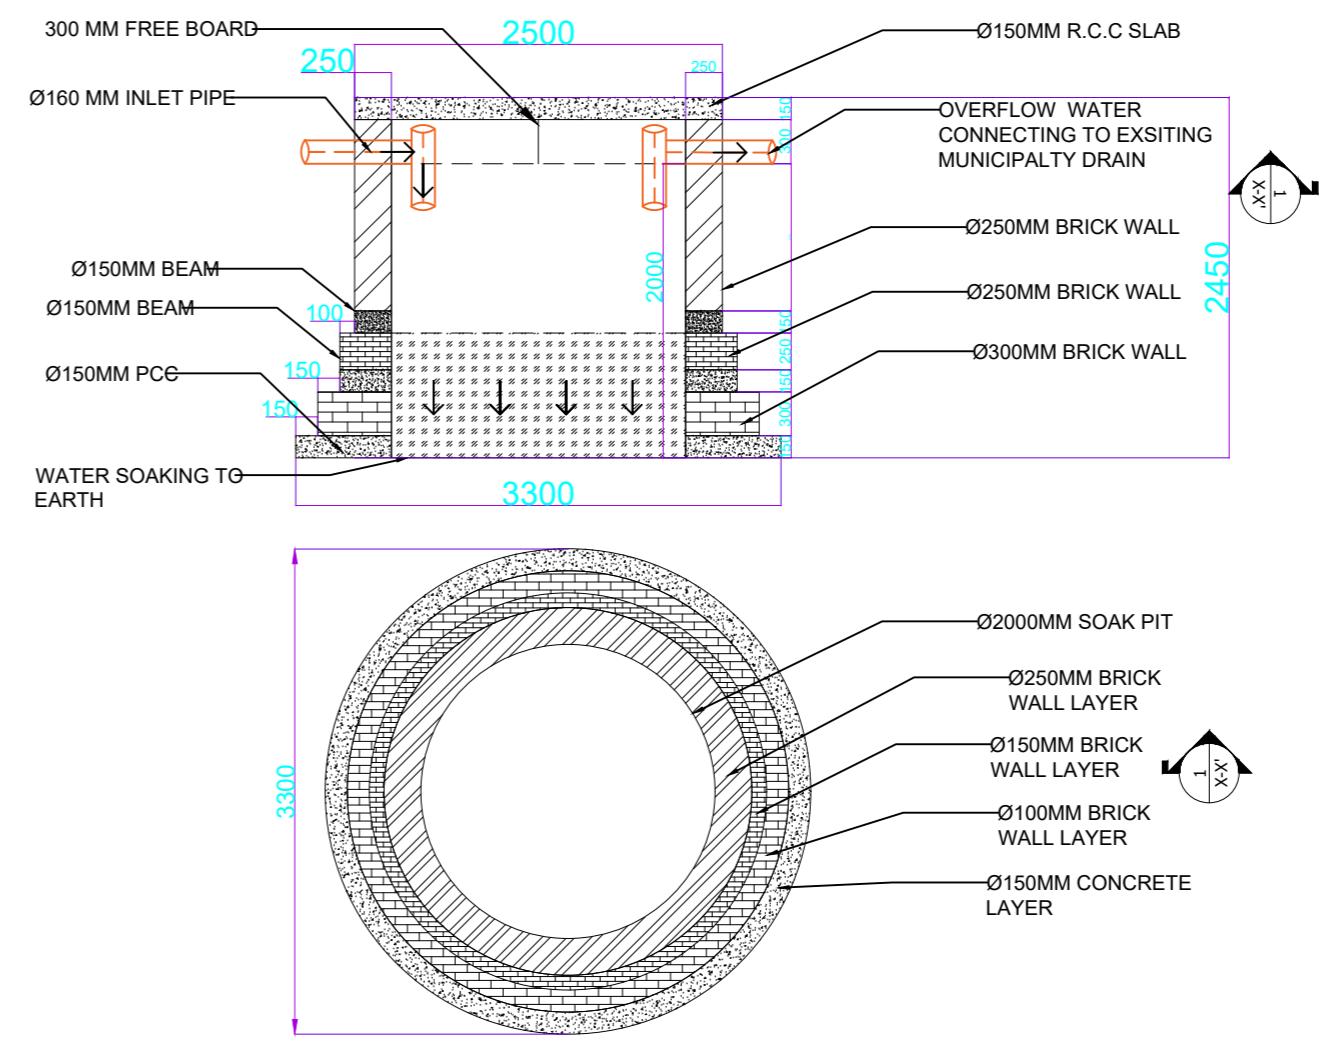

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- ALL THE REINFORCEMENT SHALL BE F=500(HYD BARS).
- MINIMUM DEVELOPMENT LENGTH FOR TOR STEEL SHALL BE 50d, WHERE "d" IS DIA OF MAIN REINFORCEMENT.
- THE LAP SHALL BE STAGGERED AND AVOIDED AT THE POINT OF MAXIMUM BENDING MOMENT .
- ALL DIMENSION & LEVEL ARE IN FEET-INCH.

SIGNATURE :-

DRAWN:- AR. DHANESHWARI

DESIGN:- ER. PABITRA

PROJECT TITLE:-

K.I.P SOUMYA

STATUS:

ISSUED FOR CONSTRUCTION

DATE: 04-05-2022

SCALE NTS

DWG NO: 35

DRAWING TITLE:-


S.T.P.TANK



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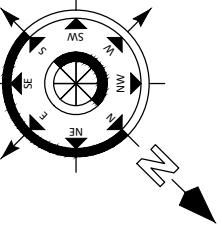
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LEGEND OF ELECTRICAL FITTINGS	
SL.	SPECIFICATION
01	1400mm Sweep Ceiling Fan
02	
03	20W Led Tube Light
04	20W Led Tube Light Surface Mounted (UPS)
05	380mm Sweep Exhaust Fan
06	TV Point
07	5Amps Switch + Plug Socket Outlet Only On Independent Board
08	15Amps Switch + Plug Socket Outlet Only On Independent Board
09	ELECTRICAL PANEL
10	Branch Distribution Board Light
11	Branch Distribution Board Power
12	Branch Distribution Board Power (UPS)
13	32A Industrial Switch
14	32A Industrial Socket
15	18 watt LED Circular
16	Ceiling Rose
17	Split AC Indoor Unit
18	AC Outdoor Unit
19	Geyser Point
20	Telephone Point
21	Switch Board With UPS Supply
22	15 watt CFL Bulb (Wall Mounted)
23	Switch Board
24	Mirror Light
25	Aquaguard Water Purifier
26	Fridge
27	Calling Bell Switch
28	Calling Bell
29	Bullet Camera (Outdoor Camera)
30	Dome Camera (Indoor Camera)
31	20W Led Tube Light Ceiling Mounted
32	Electric Vehicle Charging Point
33	FTTH
34	Water Sensor Panel
35	Pump Panel
36	Inspection Chamber for Internet Cable
38	16 amps IP 67 Socket & Switch
39	Switch Board with UPS Powered
40	TV Antenna (MDU)
41	Dressing Unit
42	Foot Light
43	Shoe Polishing Machine
44	Sanitizer Machine
45	Solar Inverter
46	Lead Acid Battery
47	Weather Proof Outdoor light/ Facade Light
48	Junction Box
49	Switch Board with two way Switch
50	UPS power switch Board with two way switch

LEGEND	DESCRIPTION
○	WALL SIDE BELOW THE BEAM
○	WALL CENTRE BELOW THE BEAM

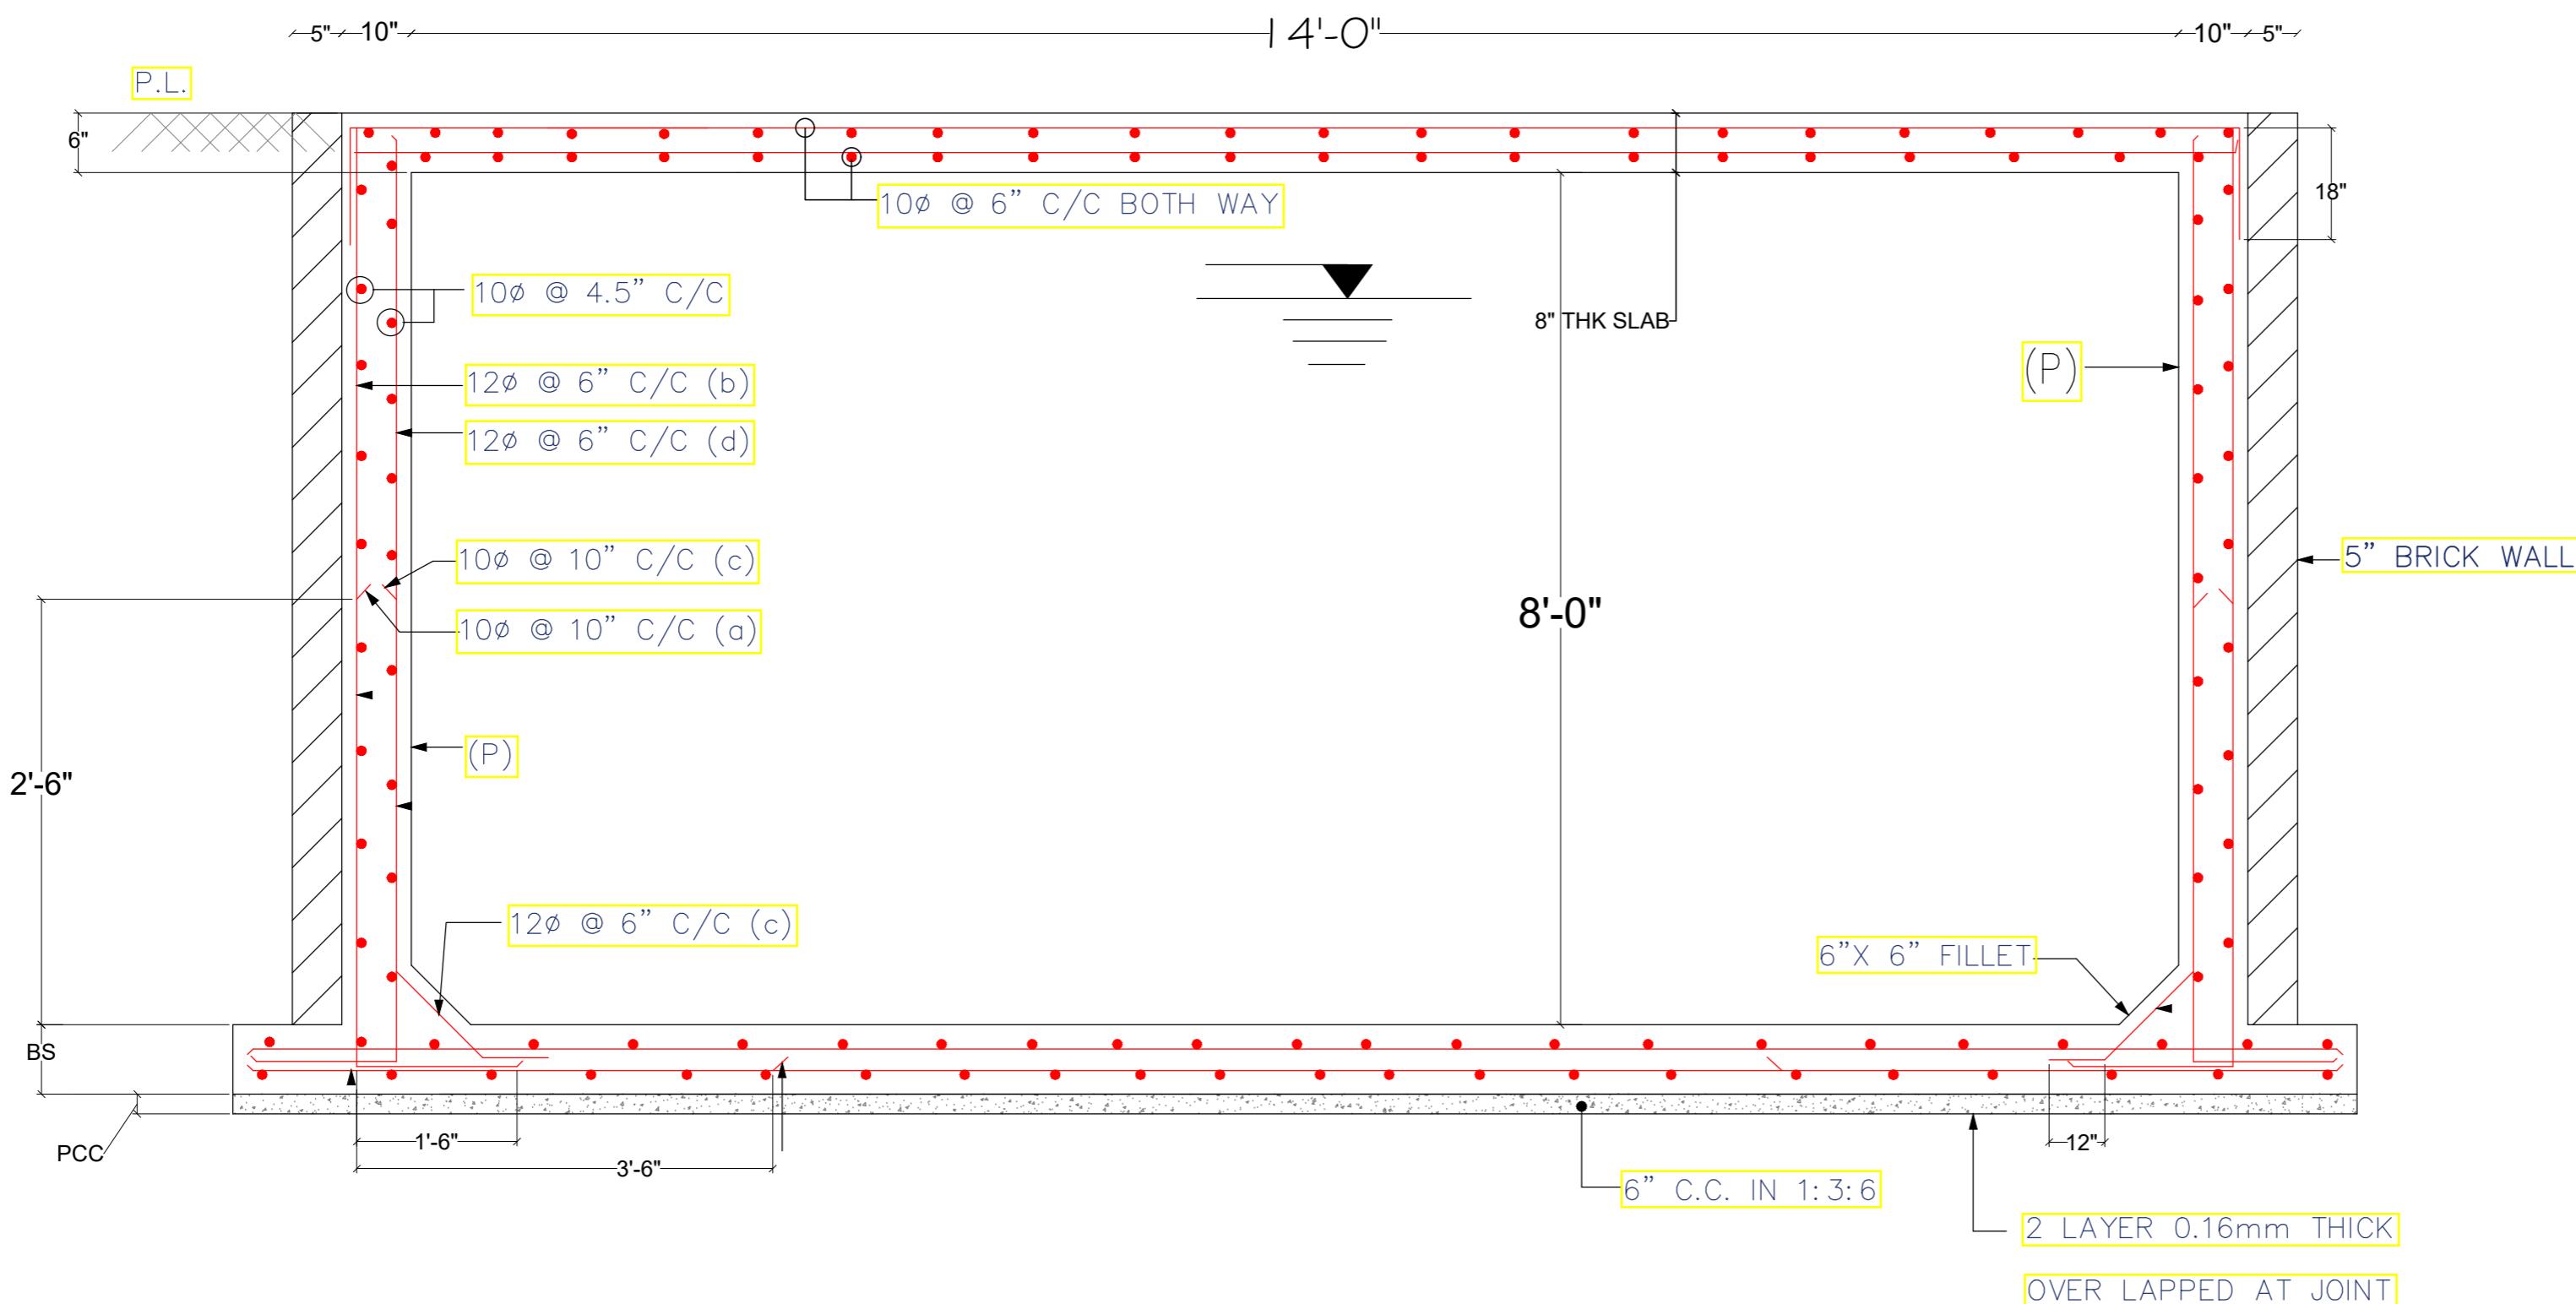

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- FOOTING-50mm, BEAM-25mm, SLAB - 20mm .
- THE MIX FOR ALL R.C.C. WORK SHALL BE M-20 (1:1.5:3).
- ALL THE REINFORCEMENT SHALL BE Fe-500(HSD BARS).
- MINIMUM DEVELOPMENT LENGTH FOR TOR STEEL SHALL BE 50d, WHERE "d" IS DIA OF MAIN REINFORCEMENT.
- THE LAP SHALL BE STAGGERED AND AVOIDED AT THE POINT OF MAXIMUM BENDING MOMENT .
- ALL DIMENSION & LEVEL ARE IN FEET-INCH.

SIGNATURE :-

DRAWN:- AR. DHANESHWARI

DESIGN:- ER. PABITRA

PROJECT TITLE:-

K.I.P SOUMYA

STATUS:

ISSUED FOR CONSTRUCTION

DATE: 04-05-2022

SCALE NTS

DWG NO: 36


DRAWING TITLE:-

STILT FLOOR
ELECTRICAL
LAYOUT




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LEGEND OF ELECTRICAL FITTINGS	
SL.	SPECIFICATION
01	1400mm Sweep Ceiling Fan
02	
03	20W Led Tube Light
04	20W Led Tube Light Surface Mounted (UPS)
05	380mm Sweep Exhaust Fan
06	TV Point
07	5Amps Switch + Plug Socket Outlet Only On Independent Board
08	15Amps Switch + Plug Socket Outlet Only On Independent Board
09	Electrical Panel
10	Branch Distribution Board Light
11	Branch Distribution Board Power
12	Branch Distribution Board Power (UPS)
13	32A Industrial Switch
14	32A Industrial Socket
15	18 watt LED Circular
16	Ceiling Rose
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38	16 amps IP 67 Socket & Switch
39	Switch Board with UPS Powered
40	TV Antenna (MDU)
41	Dressing Unit
42	Foot Light
43	Shoe Polishing Machine
44	Sanitizer Machine
45	Solar Inverter
46	Lead Acid Battery
47	Weather Proof Outdoor light/ Facade Light
48	Junction Box
49	Switch Board with two way Switch
50	UPS power switch Board with two way switch

LEGEND	DESCRIPTION
○	WALL SIDE BELOW THE BEAM
○	WALL CENTRE BELOW THE BEAM

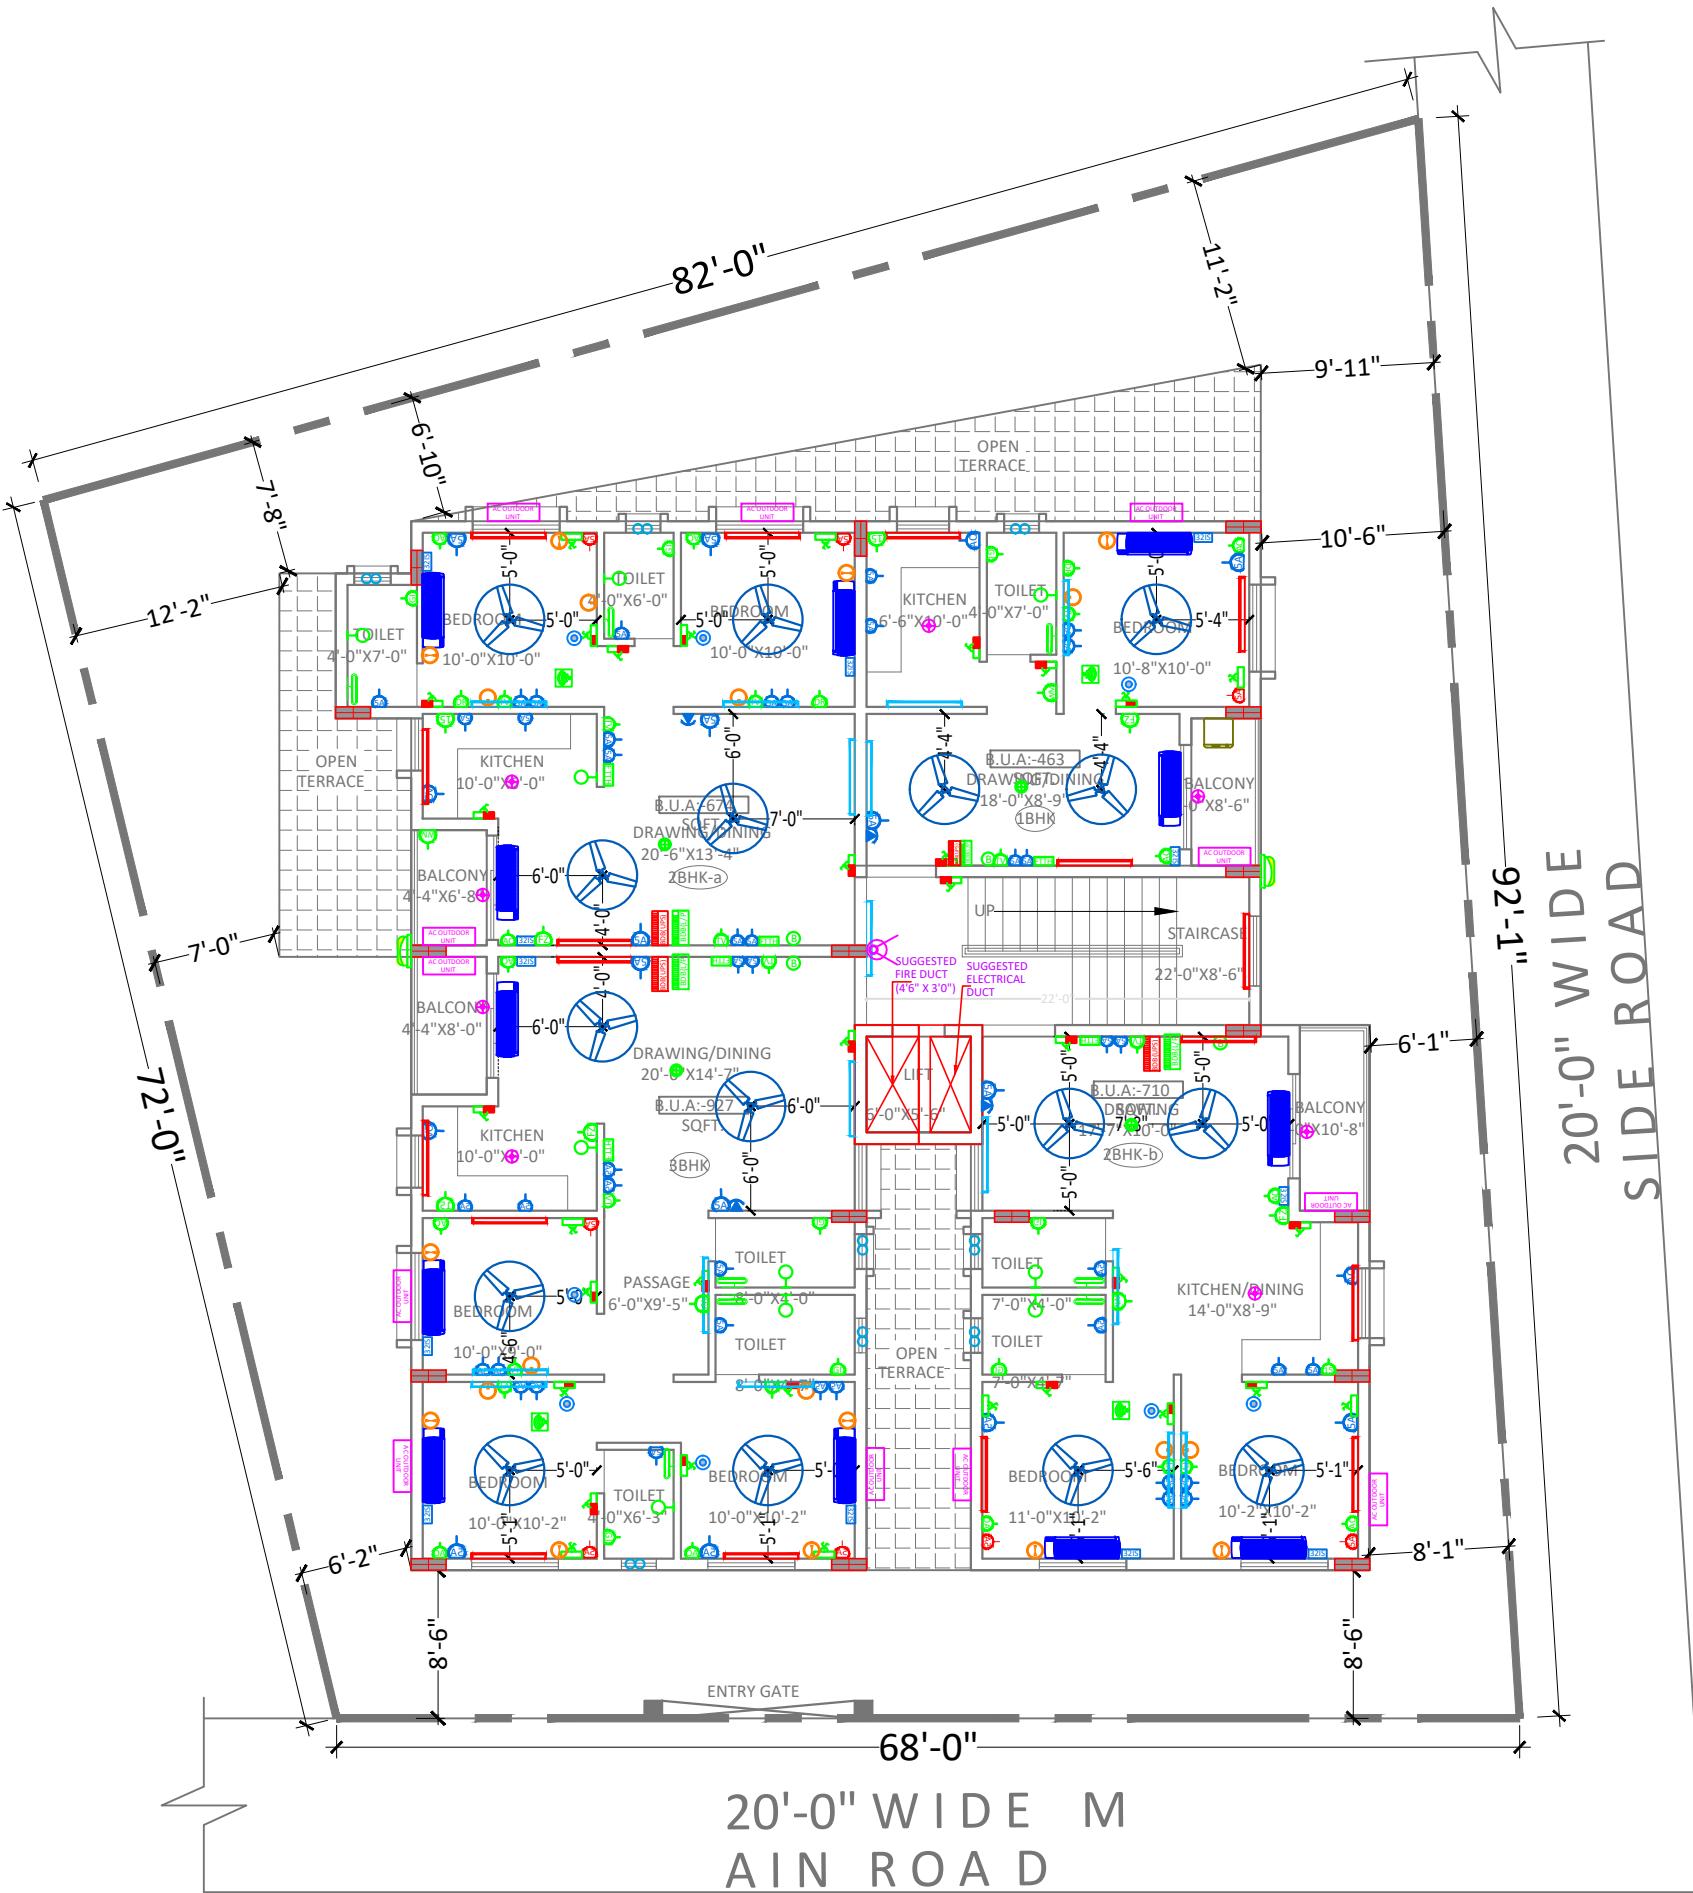

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- THE LAP SHALL BE STAGGERED AND AVOIDED AT THE POINT OF MAXIMUM BENDING MOMENT .
- ALL DIMENSION & LEVEL ARE IN FEET-INCH.

SIGNATURE :-

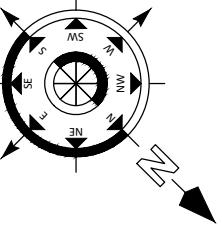DRAWN:- AR. DHANESHWARI

DESIGN:- ER. PABITRA

PROJECT TITLE:-

K.I.P SOUMYA

STATUS:

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DATE: 04-05-2022

SCALE NTS

DWG NO: 37


DRAWING TITLE:-

TYPICAL (1to3rd)
FLOOR ELECTRICAL
LAYOUT




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STAMP/SIGNATURE :-

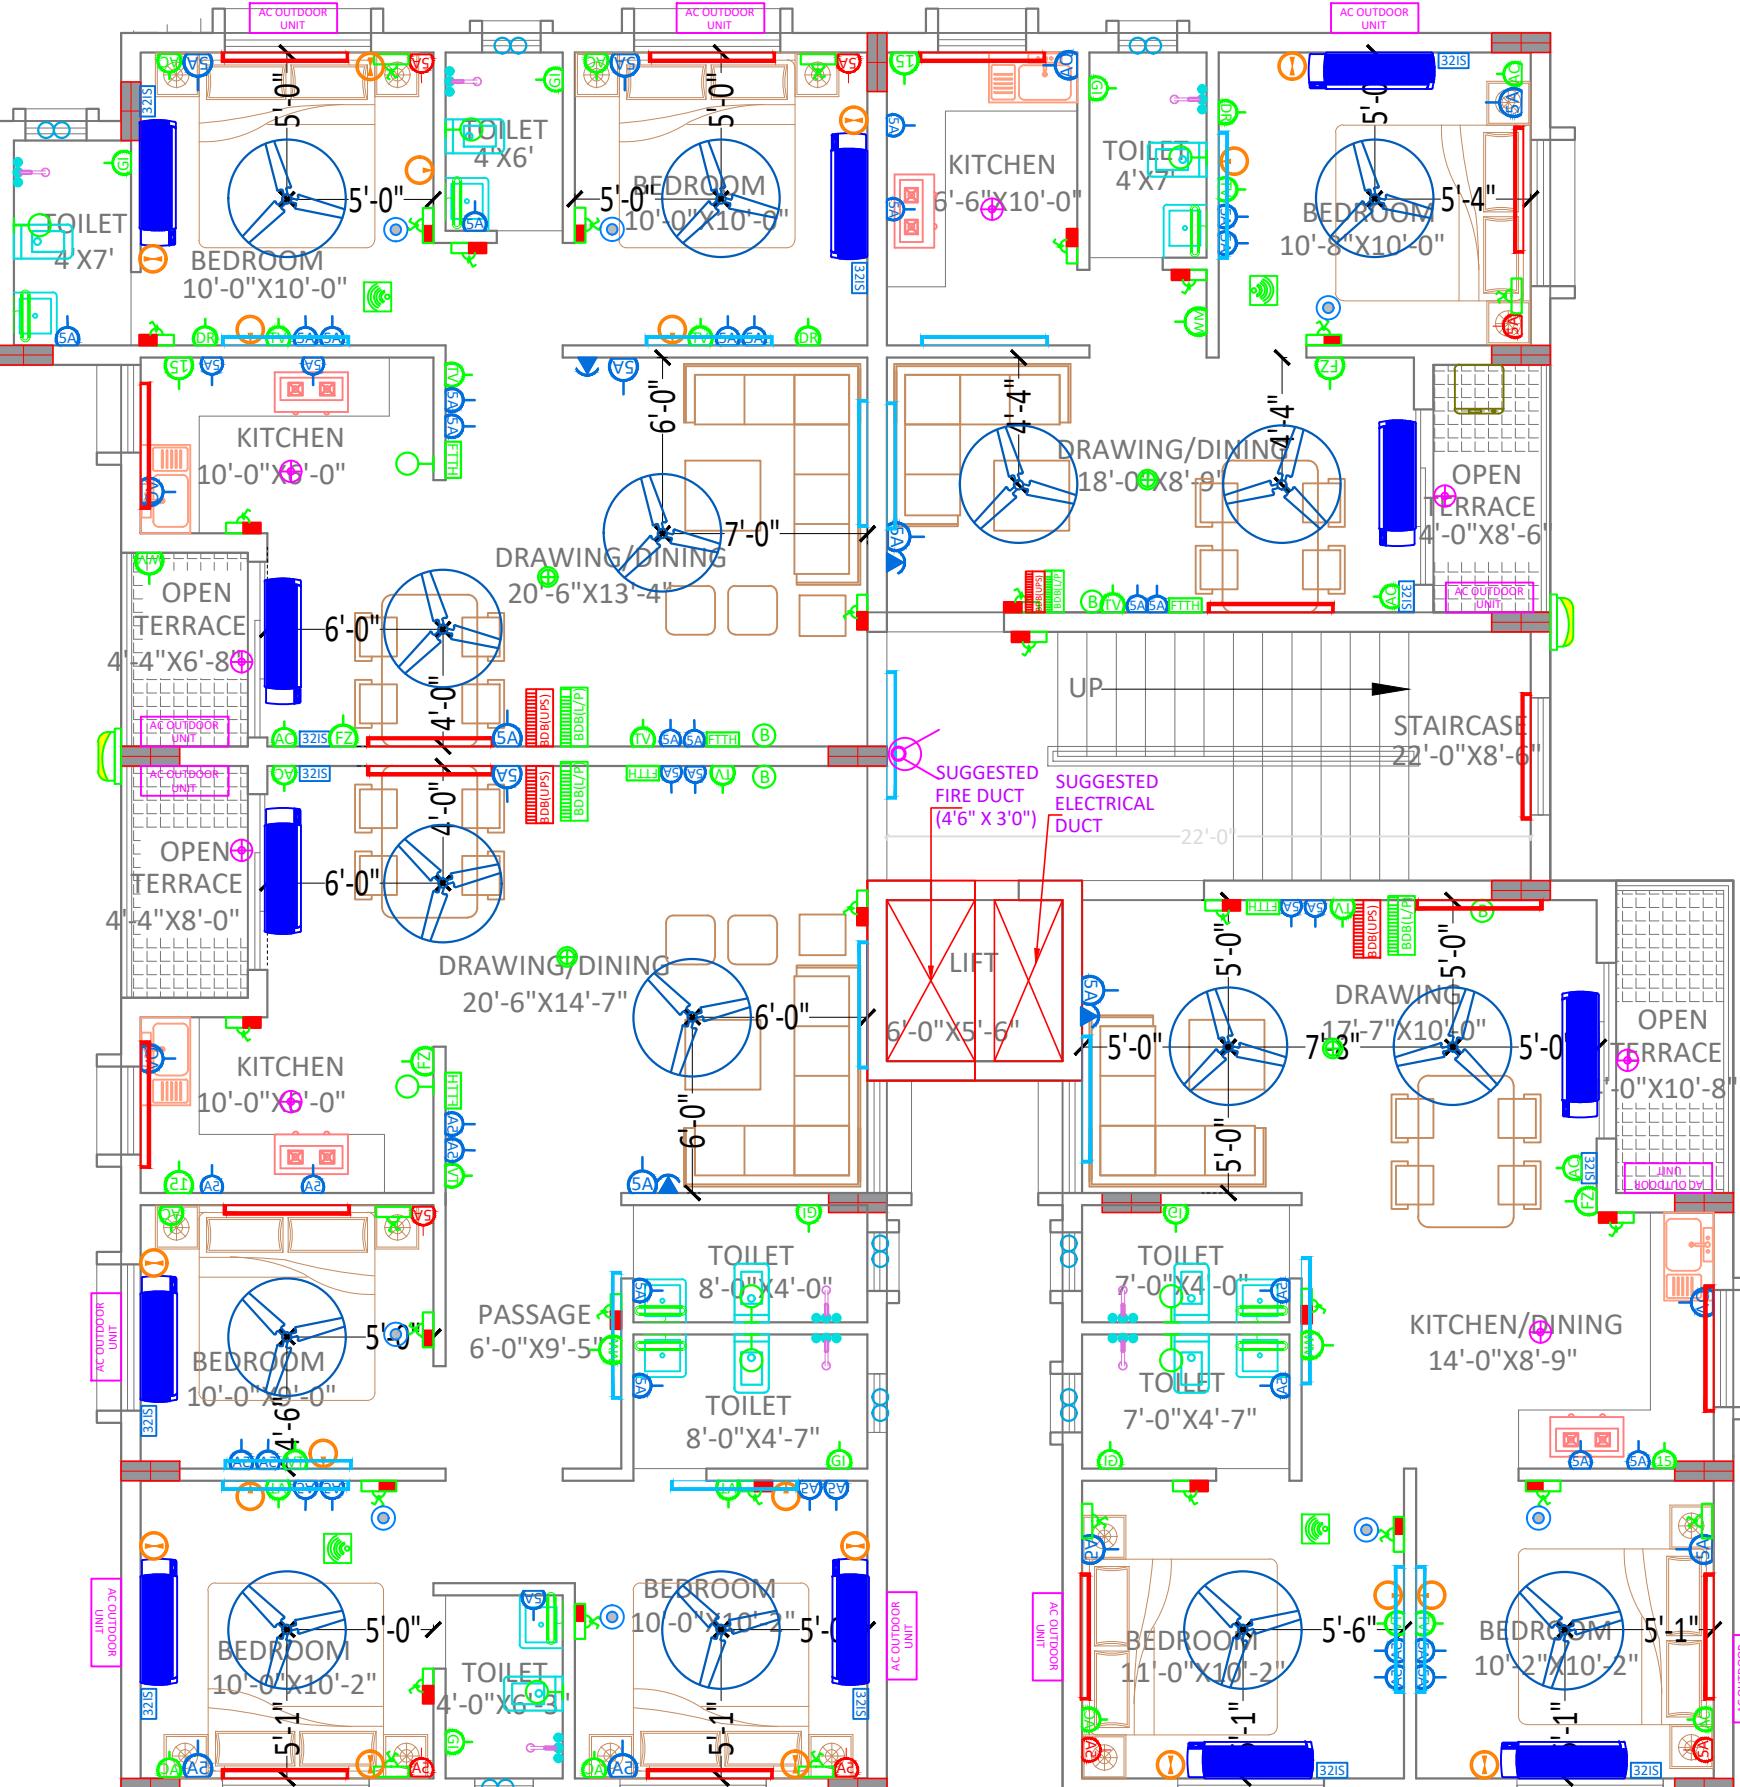

4th FLOOR ELECTRICAL LAYOUT

		LEGEND OF ELECTRICAL FITTINGS
SL	SYMBOL	SPECIFICATION
01		1400mm Sweep Ceiling Fan
02		
03		20W Led Tube Light
04		20W Led Tube Light Surface Mounted (UPS)
05		380mm Sweep Exhaust Fan
06		TV Point
07		5Amps Switch + Plug Socket Outlet Only On Independent Board
08		15Amps Switch + Plug Socket Outlet Only On Independent Board
09		Electrical Panel
10		Branch Distribution Board Light
11		Branch Distribution Board Power
12		Branch Distribution Board Power (UPS)
13		32A Industrial Switch
14		32A Industrial Socket
15		18 watt LED Circular
16		Ceiling Rose
17		Split AC Indoor Unit
18		AC Outdoor Unit
19		Geyser Point
20		Telephone Point
21		Switch Board With UPS Supply
22		15 watt CFL Bulb (Wall Mounted)
23		Switch Board
24		Mirror Light
25		Aquaguard Water Purifier
26		Fridge
27		Calling Bell Switch
28		Calling Bell
29		Bullet Camera (Outdoor Camera)
30		Dome Camera (Indoor Camera)
31		20W Led Tube Light Ceiling Mounted
32		Electric Vehicle Charging Point
33		FTTH
34		Water Sensor Panel
35		Pump Panel
36		Inspection Chamber for Internet Cable
38		16 amps IP 67 Socket & Switch
39		Switch Board with UPS Powered
40		TV Antenna (MDU)
41		Dressing Unit
42		Foot Light
43		Shoe Polishing Machine
44		Sanitizer Machine
45		Solar Inverter
46		Lead Acid Battery
47		Weather Proof Outdoor light/ Facade Light
48		Junction Box
49		Switch Board with two way Switch
50		UPS power switch Board with two way switch

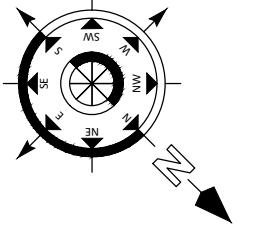

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 - LOAD HAS BEEN TAKEN FOR (G+2) FLOORS ONLY.
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 - FOOTING-50mm, BEAM-25mm, SLAB - 20mm
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 - ALL THE REINFORCEMENT SHALL BE Fe 500(HYSB BARS).
 - MINIMUM DEVELOPMENT LENGTH FOR TOR STEEL SHALL BE 50d, WHERE "d" IS Dia OF MAIN REINFORCEMENT.
 - THE LAP SHALL BE STAGGERED AND AVOIDED AT THE POINT OF MAXIMUM BENDING MOMENT .
 - ALL DIMENSION & LEVEL ARE IN FEET-INCH.

SIGNATURE :-

DRAWN:- AR. DHANESHWARI

K.I.P SOUMYA

STATUS:

ISSUED FOR CONSTRUCTION

DATE: 04-05-2022

SCALE

SCALE

DRAWING TITLE E:-

4th FLOOR ELECTRICAL LAYOUT




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STAMP/SIGNATURE :-



LEGEND OF ELECTRICAL FITTINGS	
SL.	SPECIFICATION
01	1400mm Sweep Ceiling Fan
02	
03	20W Led Tube Light
04	20W Led Tube Light Surface Mounted (UPS)
05	380mm Sweep Exhaust Fan
06	TV Point
07	5Amps Switch + Plug Socket Outlet Only On Independent Board
08	15Amps Switch + Plug Socket Outlet Only On Independent Board
09	ELECTRICAL PANEL
10	Branch Distribution Board Light
11	Branch Distribution Board Power
12	Branch Distribution Board Power (UPS)
13	32A Industrial Switch
14	32A Industrial Socket
15	18 watt LED Circular
16	Ceiling Rose
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18	AC Outdoor Unit
19	Geyser Point
20	Telephone Point
21	Switch Board With UPS Supply
22	15 watt CFL Bulb (Wall Mounted)
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24	Mirror Light
25	Aquaguard Water Purifier
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32	Electric Vehicle Charging Point
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34	Water Sensor Panel
35	Pump Panel
36	Inspection Chamber for Internet Cable
38	16 amps IP 67 Socket & Switch
39	Switch Board with UPS Powered
40	TV Antenna (MDU)
41	Dressing Unit
42	Foot Light
43	Shoe Polishing Machine
44	Sanitizer Machine
45	Solar Inverter
46	Lead Acid Battery
47	Weather Proof Outdoor light/Facade Light
48	Junction Box
49	Switch Board with two way Switch
50	UPS power switch Board with two way switch

LEGEND	DESCRIPTION
○	WALL SIDE BELOW THE BEAM
○	WALL CENTRE BELOW THE BEAM

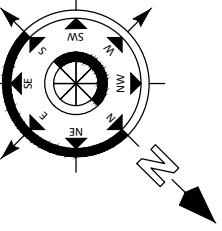

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- ALL THE REINFORCEMENT SHALL BE Fe-500(HSD BARS).
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- THE LAP SHALL BE STAGGERED AND AVOIDED AT THE POINT OF MAXIMUM BENDING MOMENT.
- ALL DIMENSION & LEVEL ARE IN FEET-INCH.

SIGNATURE :-

DRAWN:- AR. DHANESHWARI

DESIGN:- ER. PABITRA

PROJECT TITLE:-

K.I.P SOUMYA

STATUS:

ISSUED FOR CONSTRUCTION

DATE: 04-05-2022

SCALE NTS

DWG NO: 39


DRAWING TITLE:-

STILT FLOOR
ELECTRICAL
CONDUIT LAYOUT



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Pin- 751003
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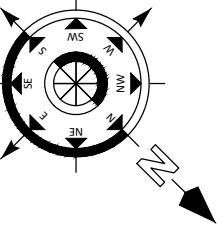
STAMP/SIGNATURE :-

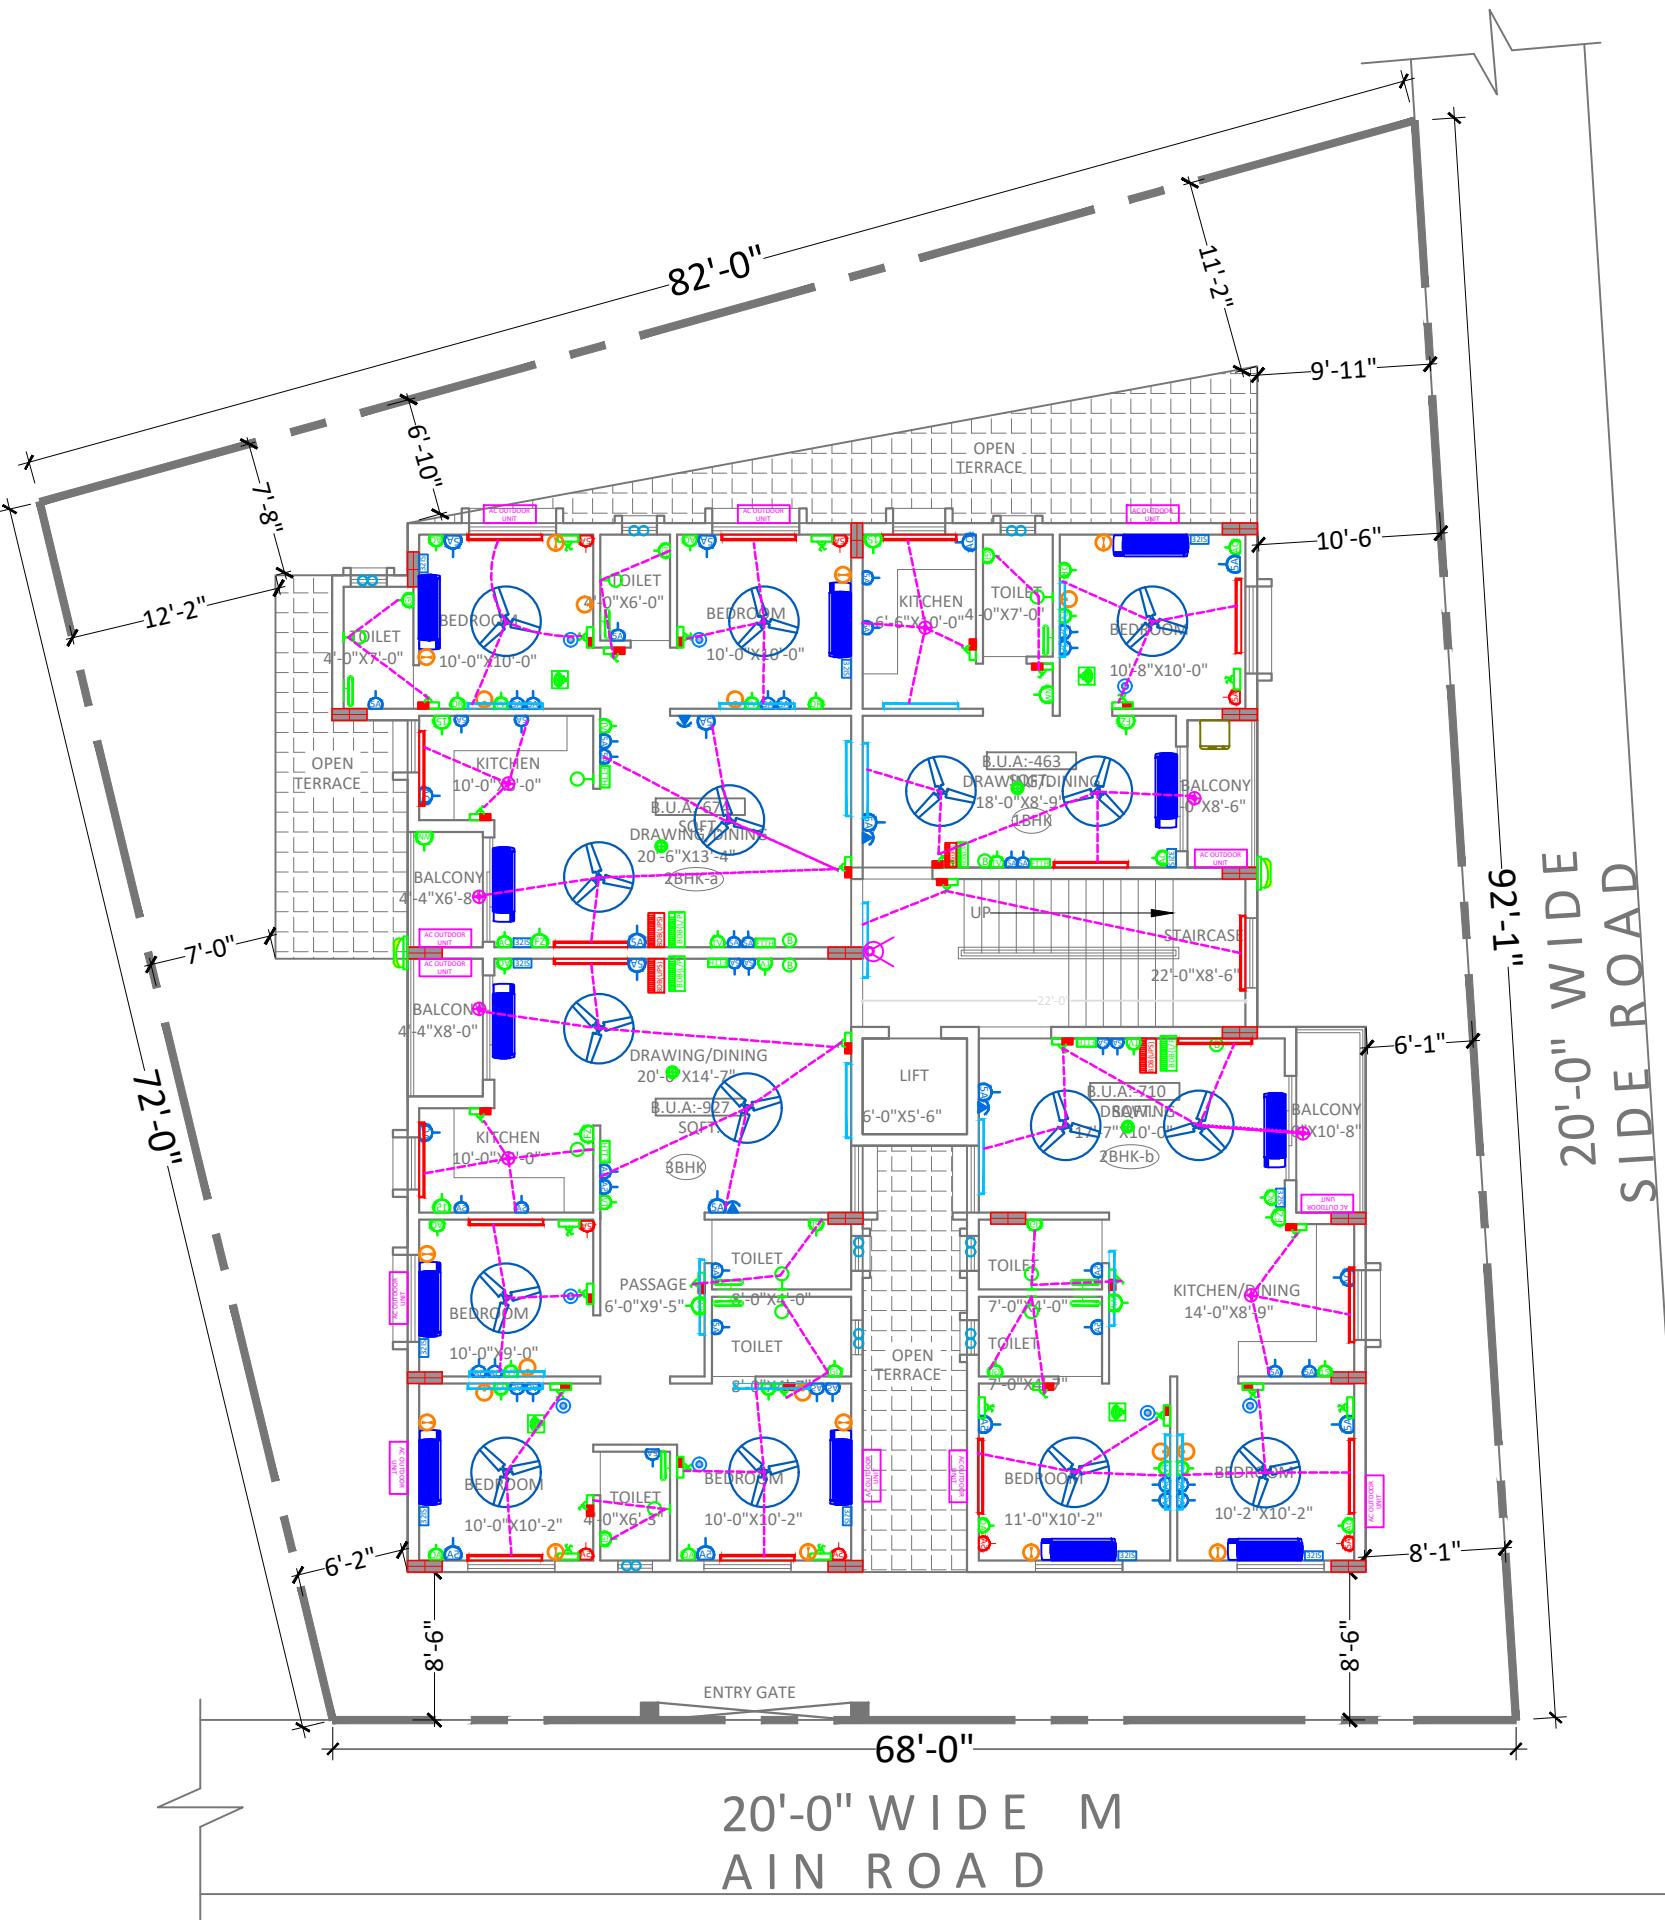

LEGEND OF ELECTRICAL FITTINGS	
SL.	SPECIFICATION
01	1400mm Sweep Ceiling Fan
02	
03	20W Led Tube Light
04	20W Led Tube Light Surface Mounted (UPS)
05	380mm Sweep Exhaust Fan
06	TV Point
07	5Amps Switch + Plug Socket Outlet Only On Independent Board
08	15Amps Switch + Plug Socket Outlet Only On Independent Board
09	ELECTRICAL PANEL
10	Branch Distribution Board Light
11	Branch Distribution Board Power
12	Branch Distribution Board Power (UPS)
13	32A Industrial Switch
14	32A Industrial Socket
15	18 watt LED Circular
16	Ceiling Rose
17	Split AC Indoor Unit
18	AC Outdoor Unit
19	Geyser Point
20	Telephone Point
21	Switch Board With UPS Supply
22	15 watt CFL Bulb (Wall Mounted)
23	Switch Board
24	Mirror Light
25	Aquaguard Water Purifier
26	Fridge
27	Calling Bell Switch
28	Calling Bell
29	Bullet Camera (Outdoor Camera)
30	Dome Camera (Indoor Camera)
31	20W Led Tube Light Ceiling Mounted
32	Electric Vehicle Charging Point
33	FTTH
34	Water Sensor Panel
35	Pump Panel
36	Inspection Chamber for Internet Cable
38	16 amps IP 67 Socket & Switch
39	Switch Board with UPS Powered
40	TV Antenna (MDU)
41	Dressing Unit
42	Foot Light
43	Shoe Polishing Machine
44	Sanitizer Machine
45	Solar Inverter
46	Lead Acid Battery
47	Weather Proof Outdoor light/ Facade Light
48	Junction Box
49	Switch Board with two way Switch
50	UPS power switch Board with two way switch

LEGEND

DESCRIPTION
WALL SIDE BELOW THE BEAM
WALL CENTRE BELOW THE BEAM



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- ALL DIMENSION & LEVEL ARE IN FEET-INCH.

SIGNATURE :-

DRAWN:- AR. DHANESHWARI

DESIGN:- ER. PABITRA

PROJECT TITLE:-

K.I.P SOUMYA

STATUS:

ISSUED FOR CONSTRUCTION

DATE: 04-05-2022

SCALE NTS

DWG NO: 40


DRAWING TITLE:-

TYPICAL (1to 3rd)
FLOOR ELECTRICAL
CONDUIT LAYOUT



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STAMP/SIGNATURE :-

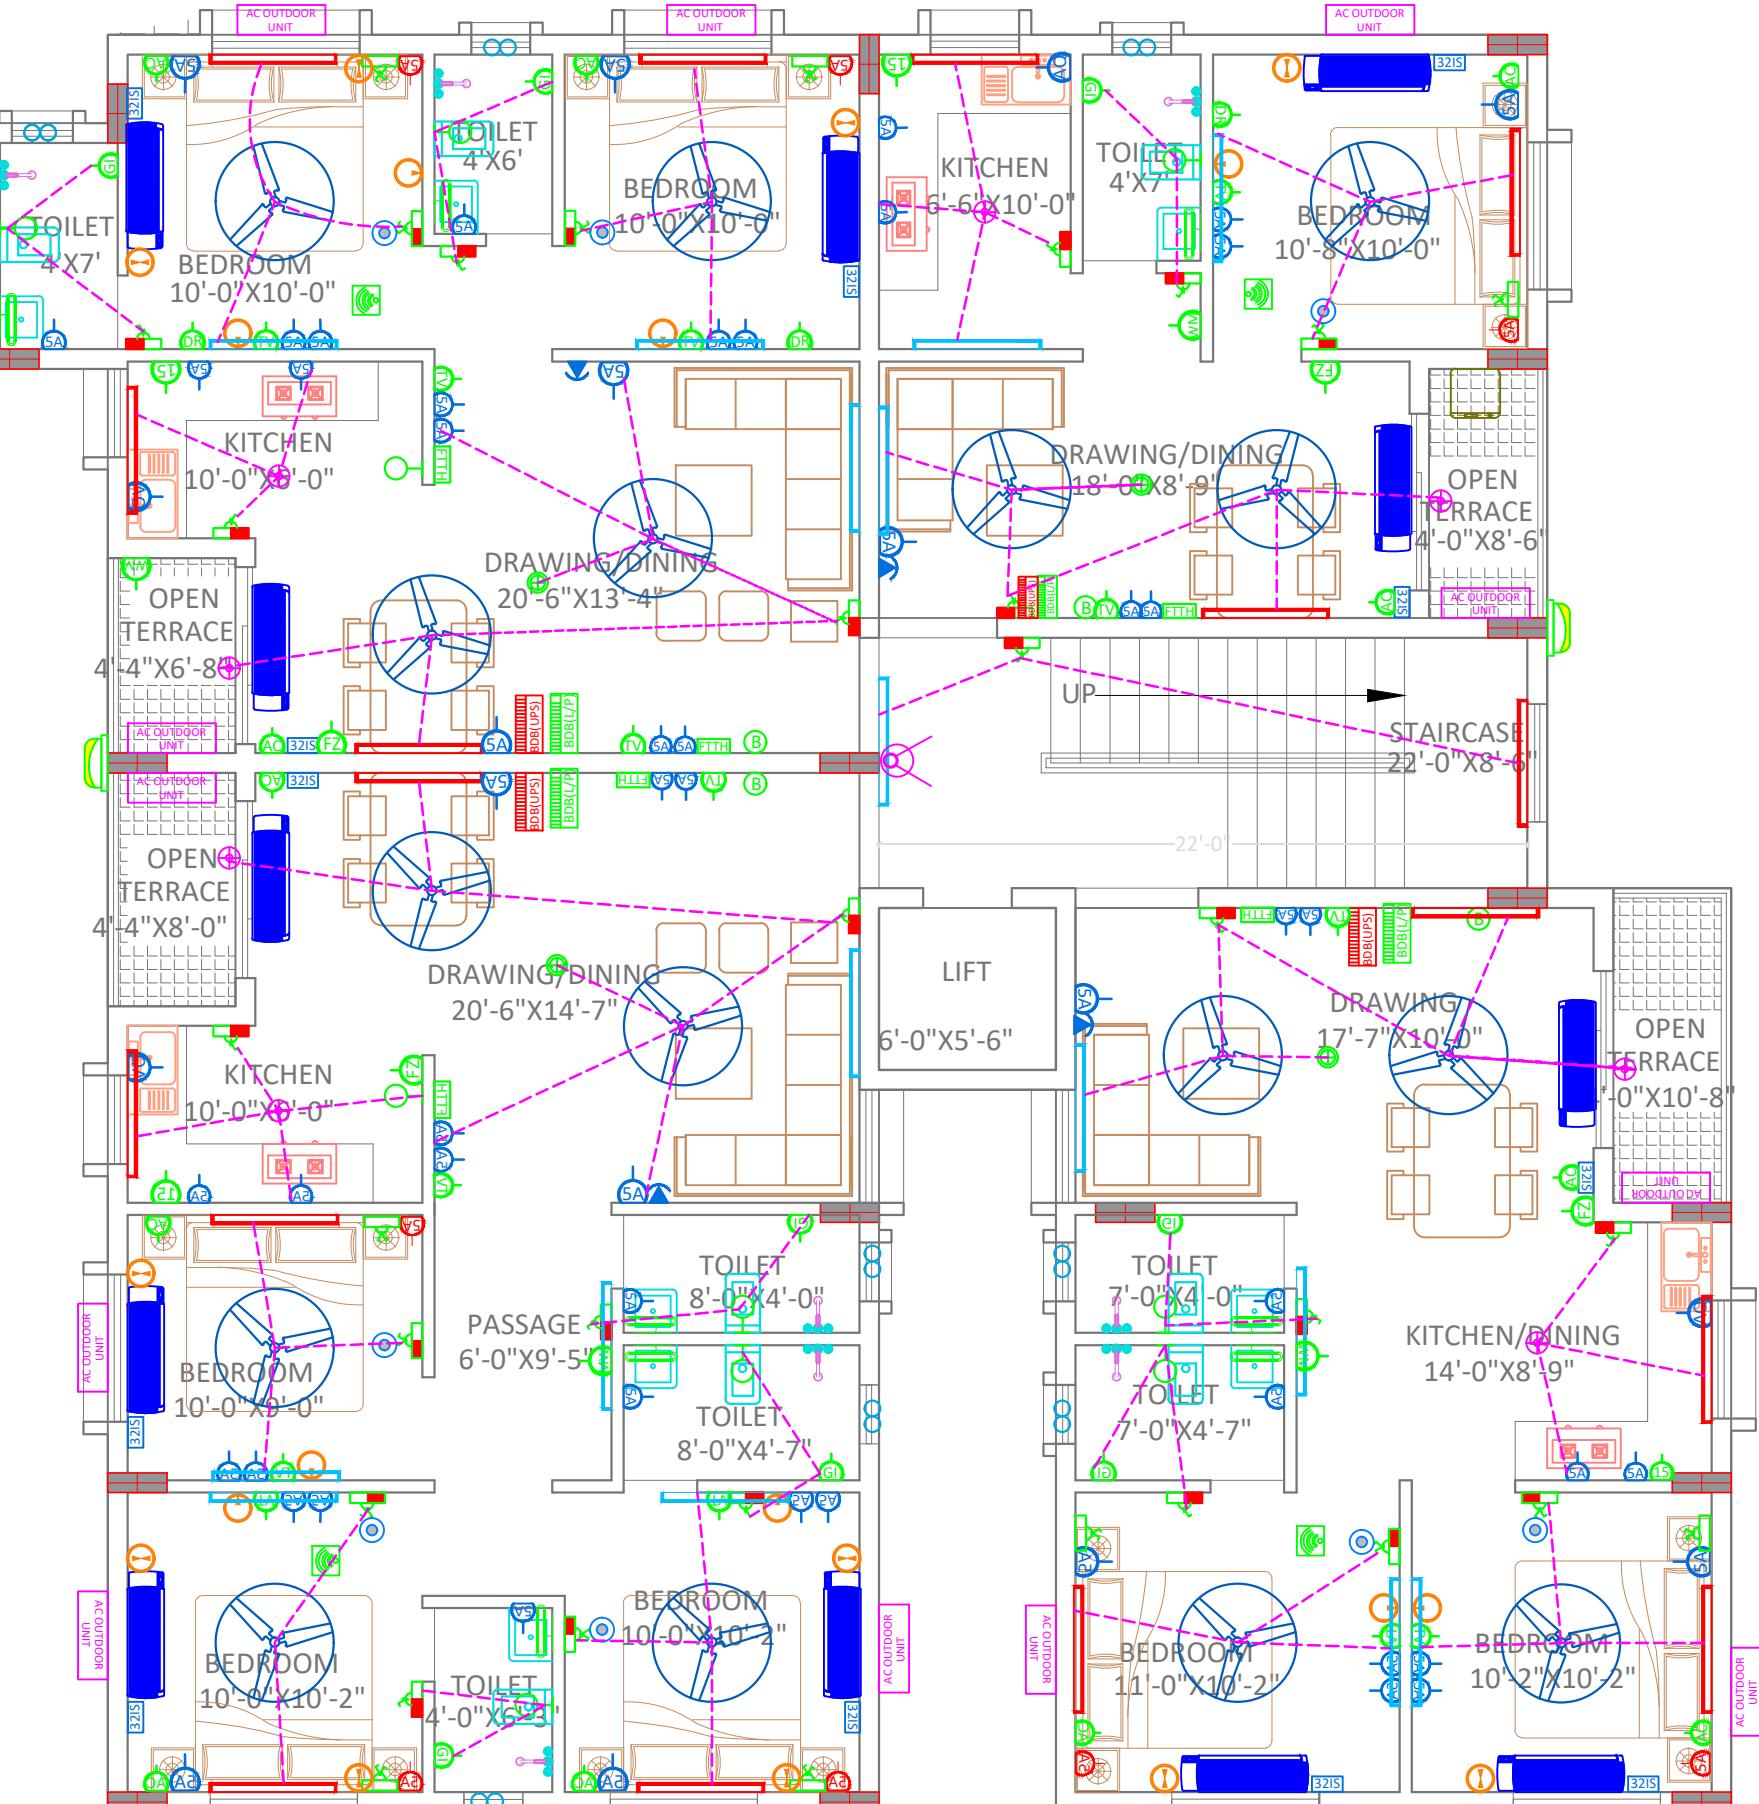


4th FLOOR ELECTRICAL CONDUIT LAYOUT

LEGEND OF ELECTRICAL FITTINGS	
SL.	SPECIFICATION
01	1400mm Sweep Ceiling Fan
02	
03	20W Led Tube Light
04	20W Led Tube Light Surface Mounted (UPS)
05	380mm Sweep Exhaust Fan
06	TV Point
07	5Amps Switch + Plug Socket Outlet Only On Independent Board
08	15Amps Switch + Plug Socket Outlet Only On Independent Board
09	Electrical Panel
10	Branch Distribution Board Light
11	Branch Distribution Board Power
12	Branch Distribution Board Power (UPS)
13	32A Industrial Switch
14	32A Industrial Socket
15	18 watt LED Circular
16	Ceiling Rose
17	Split AC Indoor Unit
18	AC Outdoor Unit
19	Geyser Point
20	Telephone Point
21	Switch Board With UPS Supply
22	15 watt CFL Bulb (Wall Mounted)
23	Switch Board
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28	Calling Bell
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33	FTTH
34	Water Sensor Panel
35	Pump Panel
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38	16 amps IP 67 Socket & Switch
39	Switch Board with UPS Powered
40	TV Antenna (MDU)
41	Dressing Unit
42	Foot Light
43	Shoe Polishing Machine
44	Sanitizer Machine
45	Solar Inverter
46	Lead Acid Battery
47	Weather Proof Outdoor light/ Facade Light
48	Junction Box
49	Switch Board with two way Switch
50	UPS power switch Board with two way switch

LEGEND

DESCRIPTION
WALL SIDE BELOW THE BEAM
WALL CENTRE BELOW THE BEAM

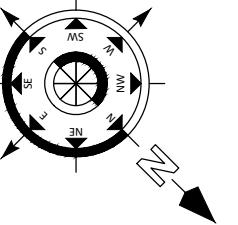

Note:

SIGNATURE :-

DRAWN:- AR. DHANESHWARI

DESIGN:- ER. PABITRA

PROJECT TITLE:-

K.I.P SOUMYA

STATUS:

ISSUED FOR CONSTRUCTION

DATE: 04-05-2022

SCALE NTS

DWG NO: 41

DRAWING TITLE:-


4th FLOOR
ELECTRICAL
CONDUIT LAYOUT



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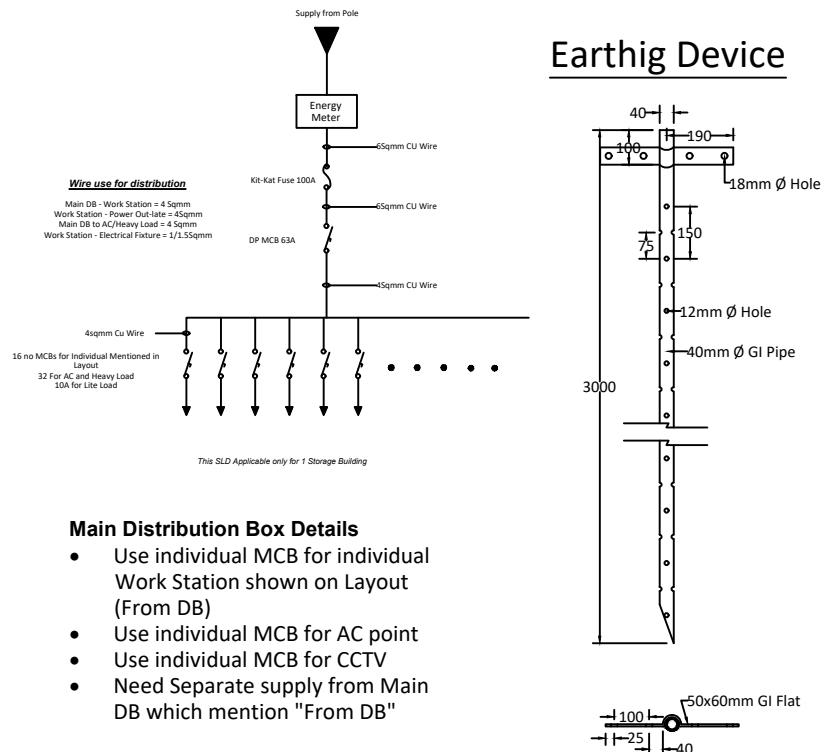


TERRACE FLOOR PLAN

NOTE :

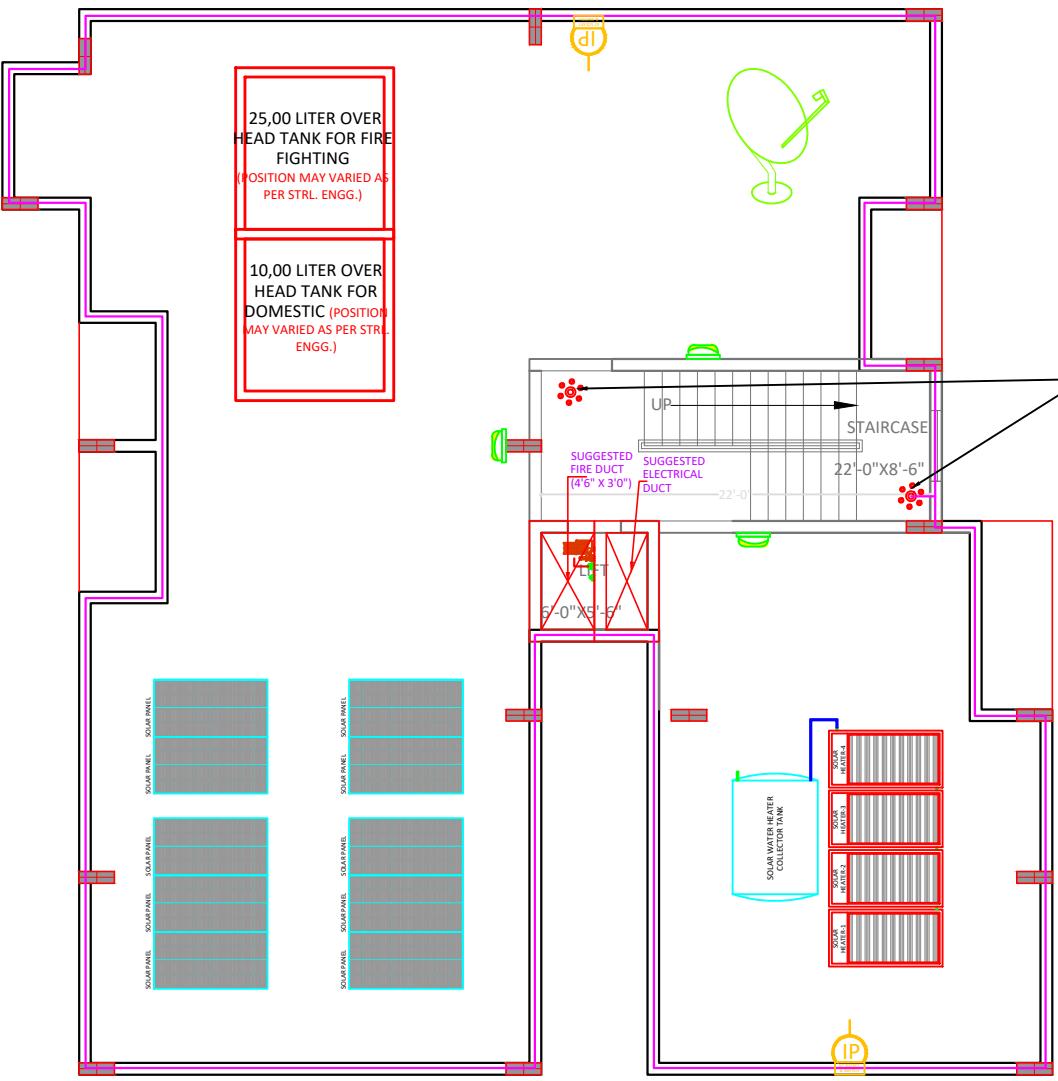1. Drawing is to be read in conjunction of all other architectural drawings.
2. P.V.C. conduit should be of HMS quality and minimum 20mm dia.
3. No conduit is to run in columns & beams, only horizontal crossing & vertical drops in beams is allowed.
4. Minimum 20mm. gaps between two conduit is to be maintained to allow concrete or cement mortar between them.
5. Execution is to be carried out as per I.S specifications.
6. Fan boxes until unless mentioned is to be located in the centre of the area.
7. 15A switch for Geysers can be located in a separate switch board according to site conditions.
8. All the dimension mentioned in the legend and height notes. It may change according to site conditions.

Surge Arrestor AT HEADROOM ROOF LEVEL



Main Distribution Box Details


- Use individual MCB for individual Work Station shown on Layout (From DB)
- Use individual MCB for AC point
- Use individual MCB for CCTV
- Need Separate supply from Main DB which mention "From DB"

HEIGHT NOTES:-

1. SOFA / BED SIDE SWITCH BOARD- 2'6"
2. CHIMNEY & AQUAGUARD SOCKET BOARD- 5'6"
3. LIGHT POINTS - 7'6"
4. SWITCH BOARDS IN KITCHEN ABOVE PLATFORM- 1'0" ABOVE PLATFORM
5. A.C / GEYSER SOCKET BOARD - 7'6"
6. ALL THE OTHER SWITCH BOARD - 4'0"

LEGEND OF ELECTRICAL FITTINGS	
SL.	SPECIFICATION
01	1400mm Sweep Ceiling Fan
02	
03	20W Led Tube Light
04	20W Led Tube Light Surface Mounted (UPS)
05	380mm Sweep Exhaust Fan
06	TV Point
07	5Amps Switch + Plug Socket Outlet Only On Independent Board
08	15Amps Switch + Plug Socket Outlet Only On Independent Board
09	ELECTRICAL PANEL
10	Branch Distribution Board Light
11	Branch Distribution Board Power
12	Branch Distribution Board Power (UPS)
13	32A Industrial Switch
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44	Sanitizer Machine
45	Solar Inverter
46	Lead Acid Battery
47	Weather Proof Outdoor light/ Facade Light
48	Junction Box
49	Switch Board with two way Switch
50	UPS power switch Board with two way switch

LEGEND	DESCRIPTION
○	WALL SIDE BELOW THE BEAM
○	WALL CENTRE BELOW THE BEAM

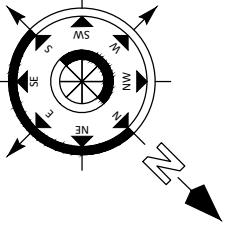

Note:
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• FOOTING-50mm, BEAM-25mm, SLAB - 20mm.
• THE MIX FOR ALL R.C.C. WORK SHALL BE M-20 (1:1.5:3).
• ALL THE REINFORCEMENT SHALL BE Fe-500(HSD BARS).
• MINIMUM DEVELOPMENT LENGTH FOR TOR STEEL SHALL BE 50d, WHERE 'd' IS DIA OF MAIN REINFORCEMENT.
• THE LAP SHALL BE STAGGERED AND AVOIDED AT THE POINT OF MAXIMUM BENDING MOMENT.
• ALL DIMENSION & LEVEL ARE IN FEET-INCH.
SIGNATURE :-

DRAWN:- AR. DHANESHWARI
DESIGN:- ER. PABITRA

PROJECT TITLE:-

K.I.P SOUMYA

STATUS:
ISSUED FOR CONSTRUCTION


DATE: 04-05-2022
SCALE: NTS
DWG NO: 42

DRAWING TITLE:-
TERRACE FLOOR PLAN


APS DESIGN INFRA PVT. LTD
B/48, BDA DUPLEX COLONY
BARMUNDA Bhubaneswar,
Pin- 751003
8 6 5 8 6 7 7 4 2 5
info@apsdesigninfra.com
www.apsdesigninfra.com

STAMP/SIGNATURE :-

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 - ANY DISCREPANCY IN THE DRAWING SHOULD BE BROUGHT TO THE KNOWLEDGE OF CONSULTANT BEFORE EXECUTION.
 - LOAD HAS BEEN TAKEN FOR (G2) FLOORS ONLY.
 - CLEAR COVER TO MAIN REINFORCEMENT SHALL BE FOR COLUMN - 40MM , PLINTH BEAM - 50MM
 - FOOTING-50mm, Beam-25mm, SLab - 20mm .
 - THE MIX FOR ALL R.C.C. WORK SHALL BE M-20 (1:1.5:3) .
 - ALL THE REINFORCEMENT SHALL Be F600(HYSD BARS).
 - MINIMUM DEVELOPMENT LENGTH FOR TOR STEEL SHALL BE 50d, WHERE "d" IS DIA OF MAIN REINFORCEMENT.
 - THE LAP SHALL BE STAGGERED AND AVOIDED AT THE POINT OF MAXIMUM BENDING MOMENT .
 - ALL DIMENSION & LEVEL ARE IN FEET-INCH.

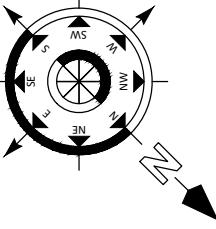SIGNATURE :-

DRAWN:-	AR. DHANESHWARI
DESIGN:-	ER. PABITRA

PROJECT TITLE:-

K.I.P SOUMYA

STATUS:

ISSUED FOR CONSTRUCTION

DATE:	04-05-2022
SCALE	NTS
DWG NO:	43




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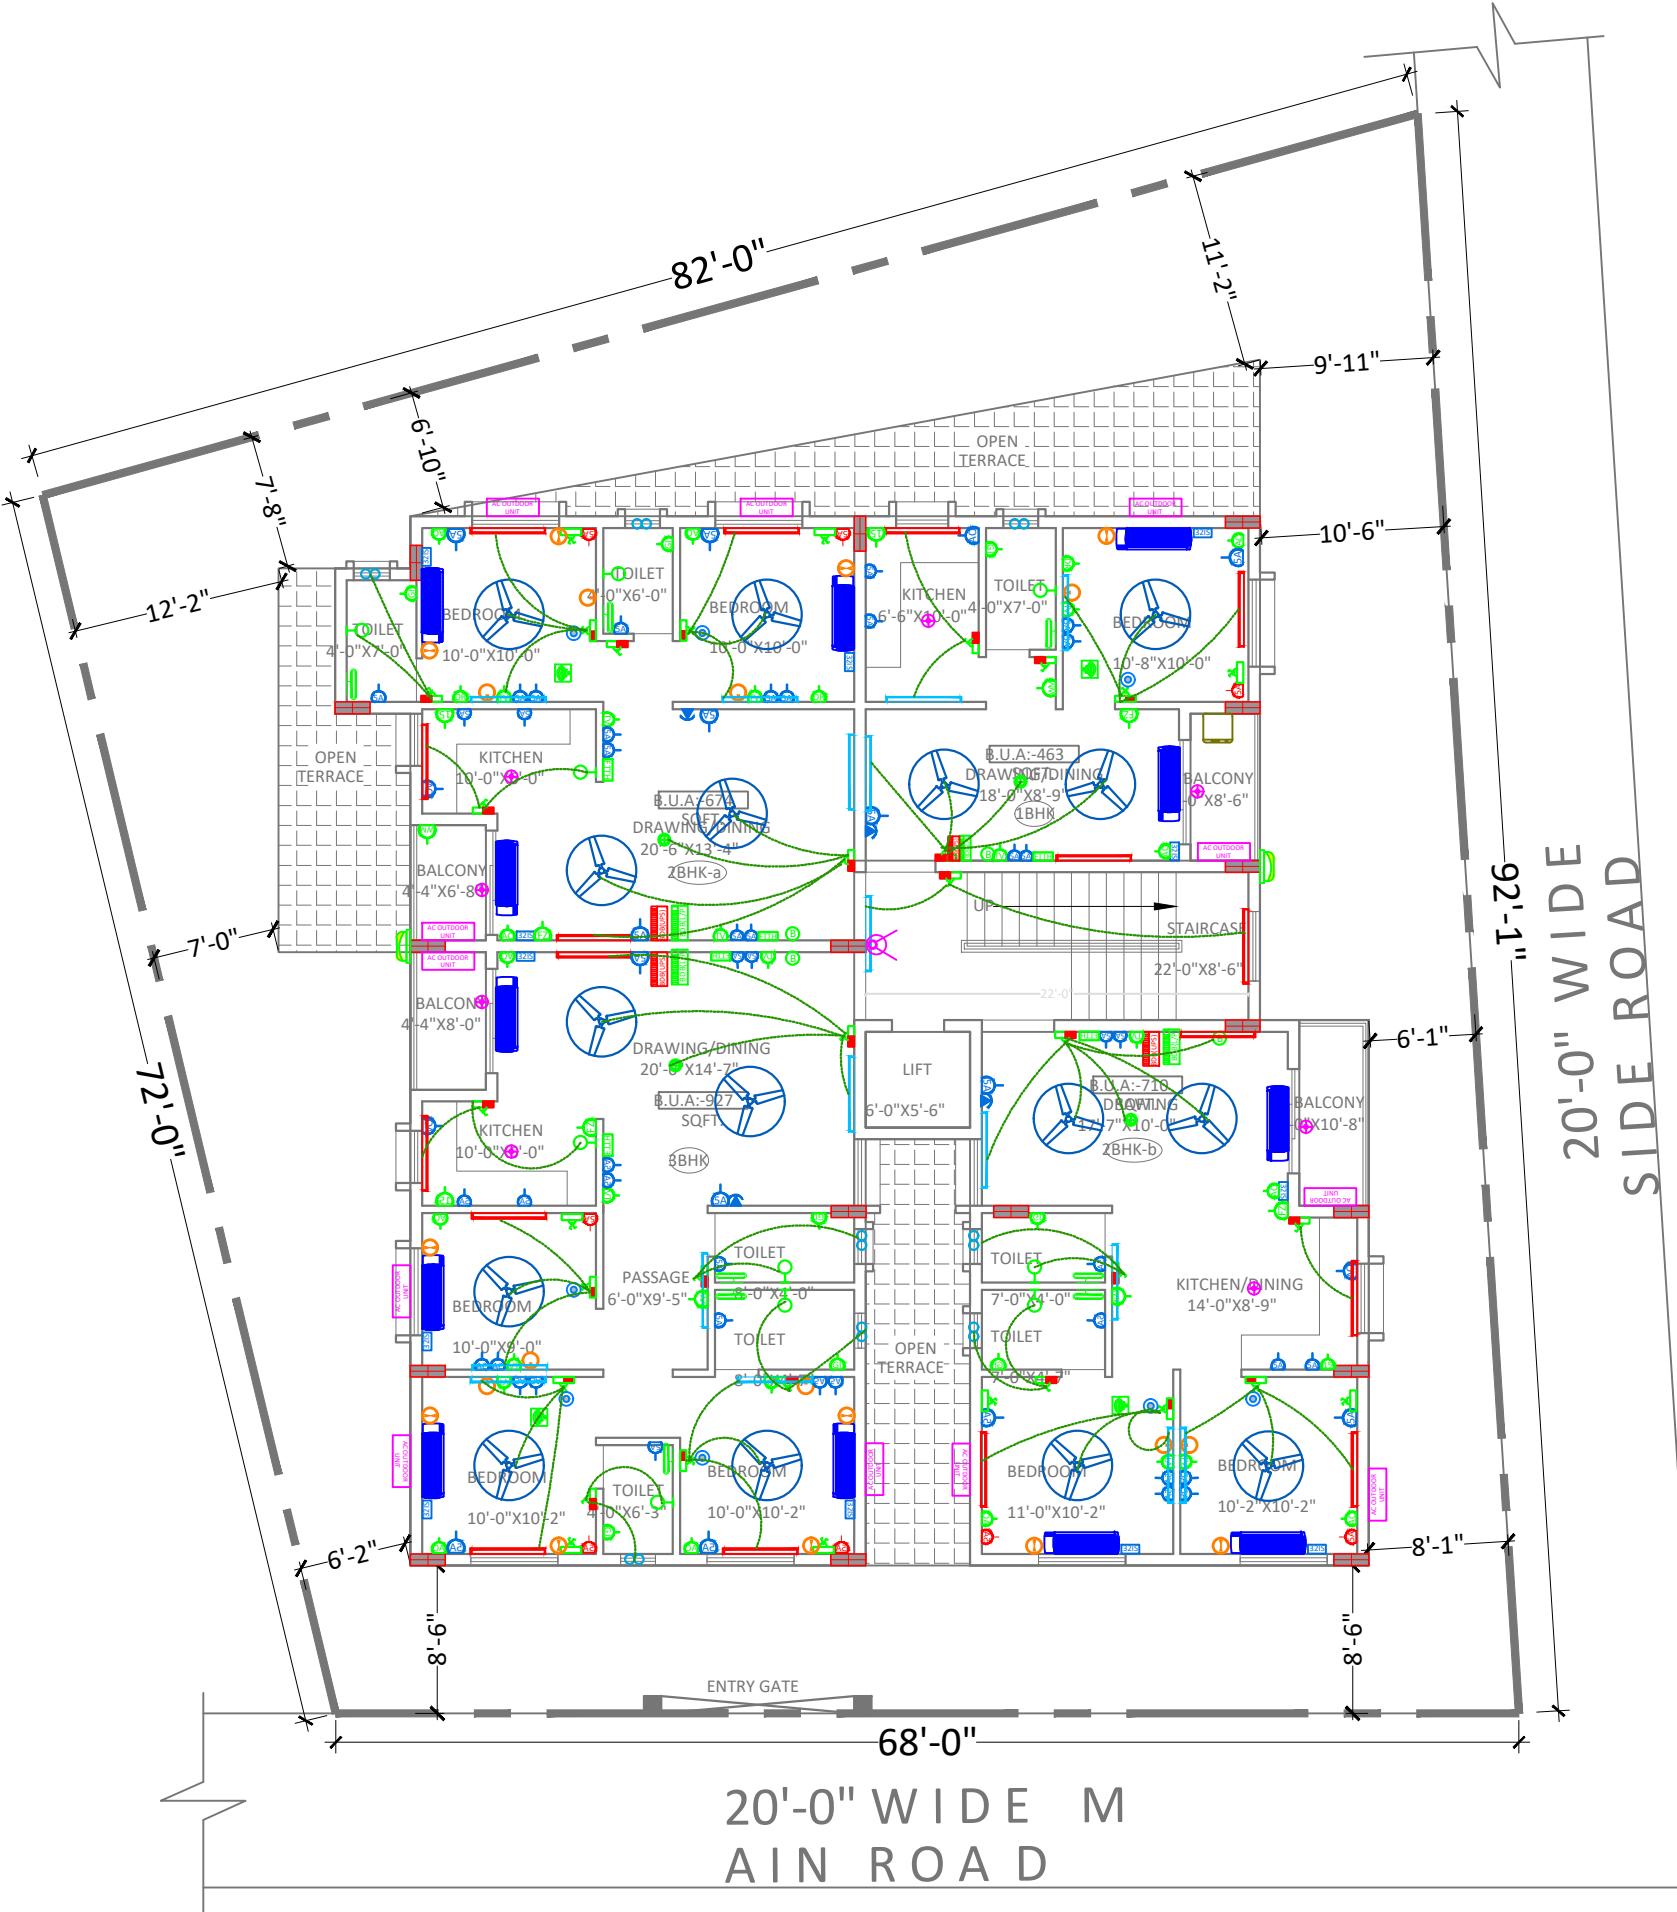
ELECTRICAL **DETAIL DRAWING**



APS DESIGN INFRA PVT. LTD
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BARMUNDA Bhubaneswar,
Pin- 751003
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STAMP/SIGNATURE :-




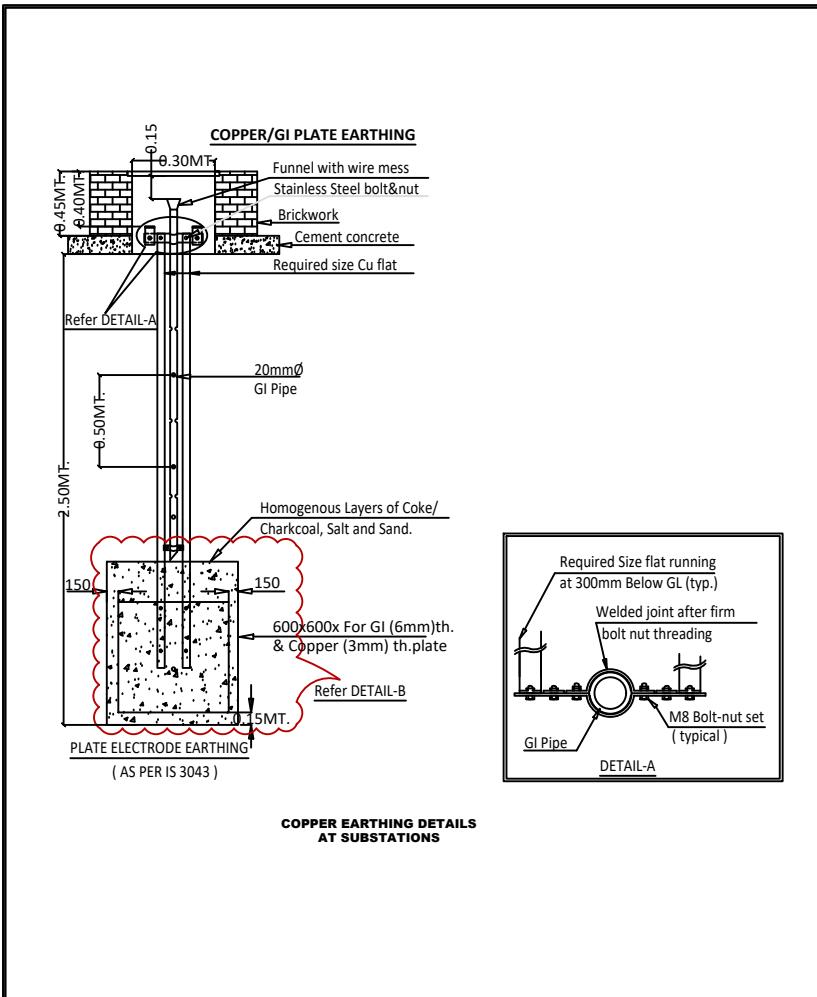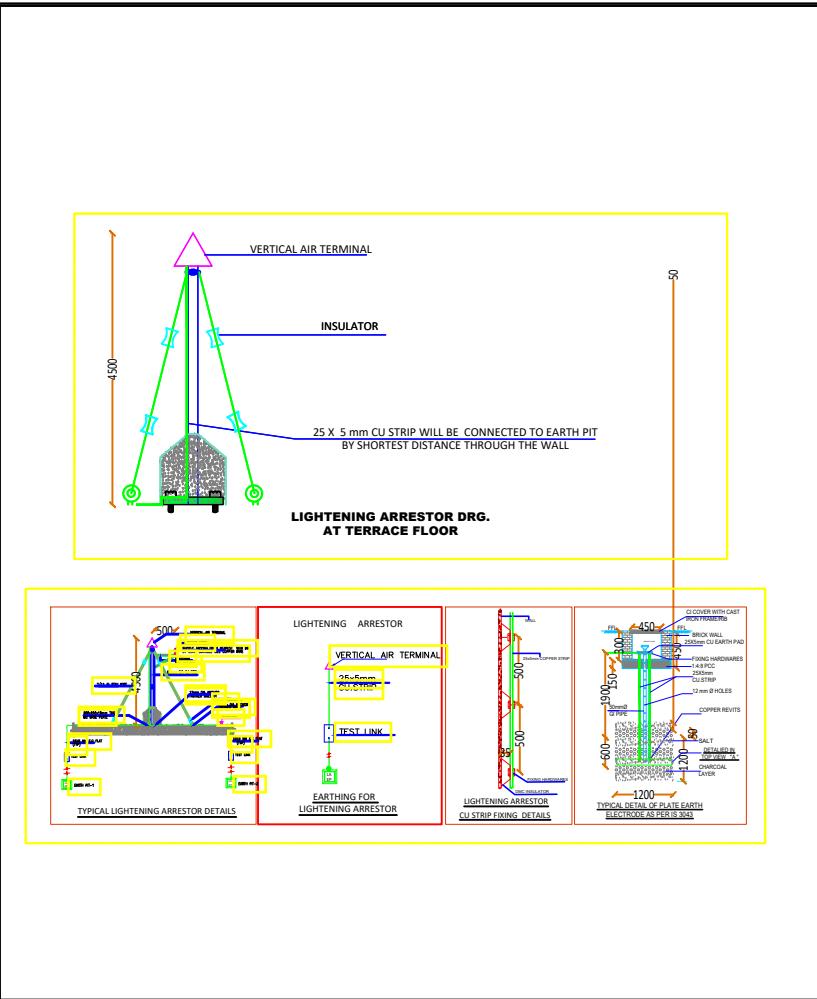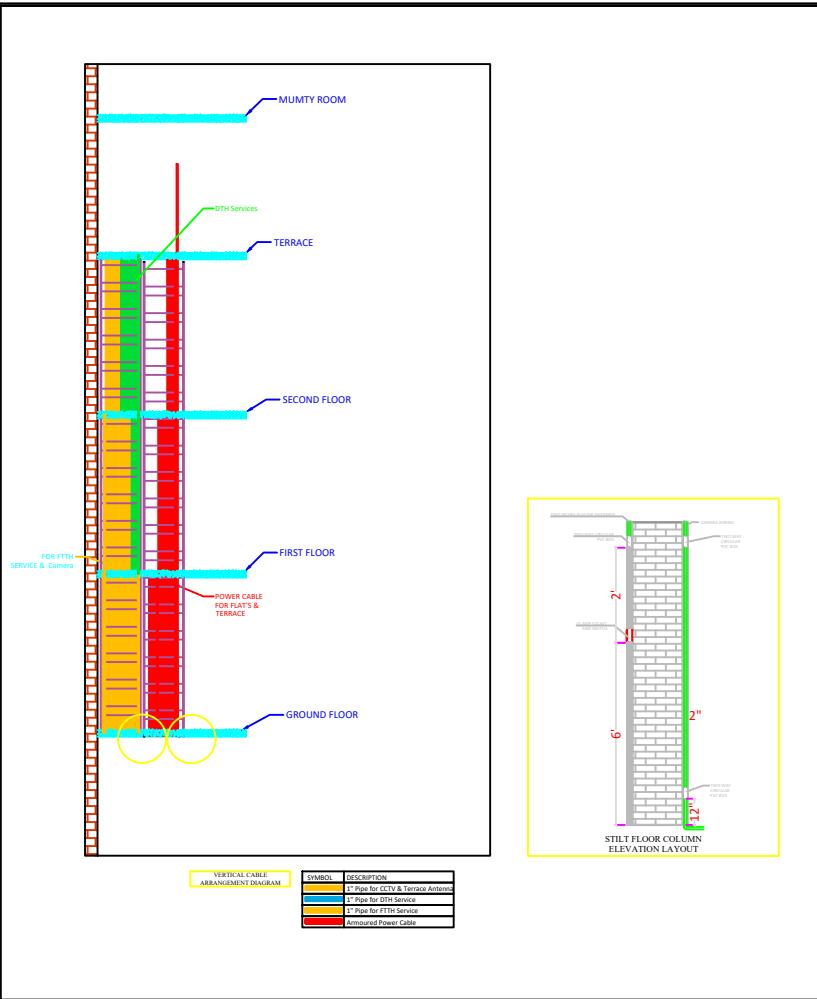

LEGEND OF ELECTRICAL FITTINGS	
SL.	SPECIFICATION
01	1400mm Sweep Ceiling Fan
02	
03	20W Led Tube Light
04	20W Led Tube Light Surface Mounted (UPS)
05	380mm Sweep Exhaust Fan
06	TV Point
07	5Amps Switch + Plug Socket Outlet Only On Independent Board
08	15Amps Switch + Plug Socket Outlet Only On Independent Board
09	ELECTRICAL PANEL
10	Branch Distribution Board Light
11	Branch Distribution Board Power
12	Branch Distribution Board Power (UPS)
13	32A Industrial Switch
14	32A Industrial Socket
15	18 watt LED Circular
16	Ceiling Rose
17	Split AC Indoor Unit
18	AC Outdoor Unit
19	Geyser Point
20	Telephone Point
21	Switch Board With UPS Supply
22	15 watt CFL Bulb (Wall Mounted)
23	Switch Board
24	Mirror Light
25	Aquaguard Water Purifier
26	Fridge
27	Calling Bell Switch
28	Calling Bell
29	Bullet Camera (Outdoor Camera)
30	Dome Camera (Indoor Camera)
31	20W Led Tube Light Ceiling Mounted
32	Electric Vehicle Charging Point
33	FTTH
34	Water Sensor Panel
35	Pump Panel
36	Inspection Chamber for Internet Cable
38	16 amps IP 67 Socket & Switch
39	Switch Board with UPS Powered
40	TV Antenna (MDU)
41	Dressing Unit
42	Foot Light
43	Shoe Polishing Machine
44	Sanitizer Machine
45	Solar Inverter
46	Lead Acid Battery
47	Weather Proof Outdoor light/ Facade Light
48	Junction Box
49	Switch Board with two way Switch
50	UPS power switch Board with two way switch

LEGEND

DESCRIPTION
WALL SIDE BELOW THE BEAM
WALL CENTRE BELOW THE BEAM

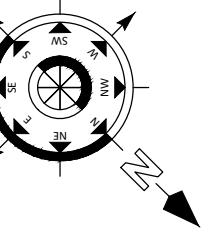

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- ANY DISCREPANCY IN THE DRAWING SHOULD BE BROUGHT TO THE KNOWLEDGE OF CONSULTANT BEFORE EXECUTION.
- DO NOT DEPEND FOR (G-3) FLOORS ONLY.
- CLEAR COVER TO MAIN REINFORCEMENT SHALL BE FOR COLUMN - 40MM, PLINTH BEAM - 30MM
- FOOTING-50mm, BEAM-25mm, SLAB - 20mm .
- THE MIX FOR ALL R.C.C. WORK SHALL BE M-20 (1:1.5:3).
- ALL THE REINFORCEMENT SHALL BE Fe-500(HSD BARS).
- MINIMUM DEVELOPMENT LENGTH FOR TOR STEEL SHALL BE 50d, WHERE "d" IS DIA OF MAIN REINFORCEMENT.
- THE LAP SHALL BE STAGGERED AND AVOIDED AT THE POINT OF MAXIMUM BENDING MOMENT .
- ALL DIMENSION & LEVEL ARE IN FEET-INCH.

SIGNATURE :-

DRAWN:- AR. DHANESHWARI

DESIGN:- ER. PABITRA

PROJECT TITLE:-

K.I.P SOUMYA

STATUS:

ISSUED FOR CONSTRUCTION

DATE: 04-05-2022

SCALE NTS

DWG NO: 44


DRAWING TITLE:-

TYPICAL (1to 3rd) FLOOR ELECTRICAL CIRCUIT LAYOUT



APS DESIGN INFRA PVT. LTD
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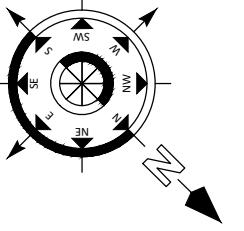


4th FLOOR ELECTRICAL CIRCUIT LAYOUT

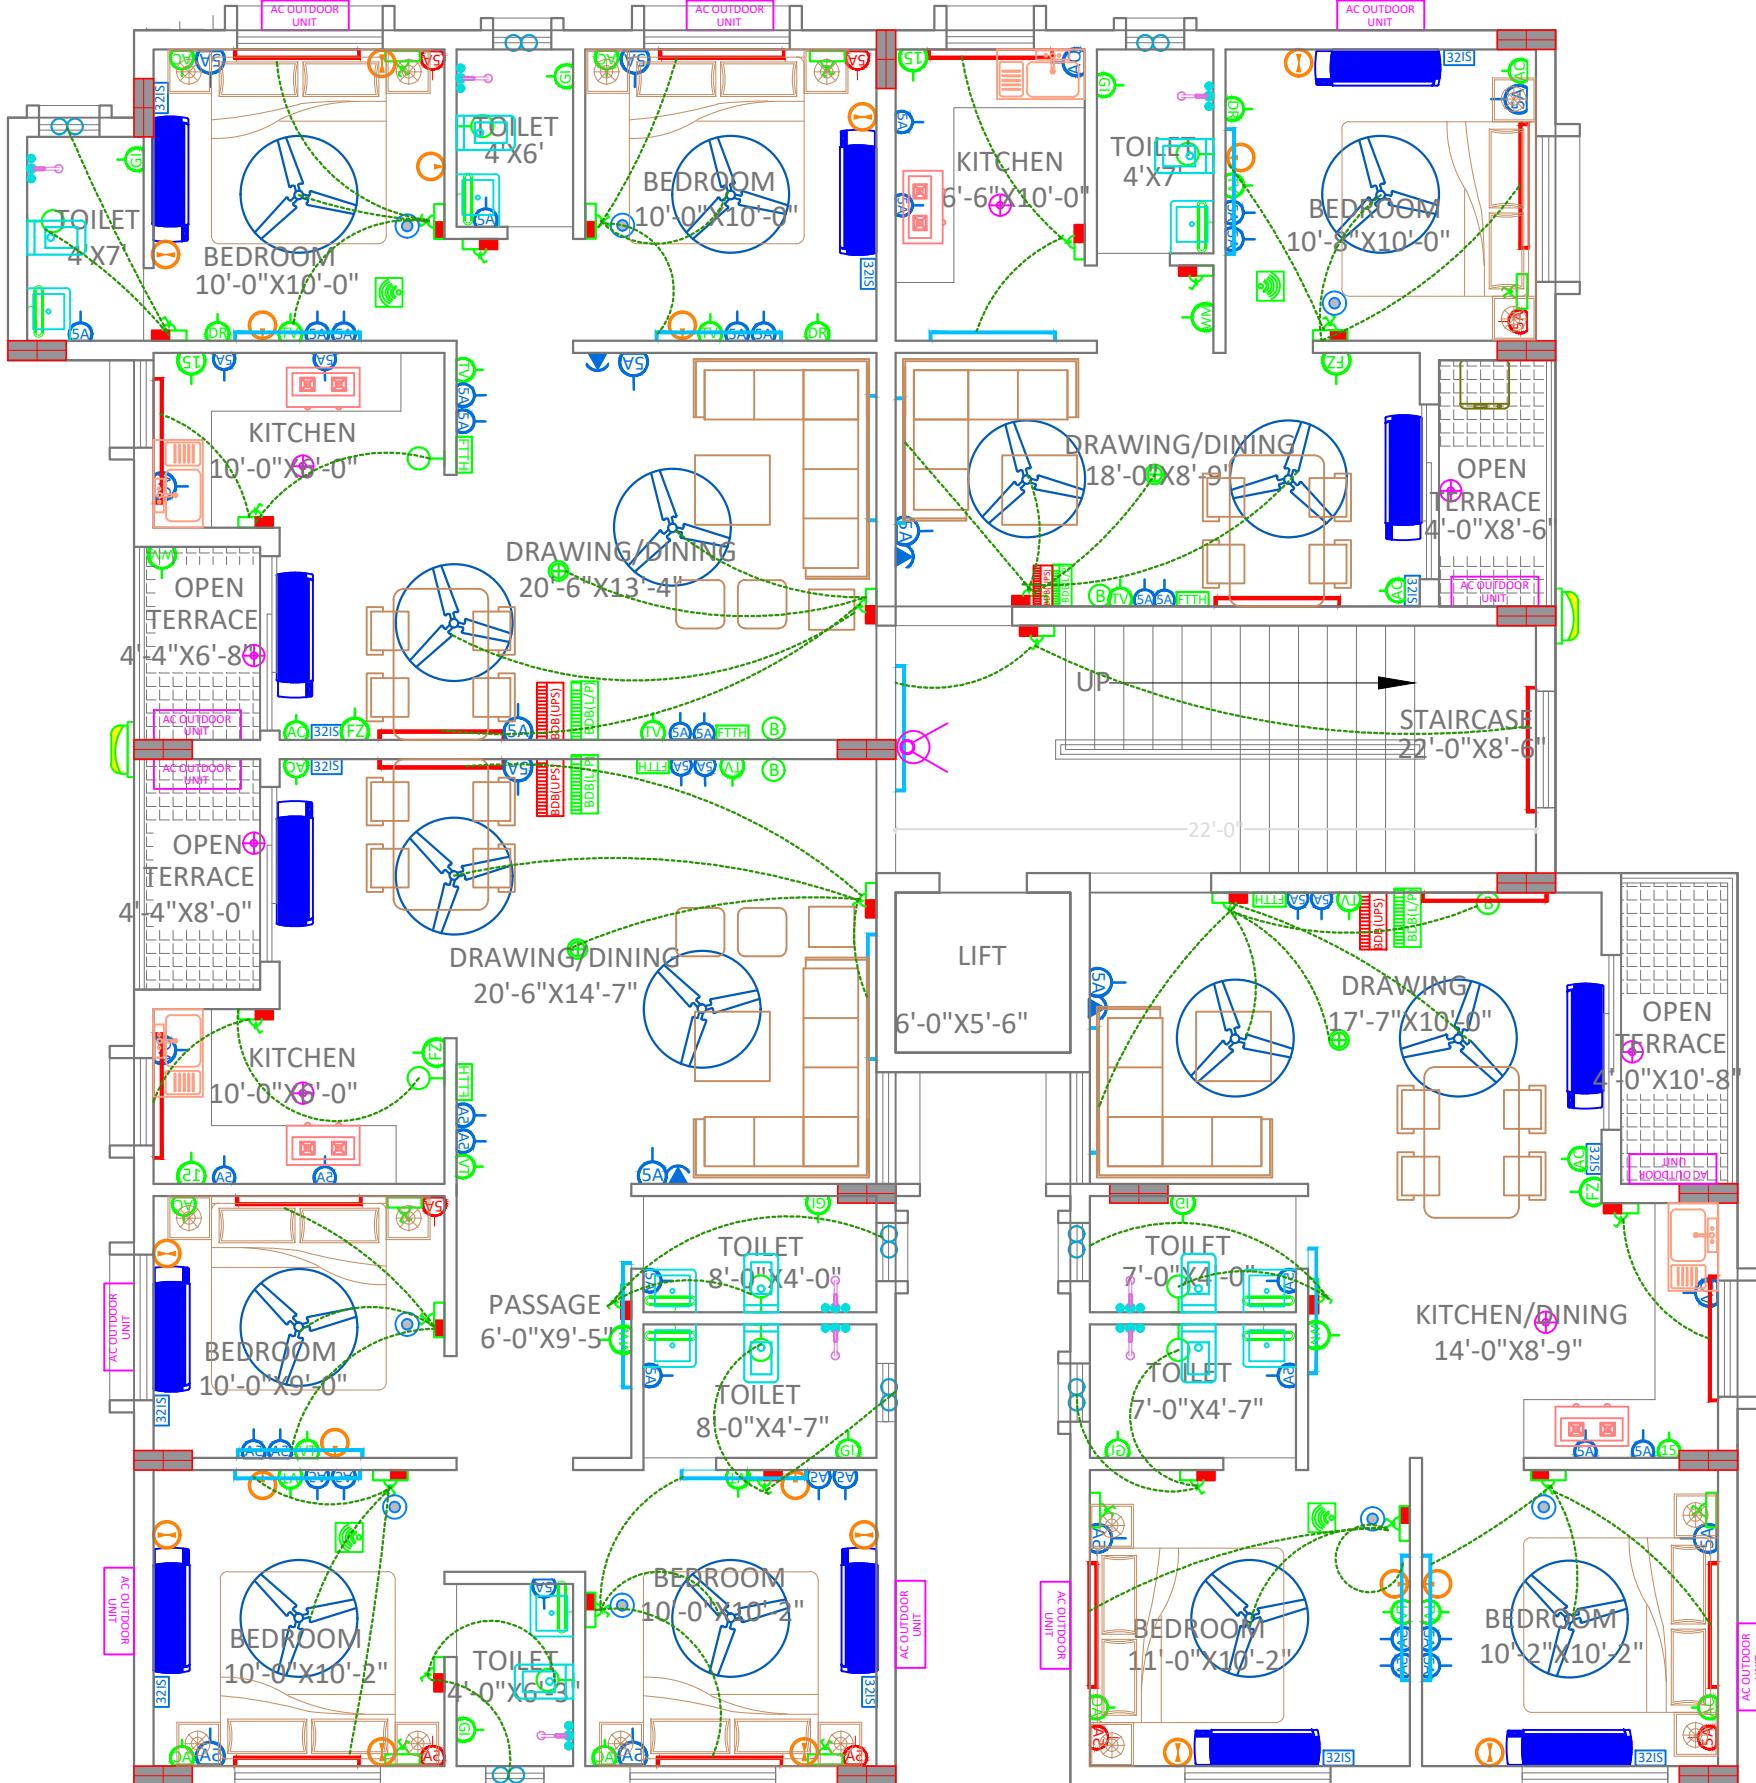LEGEND OF ELECTRICAL FITTINGS	
SL.	SPECIFICATION
01	1400mm Sweep Ceiling Fan
02	
03	20W Led Tube Light
04	20W Led Tube Light Surface Mounted (UPS)
05	380mm Sweep Exhaust Fan
06	TV Point
07	5Amps Switch + Plug Socket Outlet Only On Independent Board
08	15Amps Switch + Plug Socket Outlet Only On Independent Board
09	Electrical Panel
10	Branch Distribution Board Light
11	Branch Distribution Board Power
12	Branch Distribution Board Power (UPS)
13	32A Industrial Switch
14	32A Industrial Socket
15	18 watt LED Circular
16	Ceiling Rose
17	Split AC Indoor Unit
18	AC Outdoor Unit
19	Geyser Point
20	Telephone Point
21	Switch Board With UPS Supply
22	15 watt CFL Bulb (Wall Mounted)
23	Switch Board
24	Mirror Light
25	Aquaguard Water Purifier
26	Fridge
27	Calling Bell Switch
28	Calling Bell
29	Bullet Camera (Outdoor Camera)
30	Dome Camera (Indoor Camera)
31	20W Led Tube Light Ceiling Mounted
32	Electric Vehicle Charging Point
33	FTTH
34	Water Sensor Panel
35	Pump Panel
36	Inspection Chamber for Internet Cable
38	16 amps IP 67 Socket & Switch
39	Switch Board with UPS Powered
40	TV Antenna (MDU)
41	Dressing Unit
42	Foot Light
43	Shoe Polishing Machine
44	Sanitizer Machine
45	Solar Inverter
46	Lead Acid Battery
47	Weather Proof Outdoor light/ Facade Light
48	Junction Box
49	Switch Board with two way Switch
50	UPS power switch Board with two way switch

LEGEND

DESCRIPTION
WALL SIDE BELOW THE BEAM
WALL CENTRE BELOW THE BEAM



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- ANY DISCREPANCY IN THE DRAWING SHOULD BE BROUGHT TO THE KNOWLEDGE OF CONSULTANT BEFORE EXECUTION.
- REINFORCEMENT DESIGN FOR (G-3) FLOORS ONLY.
- CLEAR COVER TO MAIN REINFORCEMENT SHALL BE FOR COLUMN - 40MM, PLINTH BEAM - 30MM
- FOOTING-50mm, BEAM-25mm, SLAB - 20mm.
- THE MIX FOR ALL R.C.C. WORK SHALL BE M-20 (1:1.5:3).
- ALL THE REINFORCEMENT SHALL BE Fe-500(HSD BARS).
- MINIMUM DEVELOPMENT LENGTH FOR TOR STEEL SHALL BE 50d, WHERE "d" IS DIA OF MAIN REINFORCEMENT.
- THE LAP SHALL BE STAGGERED AND AVOIDED AT THE POINT OF MAXIMUM BENDING MOMENT.
- ALL DIMENSION & LEVEL ARE IN FEET-INCH.

SIGNATURE :-

DRAWN:- AR. DHANESHWARI

DESIGN:- ER. PABITRA

PROJECT TITLE:-

K.I.P SOUMYA

STATUS:

ISSUED FOR CONSTRUCTION

DATE: 04-05-2022

SCALE NTS

DWG NO: 45

DRAWING TITLE:-

4th FLOOR
ELECTRICAL
CIRCUIT LAYOUT



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BARMUNDA Bhubaneswar,
Pin- 751003
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STAMP/SIGNATURE :-



1ST TO 3RD FLOOR INTERNAL WATER SUPPLY

LEGENDS:-	
	100 MM Ø CI HOBELESS SW PIPE.
	100MM Ø UPVC SW PIPE.
	160MM Ø UPVC SW PIPE.
	GULLY TRAP CHAMBER.
	INSPECTION CHAMBER. (I.C.) (INSIDE SIZE = 760mm x 760mm x 460mm.)
	MANHOLE (MH1) (INSIDE SIZE = 900mm x 900mm x 900mm)
	MANHOLE (MH2) (INSIDE SIZE = 1200mm Ø)
	100Ø SOIL STACK
	100Ø WASTE STACK
	100mm Ø WASTE WATER HOBELESS PIPE INSIDE TOILET
	100mm Ø SOLID WASTE HOBELESS PIPE INSIDE TOILET
	CPVC WATER SUPPLY PIPE FOR ALL FIXTURE

LEGEND FOR SANITARY FITTINGS	
	EUROPEAN WATER CLOSET WITH CISTERNS (Cat No.92088(S30) Pastel color(Hindware) or Equivalent)
	(550x400)mm W.H.BASIN WITH PORCELAIN PEDESTAL (Parryware/Hindware/Neycer/Equivalent)
	Under Counter top basin (Hindware)Round Cat No.10065 Pastel color+spreader+dome waste. (Hindware OR Equivalent){Counter size (600x500)mm}
	600x450x250mm stainless steel kitchen sink with drain board (Jayana/Somany)
	CP SOAP HOLDER
	25MM X 600MM LONG CP TOWEL RAIL
	AQUA GUARD
	600MM X 450MM SIZE 5MM THICK DECORATIVE MIRROR
	600 X 125MM PLATE GLASS SHELF WITH CP GUARD RAILS
	15MM CP REVOLVING SHOWER WITH 15MM X 225MM LONG CP SHOWER ARM (OVER HEAD SHOWER, BIB COCK CONCEALED STOP COCK AT BATH AREA)
	125MM DIA CP GRATING WITH P-TRAP FLOOR GRATING P-TRAP
	15MM DIA CP HEALTH FAUCET (WITH 2 IN 1 BIB COCK NEAR EUROPEAN WC)
	15MM DIA CP ANGLE STOP COCK (FOR WATER SUPPLY INLET TO WC, WASH BASIN)
	ABLUTION TAP (CP BIB COCK)

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- ANY DISCREPANCY IN THE DRAWING SHOULD BE BROUGHT TO THE KNOWLEDGE OF CONSULTANT BEFORE EXECUTION.
- ALL THE DRAWINGS ARE FOR G+3 FLOORS ONLY.
- CLEAR COVER TO MAIN REINFORCEMENT SHALL BE FOR COLUMN - 40MM, PLINTH BEAM - 30MM.
- FOOTING-50mm, BEAM-25mm, SLAB - 20mm .
- THE MIX FOR ALL R.C.C. WORK SHALL BE M-20 (1:1.5:3) .
- ALL THE REINFORCEMENT SHALL BE Fe-500(HSD BARS).
- MINIMUM DEVELOPMENT LENGTH FOR TOR STEEL SHALL BE 50d, WHERE "d" IS DIA OF MAIN REINFORCEMENT.
- THE LAP SHALL BE STAGGERED AND AVOIDED AT THE POINT OF MAXIMUM BENDING MOMENT .
- ALL DIMENSION & LEVEL ARE IN FEET-INCH.

SIGNATURE :-

DRAWN:- AR. DHANESHWARI

DESIGN:- ER. PABITRA

PROJECT TITLE:-

K.I.P SOUMYA

STATUS:

ISSUED FOR CONSTRUCTION

DATE: 07-05-2022

SCALE NTS

DWG NO: 46


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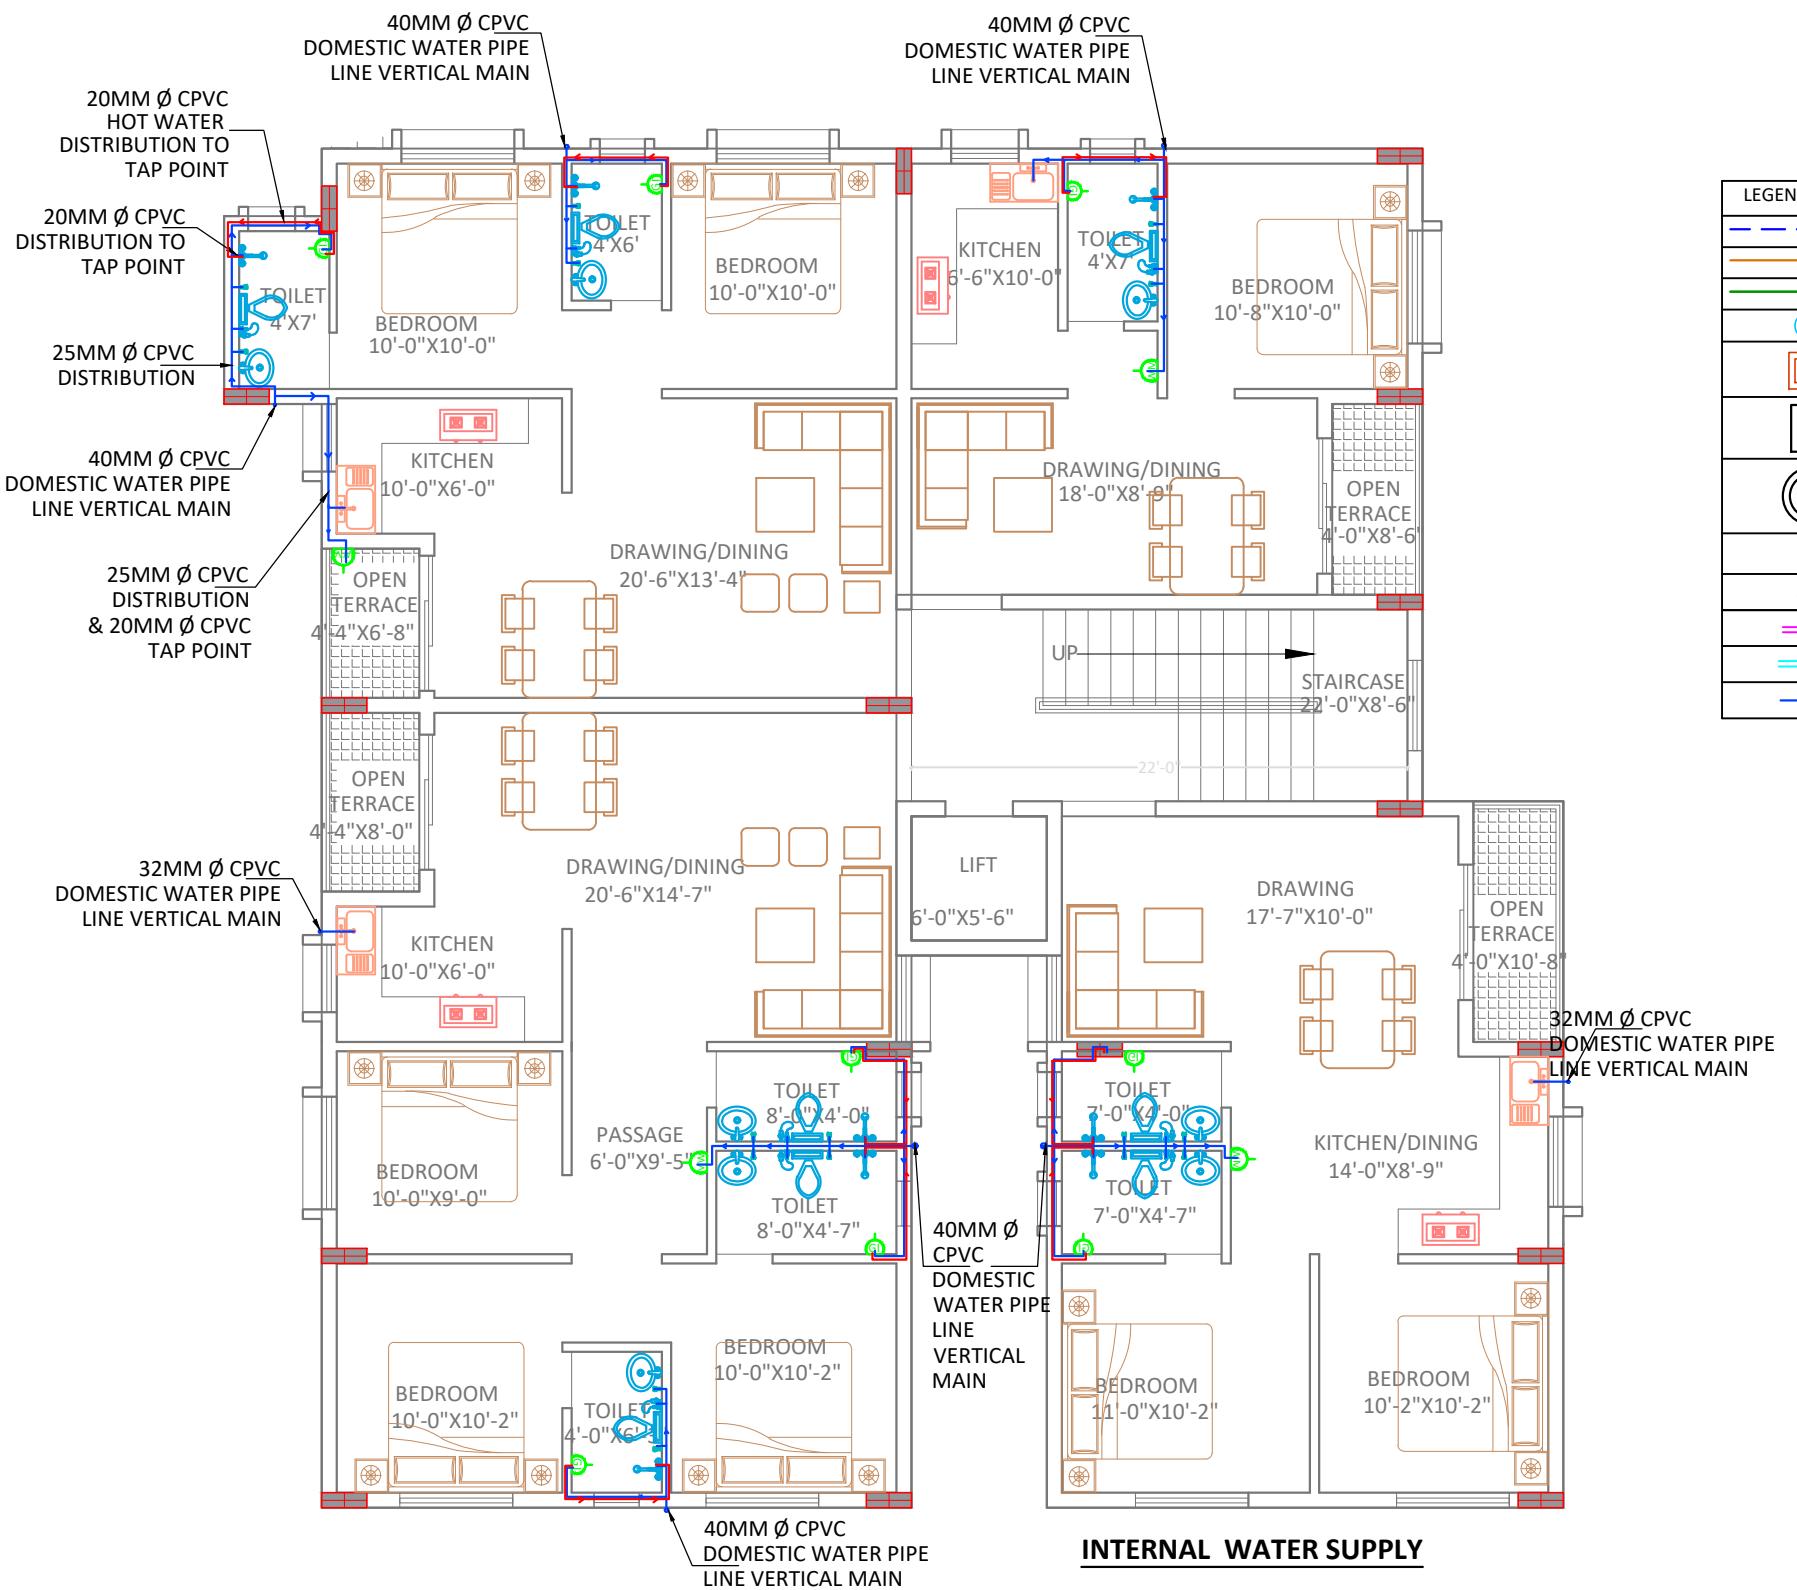
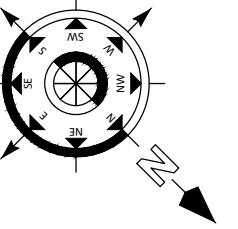
**1ST TO 3RD
FLOOR INTERNAL
WATER SUPPLY**



APS DESIGN INFRA PVT. LTD
B/48, BDA DUPLEX COLONY
BARMUNDA Bhubaneswar,
Pin- 751003
8 6 5 8 6 7 7 4 2 5
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STAMP/SIGNATURE :-



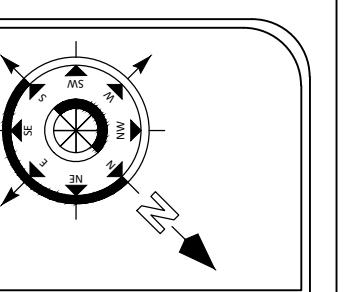

4TH FLOOR INTERNAL WATER SUPPLY

LEGENDS:-	
	100 MM Ø CI HOBELESS SW PIPE.
	100MM Ø UPVC SW PIPE.
	160MM Ø UPVC SW PIPE.
	GULLY TRAP CHAMBER.
	INSPECTION CHAMBER. (I.C.) (INSIDE SIZE = 760mm x 760mm x 460mm.)
	MANHOLE (MH1) (INSIDE SIZE = 900mm x 900mm x 900mm)
	MANHOLE (MH2) (INSIDE SIZE = 1200mm Ø)
	100Ø SOIL STACK
	100Ø WASTE STACK
	100mm Ø WASTE WATER HOBELESS PIPE INSIDE TOILET
	100mm Ø SOLID WASTE HOBELESS PIPE INSIDE TOILET
	CPVC WATER SUPPLY PIPE FOR ALL FIXTURE

LEGEND FOR SANITARY FITTINGS	
	EUROPEAN WATER CLOSET WITH CISTERN (Cat No.92088(S30) Pastel color(Hindware) or Equivalent)
	(550x400)mm W.H.BASIN WITH PORCELAIN PEDESTAL (Parryware/Hindware/Neycer/Equivalent)
	Under Counter top basin (Hindware)Round Cat No.10065 Pastel color+spreader+dome waste. (Hindware OR Equivalent)(Counter size (600x500)mm)
	600x450x250mm stainless steel kitchen sink with drain board(Jayana/Somany)
	CP SOAP HOLDER
	25MM X 600MM LONG CP TOWEL RAIL
	AQUA GUARD
	600MM X 450MM SIZE 5MM THICK DECORATIVE MIRROR
	600 X 125MM PLATE GLASS SHELF WITH CP GUARD RAILS
	15MM CP REVOLVING SHOWER WITH 15MM X 225MM LONG CP SHOWER ARM (OVER HEAD SHOWER, BIB COCK CONCEALED STOP COCK AT BATH AREA)
	125MM DIA CP GRATING WITH P-TRAP FLOOR GRATING P-TRAP
	15MM DIA CP HEALTH FAUCET (WITH 2IN 1 BIB COCK NEAR EUROPEAN WC)
	15MM DIA CP ANGLE STOP COCK (FOR WATER SUPPLY INLET TO WC, WASH BASIN)
	ABLUTION TAP (CP BIB COCK)

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- ANY DISCREPANCY IN THE DRAWING SHOULD BE BROUGHT TO THE KNOWLEDGE OF CONSULTANT BEFORE EXECUTION.
- STAIRS ARE NOT DRAWN FOR (G-3) FLOORS ONLY.
- CLEAR COVER TO MAIN REINFORCEMENT SHALL BE FOR COLUMN - 40MM, PLINTH BEAM - 30MM
- FOOTING-50mm, BEAM-25mm, SLAB - 20mm .
- THE MIX FOR ALL R.C.C. WORK SHALL BE M-20 (1:1.5:3) .
- ALL THE REINFORCEMENT SHALL BE Fe-500(HSD BARS).
- MINIMUM DEVELOPMENT LENGTH FOR TOR STEEL SHALL BE 50d, WHERE "d" IS DIA OF MAIN REINFORCEMENT.
- THE LAP SHALL BE STAGGERED AND AVOIDED AT THE POINT OF MAXIMUM BENDING MOMENT .
- ALL DIMENSION & LEVEL ARE IN FEET-INCH .

SIGNATURE :-

DRAWN:- AR. DHANESHWARI
DESIGN:- ER. PABITRA

PROJECT TITLE:-

K.I.P SOUMYA


STATUS:
ISSUED FOR CONSTRUCTION

DATE: 07-05-2022
SCALE NTS
DWG NO: 47


DRAWING TITLE:-
**4TH FLOOR
INTERNAL
WATER SUPPLY**

APS DESIGN INFRA PVT. LTD
B/48, BDA DUPLEX COLONY
BARMUNDA Bhubaneswar,
Pin- 751003
8 6 5 8 6 7 7 4 2 5
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STAMP/SIGNATURE :-

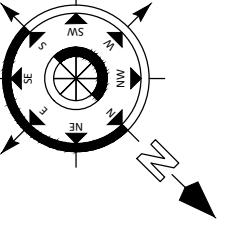

EXTERNAL WATER SUPPLY SYSTEM AT TERRACE FLOOR PLAN

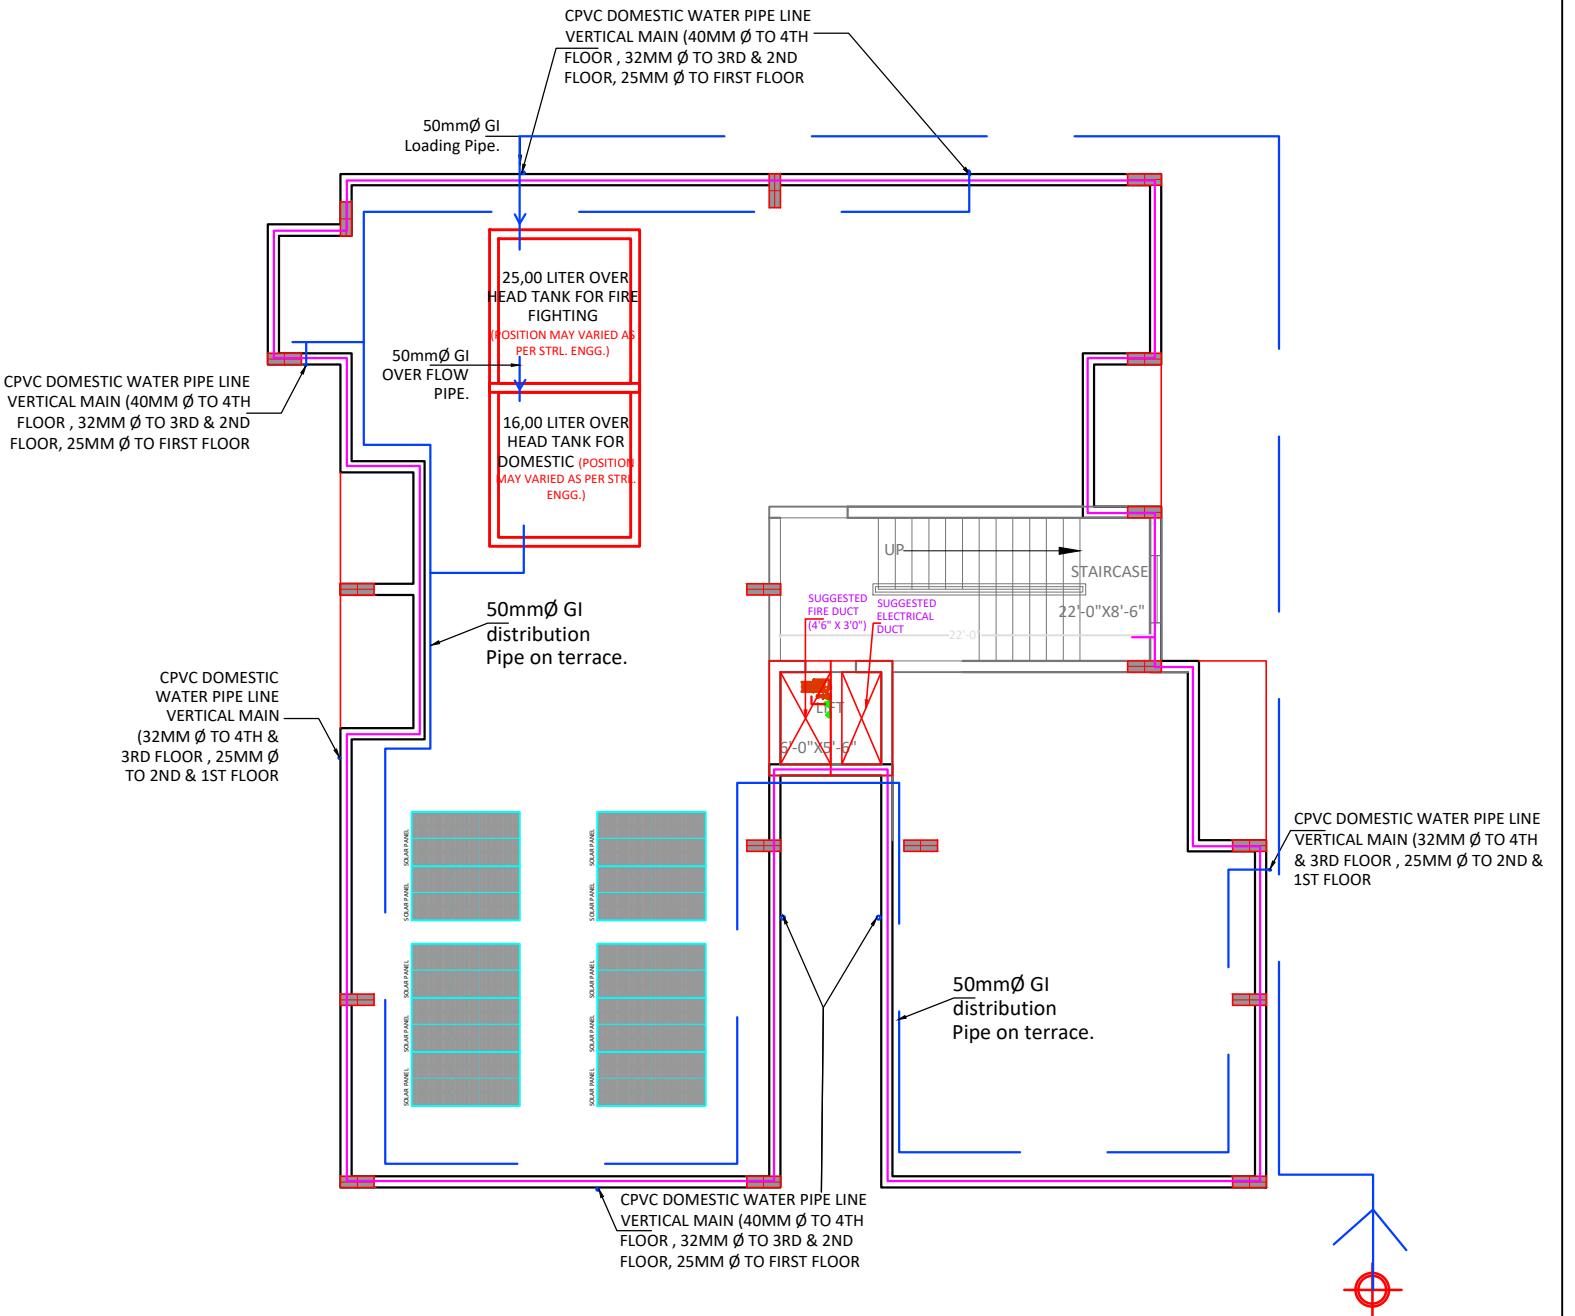

LEGENDS:-

	100 MM Ø CI HOBELESS SW PIPE.
	100MM Ø UPVC SW PIPE.
	160MM Ø UPVC SW PIPE.
	GULLY TRAP CHAMBER.
	INSPECTION CHAMBER. (I.C.) (INSIDE SIZE = 760mm x 760mm x 460mm.)
	MANHOLE (MH1) (INSIDE SIZE = 900mm x 900mm x 900mm)
	MANHOLE (MH2) (INSIDE SIZE = 1200mm Ø)
	100Ø SOIL STACK
	100Ø WASTE STACK
	100mm Ø WASTE WATER HOBELESS PIPE INSIDE TOILET
	100mm Ø SOLID WASTE HOBELESS PIPE INSIDE TOILET
	CPVC WATER SUPPLY PIPE FOR ALL FIXTURE

LEGEND FOR SANITARY FITTINGS

	EUROPEAN WATER CLOSET WITH CISTERN (Cat No.92088(S30) Pastel color(Hindware) or Equivalent)
	(550x400)mm W.H.BASIN WITH PORCELAIN PEDESTAL (Parryware/Hindware/Neycer/Equivalent)
	Under Counter top basin (Hindware)Round Cat No.10065 Pastel color+spreader+dome waste. (Hindware OR Equivalent){Counter size (600x500)mm}
	600x450x250mm stainless steel kitchen sink with drain board (Jayana/Somany)
	CP SOAP HOLDER
	25MM X 600MM LONG CP TOWEL RAIL
	AQUA GUARD
	600MM X 450MM SIZE 5MM THICK DECORATIVE MIRROR
	600 X 125MM PLATE GLASS SHELF WITH CP GUARD RAILS
	15MM CP REVOLVING SHOWER WITH 15MM X 225MM LONG CP SHOWER ARM (OVER HEAD SHOWER, BIB COCK CONCEALED STOP COCK AT BATH AREA)
	125MM DIA CP GRATING WITH P-TRAP FLOOR GRATING P-TRAP
	15MM DIA CP HEALTH FAUCET (WITH 2 IN 1 BIB COCK NEAR EUROPEAN WC)
	15MM DIA CP ANGLE STOP COCK (FOR WATER SUPPLY INLET TO WC, WASH BASIN)
	ABLUTION TAP (CP BIB COCK)

Note:

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- THIS DRAWING SHOULD BE READ IN CONJUNCTION WITH RELEVANT ARCHITECTURAL DRAWINGS AND SITE CONDITIONS.
- ANY DISCREPANCY IN THE DRAWING SHOULD BE BROUGHT TO THE KNOWLEDGE OF CONSULTANT BEFORE EXECUTION.
- ALL THE DESIGNATION FOR (G-3) FLOORS ONLY.
- CLEAR COVER TO MAIN REINFORCEMENT SHALL BE FOR COLUMN - 40MM, PLINTH BEAM - 30MM.
- FOOTING-50mm, BEAM-25mm, SLAB - 20mm .
- THE MIX FOR ALL R.C.C. WORK SHALL BE M-20 (1:1.5:3).
- ALL THE REINFORCEMENT SHALL BE Fe-500(HSD BARS).
- MINIMUM DEVELOPMENT LENGTH FOR TOR STEEL SHALL BE 50d, WHERE "d" IS DIA OF MAIN REINFORCEMENT.
- THE LAP SHALL BE STAGGERED AND AVOIDED AT THE POINT OF MAXIMUM BENDING MOMENT.
- ALL DIMENSION & LEVEL ARE IN FEET-INCH.

SIGNATURE :-

DRAWN:- AR. DHANESHWARI

DESIGN:- ER. PABITRA

PROJECT TITLE:-

K.I.P SOUMYA

STATUS:

ISSUED FOR CONSTRUCTION

DATE: 07-05-2022

SCALE NTS

DWG NO: 48

DRAWING TITLE:-


TERRACE FLOOR PLAN



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BARMUNDA Bhubaneswar,
Pin- 751003
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LEGEND FOR SANITARY FITTINGS	
	EUROPEAN WATER CLOSET WITH CISTERN (Cat No.92088(S30) Pastel color(Hindware) or Equivalent)
	(550x400)mm W.H.BASIN WITH PORCELAIN PEDESTAL (Parryware/Hindware/Neycer/Equivalent)
	Under Counter top basin (Hindware)Round Cat No.10065 Pastel color+spreader+dome waste. (Hindware OR Equivalent){Counter size (600x500)mm}
	600x450x250mm stainless steel kitchen sink with drain board(Jayana/Somany)
	CP SOAP HOLDER
	25MM X 600MM LONG CP TOWEL RAIL
	AQUA GUARD
	600MM X 450MM SIZE 5MM THICK DECORATIVE MIRROR
	600 X 125MM PLATE GLASS SHELF WITH CP GUARD RAILS
	15MM CP REVOLVING SHOWER WITH 15MM X 225MM LONG CP SHOWER ARM (OVER HEAD SHOWER, BIB COCK CONCEALED STOP COCK AT BATH AREA)
	125MM DIA CP GRATING WITH P-TRAP FLOOR GRATING P-TRAP
	15MM DIA CP HEALTH FAUCET (WITH 2IN 1 BIB COCK NEAR EUROPEAN WC)
	15MM DIA CP ANGLE STOP COCK (FOR WATER SUPPLY INLET TO WC, WASH BASIN)
	ABLUTION TAP (CP BIB COCK)

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- ALL THE DRAWINGS ARE FOR (G-3) FLOORS ONLY.
- CLEAR COVER TO MAIN REINFORCEMENT SHALL BE FOR COLUMN - 40MM, PLINTH BEAM - 30MM
- FOOTING-50mm, BEAM-25mm, SLAB - 20mm .
- THE MIX FOR ALL R.C.C. WORK SHALL BE M-20 (1:1.5:3).
- ALL THE REINFORCEMENT SHALL BE Fe-500(HSD BARS).
- MINIMUM DEVELOPMENT LENGTH FOR TOR STEEL SHALL BE 50d, WHERE 'd' IS DIA OF MAIN REINFORCEMENT.
- THE LAP SHALL BE STAGGERED AND AVOIDED AT THE POINT OF MAXIMUM BENDING MOMENT .
- ALL DIMENSION & LEVEL ARE IN FEET-INCH.

SIGNATURE :-

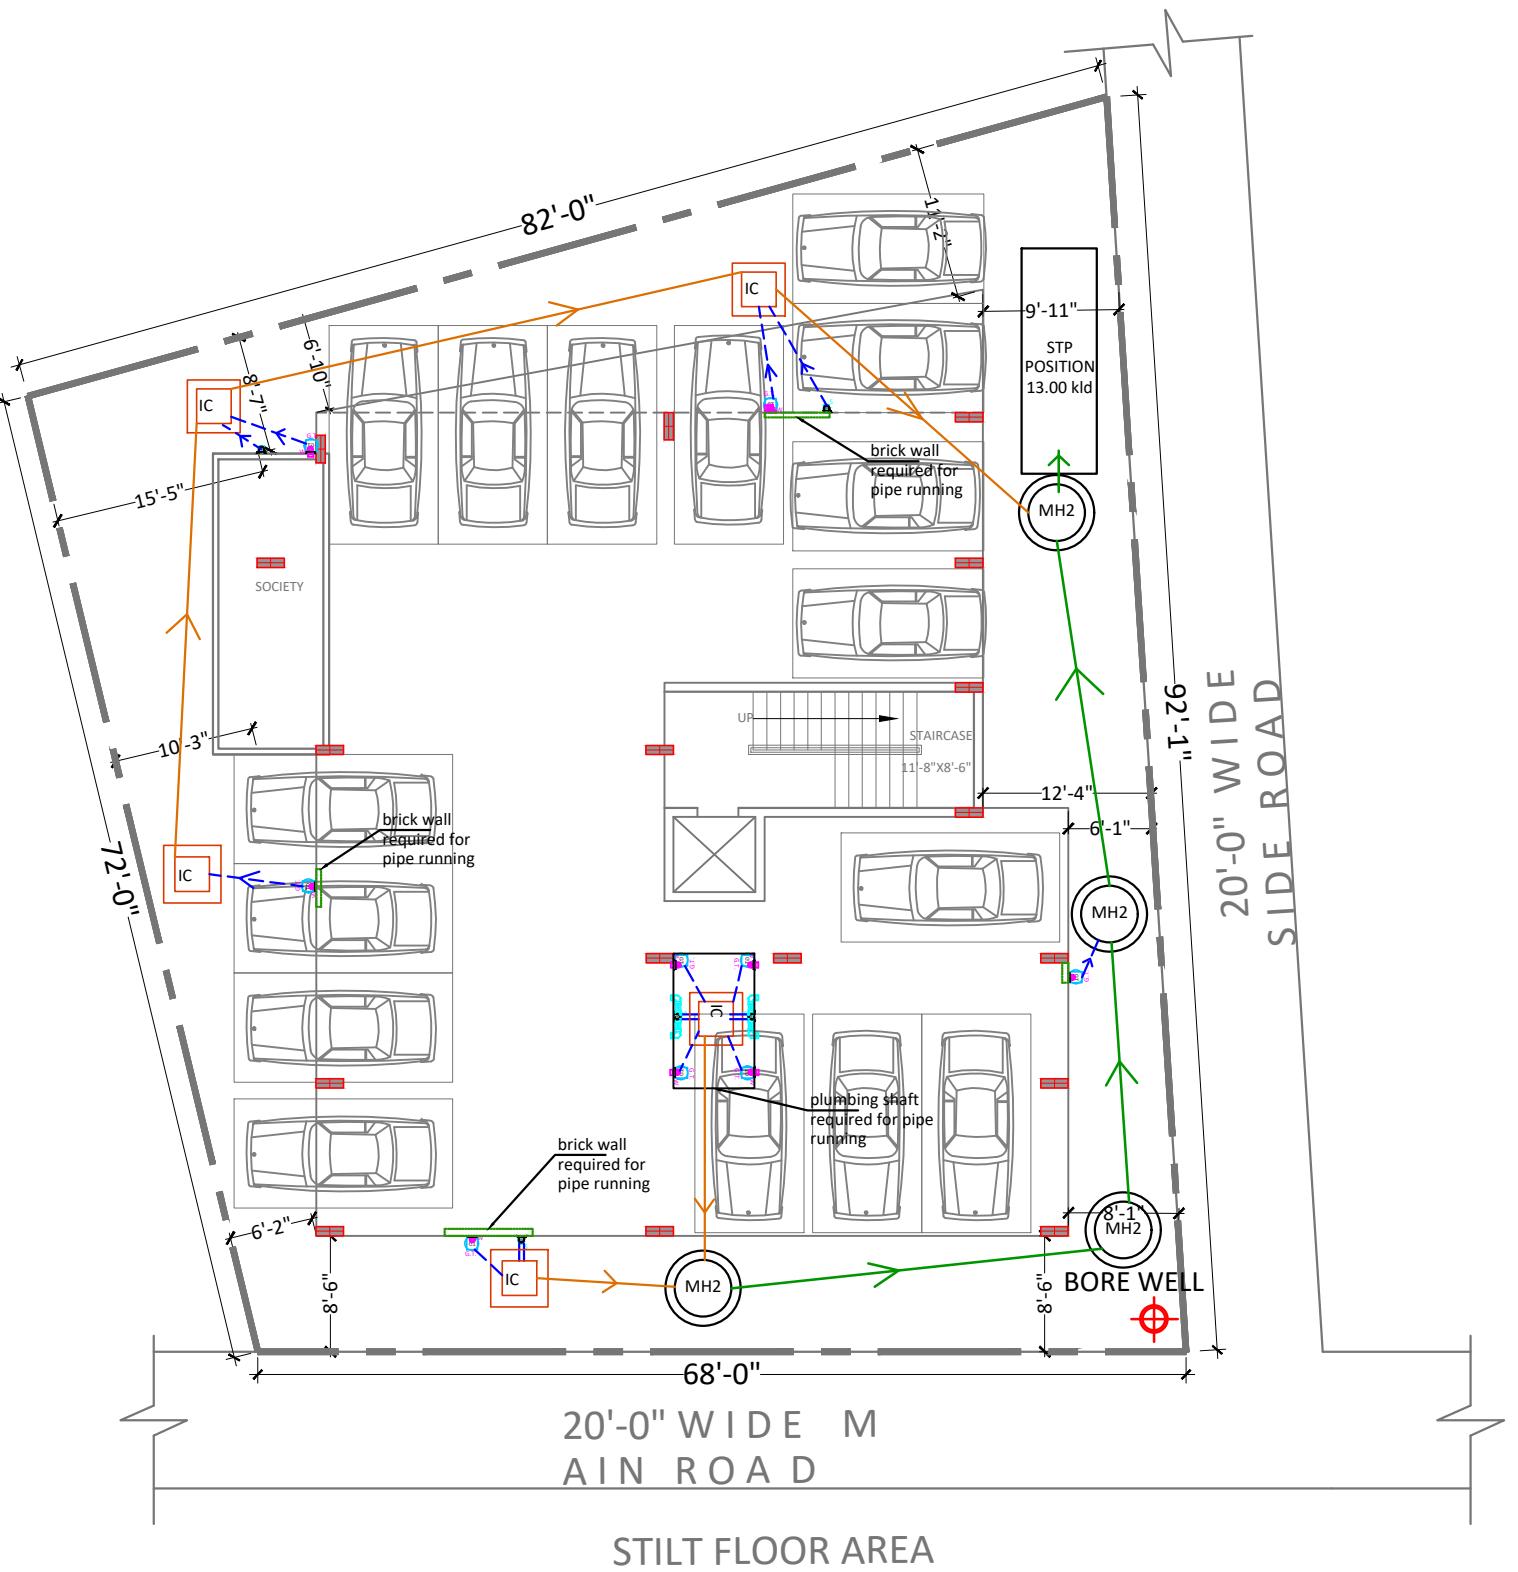DRAWN:- AR. DHANESHWARI
DESIGN:- ER. PABITRA

PROJECT TITLE:-

K.I.P SOUMYA

STATUS:
ISSUED FOR CONSTRUCTION

DATE: 07-05-2022
SCALE NTS
DWG NO: 49

DRAWING TITLE:-
STILT FLOOR AREA

APS DESIGN INFRA PVT. LTD
B/48, BDA DUPLEX COLONY
BARMUNDA Bhubaneswar,
Pin- 751003
8 6 5 8 6 7 7 4 2 5
info@apsdesigninfra.com
www.apsdesigninfra.com

STAMP/SIGNATURE :-



1ST TO 3RD FLOOR INTERNAL SEWERAGE

LEGENDS:-	
	100 MM Ø CI HOBELESS SW PIPE.
	100MM Ø UPVC SW PIPE.
	160MM Ø UPVC SW PIPE.
	GULLY TRAP CHAMBER.
	INSPECTION CHAMBER. (I.C.) (INSIDE SIZE = 760mm x 760mm x 460mm.)
	MANHOLE (MH1) (INSIDE SIZE = 900mm x 900mm x 900mm)
	MANHOLE (MH2) (INSIDE SIZE = 1200mm Ø)
	100Ø SOIL STACK
	100Ø WASTE STACK
	100mm Ø WASTE WATER HOBELESS PIPE INSIDE TOILET
	100mm Ø SOLID WASTE HOBELESS PIPE INSIDE TOILET
	CPVC WATER SUPPLY PIPE FOR ALL FIXTURE

LEGEND FOR SANITARY FITTINGS	
	EUROPEAN WATER CLOSET WITH CISTERN (Cat No.92088(S30) Pastel color(Hindware) or Equivalent)
	(550x400)mm W.H.BASIN WITH PORCELAIN PEDESTAL (Parryware/Hindware/Neycer/Equivalent)
	Under Counter top basin (Hindware)Round Cat No.10065 Pastel color+spreader+dome waste. (Hindware OR Equivalent){Counter size (600x500)mm}
	600x450x250mm stainless steel kitchen sink with drain board (Jayana/Somany)
	CP SOAP HOLDER
	25MM X 600MM LONG CP TOWEL RAIL
	AQUA GUARD
	600MM X 450MM SIZE 5MM THICK DECORATIVE MIRROR
	600 X 125MM PLATE GLASS SHELF WITH CP GUARD RAILS
	15MM CP REVOLVING SHOWER WITH 15MM X 225MM LONG CP SHOWER ARM (OVER HEAD SHOWER, BIB COCK CONCEALED STOP COCK AT BATH AREA)
	125MM DIA CP GRATING WITH P-TRAP FLOOR GRATING P-TRAP
	15MM DIA CP HEALTH FAUCET (WITH 2 IN 1 BIB COCK NEAR EUROPEAN WC)
	15MM DIA CP ANGLE STOP COCK (FOR WATER SUPPLY INLET TO WC, WASH BASIN)
	ABLUTION TAP (CP BIB COCK)

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- ALL THE REINFORCEMENT SHALL BE Fe-500(HSD BARS).
- MINIMUM DEVELOPMENT LENGTH FOR TOR STEEL SHALL BE 50d, WHERE "d" IS DIAMETER OF MAIN REINFORCEMENT.
- THE LAP SHALL BE STAGGERED AND AVOIDED AT THE POINT OF MAXIMUM BENDING MOMENT .
- ALL DIMENSION & LEVEL ARE IN FEET-INCH .

SIGNATURE :-

DRAWN:- AR. DHANESHWARI
DESIGN:- ER. PABITRA

PROJECT TITLE:-

K.I.P SOUMYA


STATUS:
ISSUED FOR CONSTRUCTION


DATE: 07-05-2022
SCALE NTS
DWG NO: 50

DRAWING TITLE:-
**INTERNAL
SEWERAGE**

APS DESIGN INFRA PVT. LTD
B/48, BDA DUPLEX COLONY
BARMUNDA Bhubaneswar,
Pin- 751003
8 6 5 8 6 7 7 4 2 5
info@apsdesigninfra.com
www.apsdesigninfra.com

STAMP/SIGNATURE :-

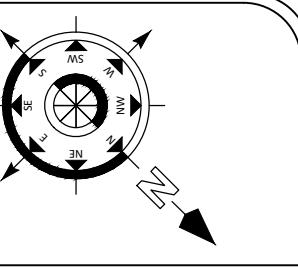


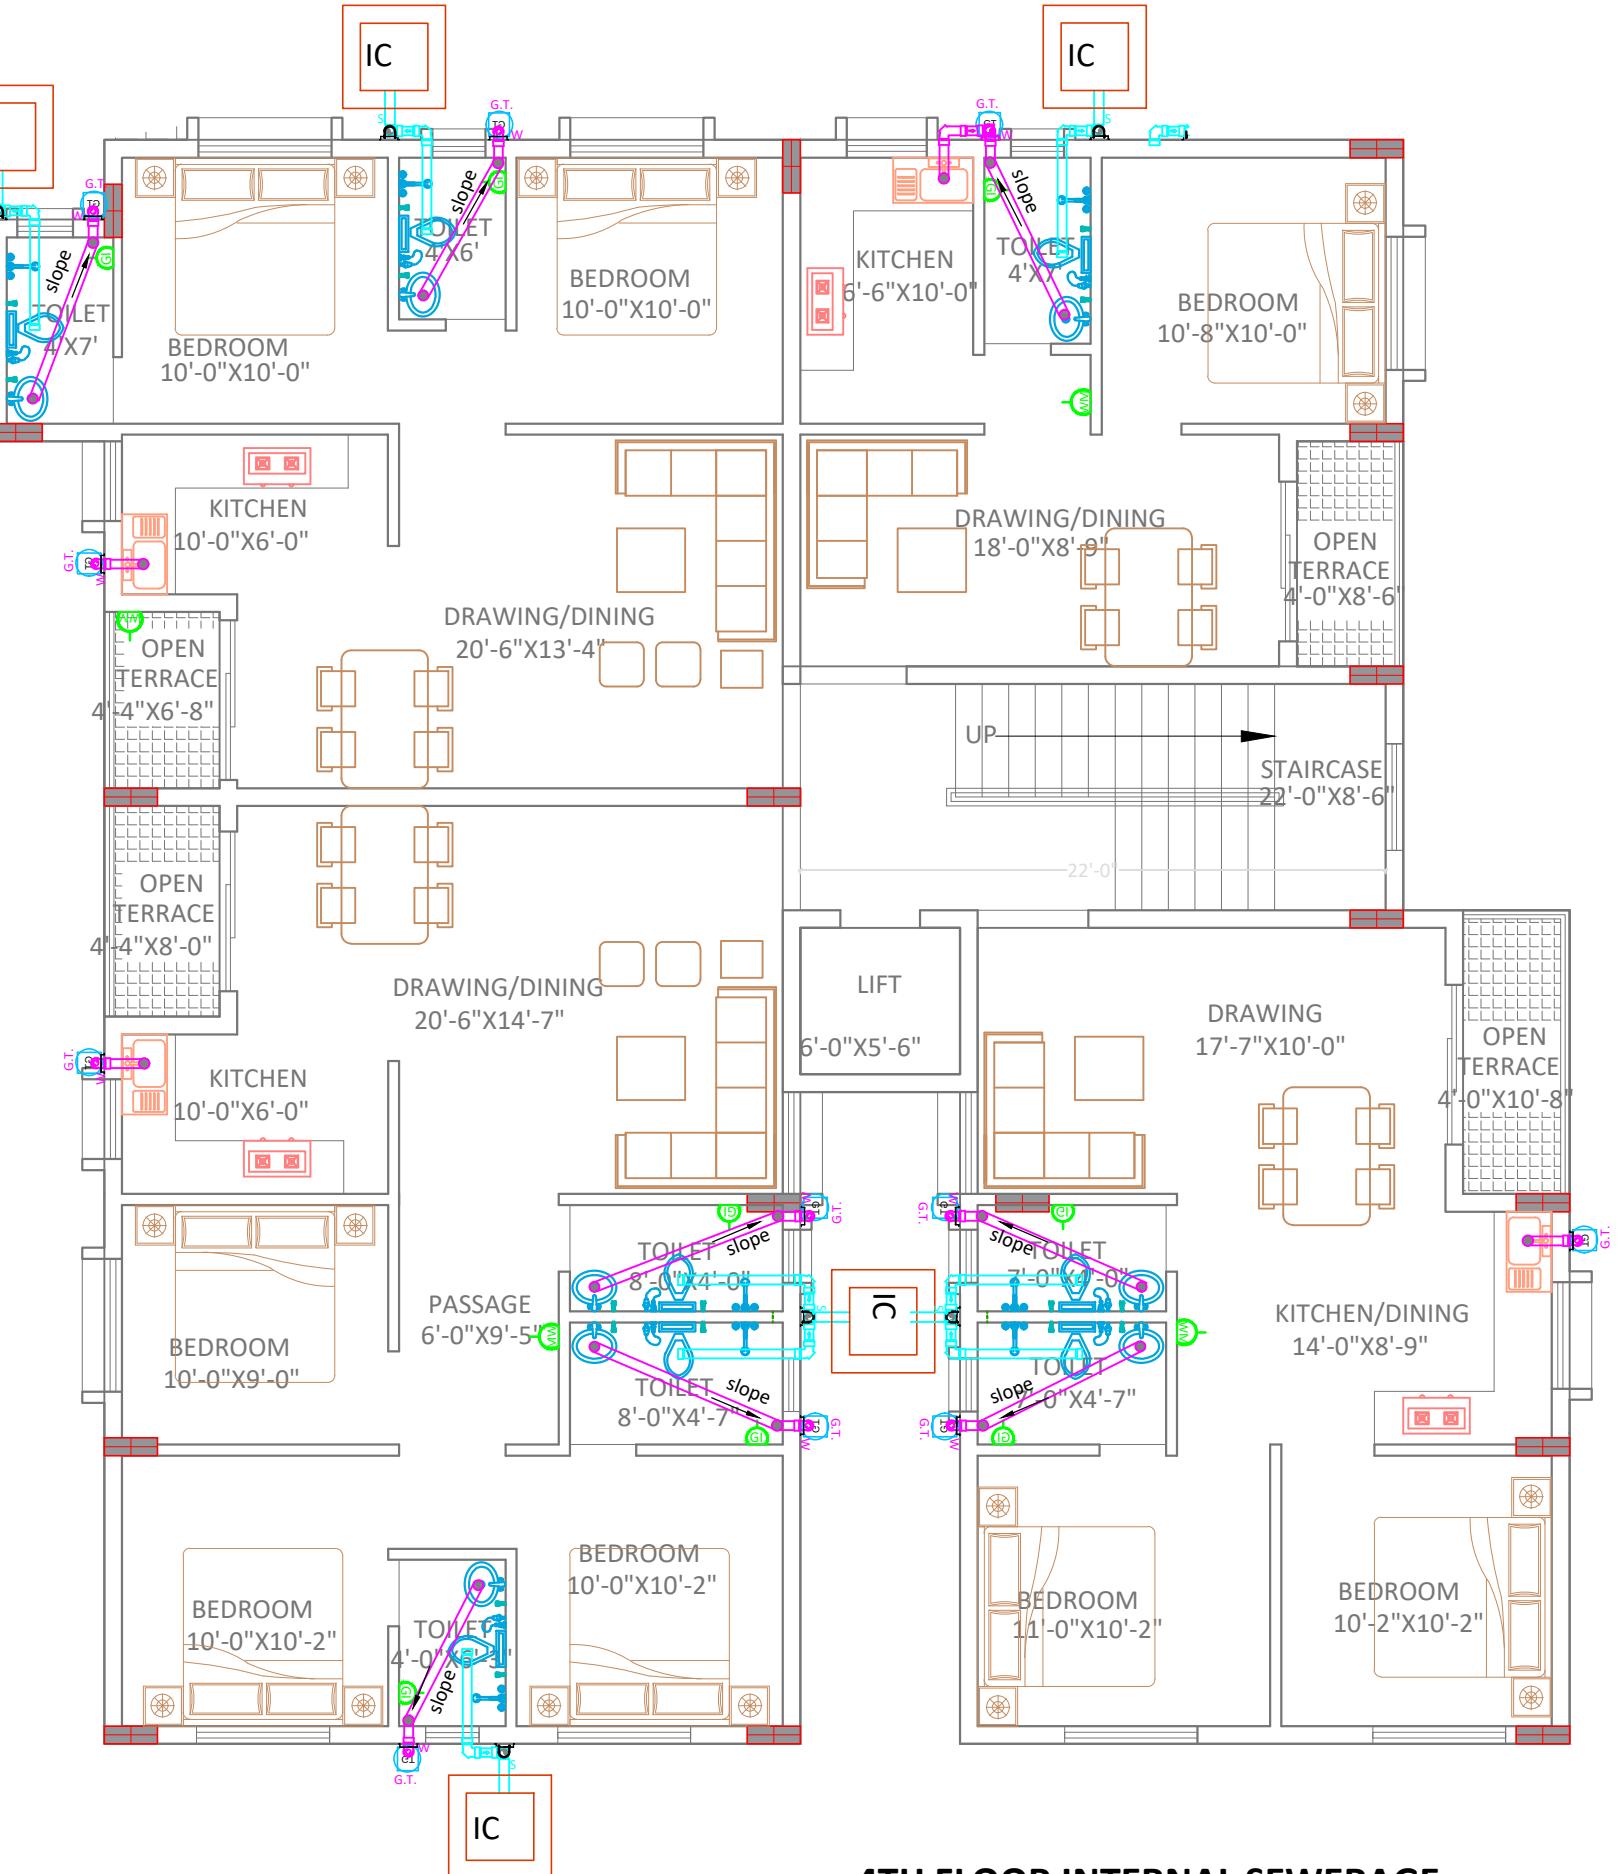

NOTE:-
ALL ATTACHED TOILET = +6" RAISED FLOOR FOR PLUMBING PIPE RUNNING

LEGENDS:-	
—>—	100 MM Ø CI HOBELESS SW PIPE.
—>—	100MM Ø UPVC SW PIPE.
—>—	160MM Ø UPVC SW PIPE.
GT	GULLY TRAP CHAMBER.
IC	INSPECTION CHAMBER. (I.C.) (INSIDE SIZE = 760mm x 760mm x 460mm.)
MH1	MANHOLE (MH1) (INSIDE SIZE = 900mm x 900mm x 900mm)
MH2	MANHOLE (MH2) (INSIDE SIZE = 1200mm Ø)
S	100Ø SOIL STACK
W	100Ø WASTE STACK
—	100mm Ø WASTE WATER HOBELESS PIPE INSIDE TOILET
—	100mm Ø SOLID WASTE HOBELESS PIPE INSIDE TOILET
—	CPVC WATER SUPPLY PIPE FOR ALL FIXTURE

LEGEND FOR SANITARY FITTINGS	
WC	EUROPEAN WATER CLOSET WITH CISTERNS (Cat No.92088(S30) Pastel color(Hindware) or Equivalent)
WB	(550x400)mm W.H.BASIN WITH PORCELAIN PEDESTAL (Parryware/Hindware/Neycer/Equivalent)
UCB	Under Counter top basin (Hindware)Round Cat No.10065 Pastel color+spreader+dome waste. (Hindware OR Equivalent){Counter size (600x500)mm}
KS	600x450x250mm stainless steel kitchen sink with drain board (Jayana/Somany)
CSH	CP SOAP HOLDER
Towel Rail	25MM X 600MM LONG CP TOWEL RAIL
AQ	AQUA GUARD
M	600MM X 450MM SIZE 5MM THICK DECORATIVE MIRROR
GS	600 X 125MM PLATE GLASS SHELF WITH CP GUARD RAILS
RS	15MM CP REVOLVING SHOWER WITH 15MM X 225MM LONG CP SHOWER ARM (OVER HEAD SHOWER, BIB COCK CONCEALED STOP COCK AT BATH AREA)
Floor Grating	125MM DIA CP GRATING WITH P-TRAP FLOOR GRATING P-TRAP
HF	15MM DIA CP HEALTH FAUCET (WITH 2 IN 1 BIB COCK NEAR EUROPEAN WC)
ASC	15MM DIA CP ANGLE STOP COCK (FOR WATER SUPPLY INLET TO WC, WASH BASIN)
AT	ABLUTION TAP (CP BIB COCK)

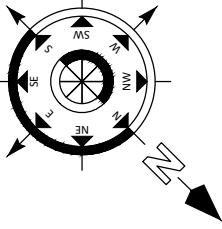

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• MINIMUM DEVELOPMENT LENGTH FOR TOR STEEL SHALL BE 50d, WHERE "d" IS DIA OF MAIN REINFORCEMENT.
• THE LAP SHALL BE STAGGERED AND AVOIDED AT THE POINT OF MAXIMUM BENDING MOMENT .
• ALL DIMENSION & LEVEL ARE IN FEET-INCH.

SIGNATURE :-

DRAWN:- AR. DHANESHWARI

DESIGN:- ER. PABITRA

PROJECT TITLE:-

K.I.P SOUMYA

STATUS:

ISSUED FOR CONSTRUCTION

DATE: 07-05-2022

SCALE NTS

DWG NO: 51






DRAWING TITLE:-

**4TH FLOOR
INTERNAL
SEWERAGE**






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BARMUNDA Bhubaneswar,
Pin- 751003
8 6 5 8 6 7 7 4 2 5
info@apsdesigninfra.com
www.apsdesigninfra.com

STAMP/SIGNATURE :-

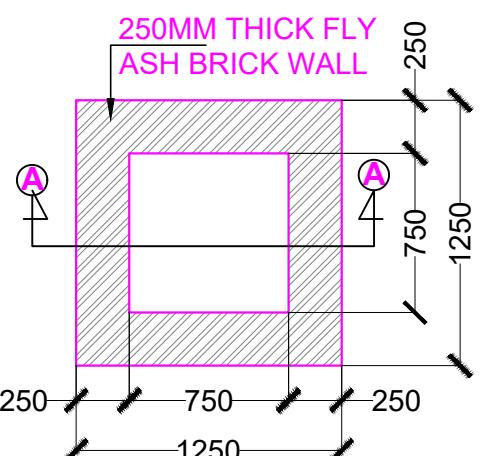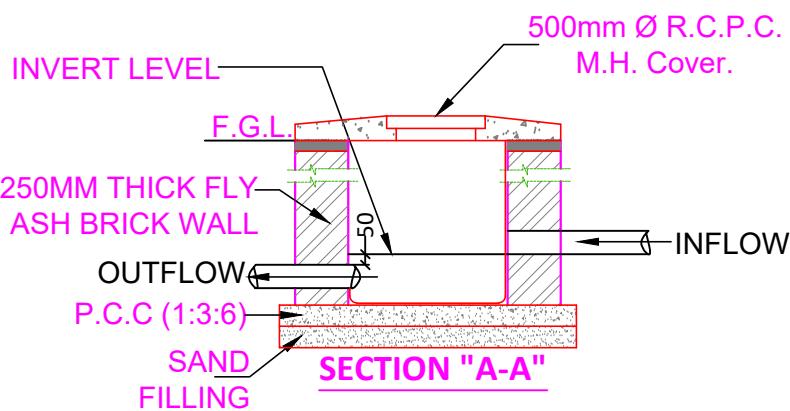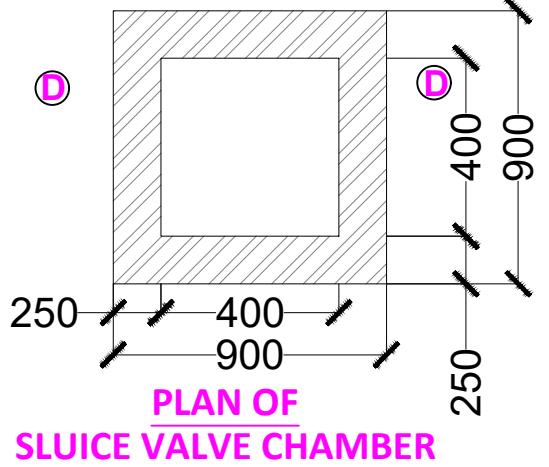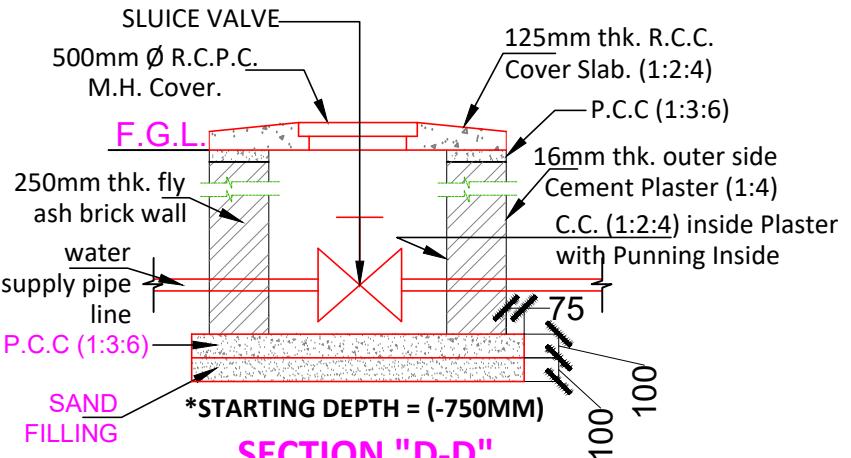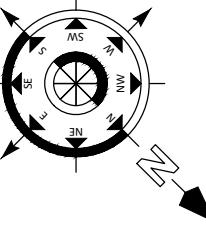

*** STARTING DEPTH = (-750MM)**

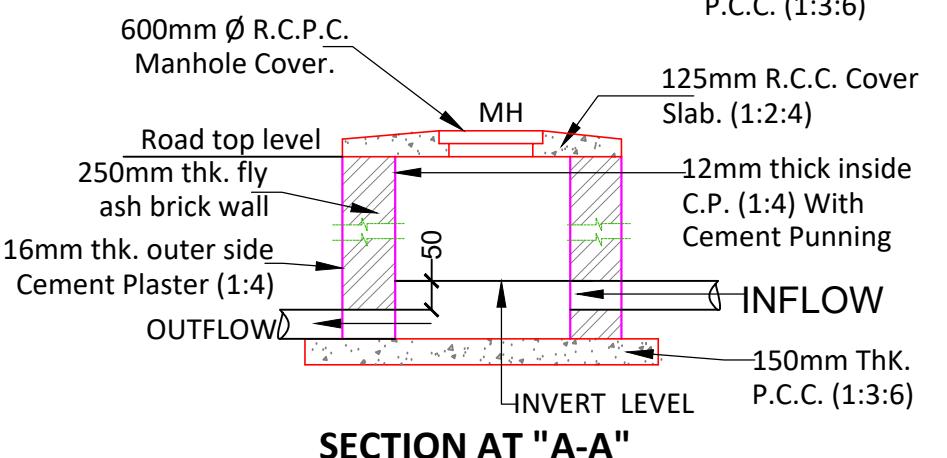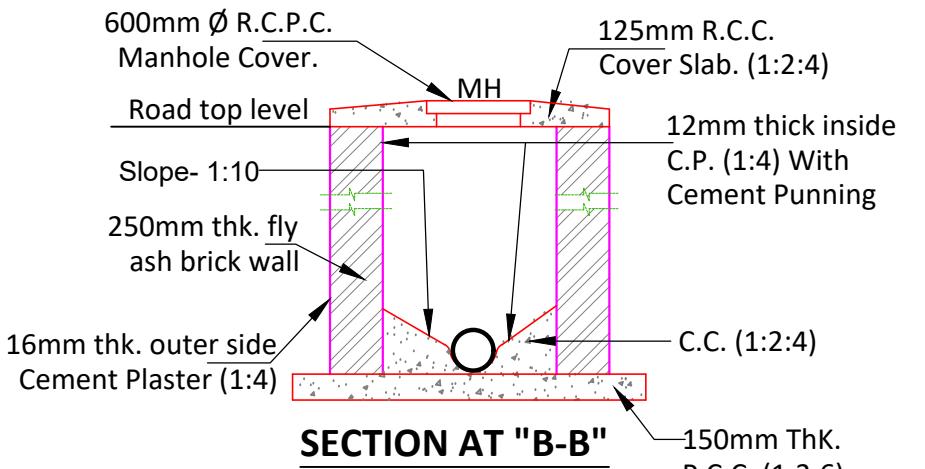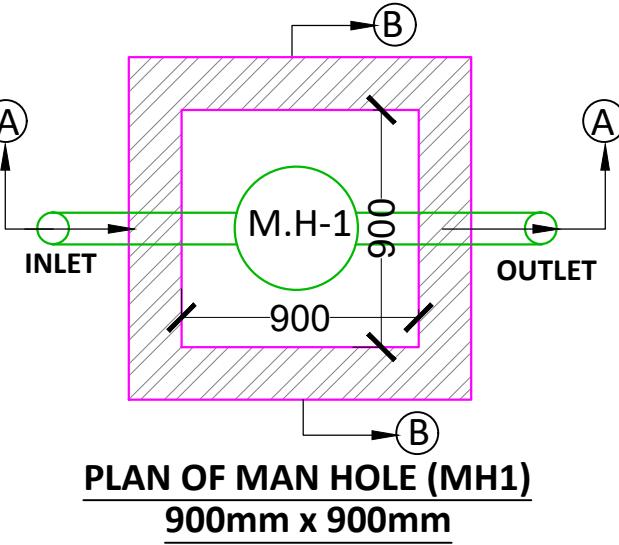

***STARTING DEPTH = (-900MM)**

Note:	
<ul style="list-style-type: none"> ONLY WRITTEN DIMENSION SHOULD BE FOLLOWED. THIS DRAWING SHOULD BE READ IN CONJUNCTION WITH RELEVANT ARCHITECTURAL DRAWINGS AND SITE CONDITIONS. ANY DISCREPANCY IN THE DRAWING SHOULD BE BROUGHT TO THE KNOWLEDGE OF CONSULTANT BEFORE EXECUTION. ALL REINFORCEMENT FOR (G-3) FLOORS ONLY. CLEAR COVER TO MAIN REINFORCEMENT SHALL BE FOR COLUMN - 40MM, PLINTH BEAM - 30MM. FOOTING-50mm, BEAM-25mm, SLAB - 20mm . THE MIX FOR ALL R.C.C. WORK SHALL BE M-20 (1:1.5:3). ALL THE REINFORCEMENT SHALL BE Fe-500(HSD BARS). MINIMUM DEVELOPMENT LENGTH FOR TOR STEEL SHALL BE 50d, WHERE 'd' IS DIA OF MAIN REINFORCEMENT. THE LAP SHALL BE STAGGERED AND AVOIDED AT THE POINT OF MAXIMUM BENDING MOMENT. ALL DIMENSION & LEVEL ARE IN FEET-INCH. 	
SIGNATURE :-	
DRAWN:-	AR. DHANESHWARI
DESIGN:-	ER. PABITRA
PROJECT TITLE:-	
K.I.P SOUMYA	
STATUS:	
ISSUED FOR CONSTRUCTION	
DATE:	07-05-2022
SCALE	NTS
DWG NO:	52
DRAWING TITLE:-	
CHAMBER DETAILING DRAWING	
 APS DESIGN INFRA PVT. LTD # B/48, BDA DUPLEX COLONY BARMUNDA Bhubaneswar, Pin- 751003 8 6 5 8 6 7 7 4 2 5 info@apsdesigninfra.com www.apsdesigninfra.com	
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HANOVER LETTER

To

M/S KUSHMANA INFRA PROJECTS

Ref : FK/HL/22/04/55

Kind Attn :

Subject: Regarding Handover of Project and subsequent related documentation.

Dear Sir,

Reference to the above, we hereby would like to inform with great pleasure that we have completed the design the residential apartment at BHUBANESWAR, Odisha on dated- 07-05-2022 . The work has come up very well and validation of the project has been well within the guidelines prescribed as you might have observed.

We would like to take this opportunity to thank you upfront for your kind support during the project duration and your valuable suggestions had indeed helped us to gain the shape of the project.

We hereby would like to handover the facility to you through this formal letter. Request your kind acknowledgement of this letter to proceed with further documentation and reference.

Authorized Signatory

With Regards

Team Floorkart.in

Signature of client